

DRAWING NUMBER	DRAWING DESCRIPTION
WASTE PACKAGE HANDLING SYSTEM	
H333000-WP401-05-030-0001	GROUP A - BIN TYPE WASTE - WASTE PACKAGE HANDLING METHODS PACKAGE FLOW DIAGRAMS
H333000-WP401-05-030-0002	GROUP B - HEAVY NON-FORKLIFT - WASTE PACKAGE HANDLING METHODS - PACKAGE FLOW DIAGRAMS
H333000-WP401-05-030-0003	GROUP C - LIGHT ILW - WASTE PACKAGE HANDLING METHODS - PACKAGE FLOW DIAGRAMS
H333000-WP401-05-030-0004	GROUP E - FRESH RESIN LINER - WASTE PACKAGE HANDLING METHODS - PACKAGE FLOW DIAGRAMS
H333000-WP401-05-030-0005	GROUP F - HEAVY FORKLIFTABLE - WASTE PACKAGE HANDLING METHODS - PACKAGE FLOW DIAGRAMS
H333000-WP401-35-042-0001	SACRIFICIAL PALLET - UNSHIELDED RESIN LINERS
H333000-WP401-35-042-0002	SACRIFICIAL PALLET - RESIN LINER SHELLS FROM QUADRICELLS
H333000-WP401-35-042-0003	SACRIFICIAL PALLET - TILE HOLE LINERS
H333000-WP401-35-042-0004	SUPPORT FRAME - BRUCE B STEAM GENERATOR SEGMENT
H333000-WP401-50-042-0001	T-H-E HANDLING CONCEPT STORY BOARD - GENERAL ARRANGEMENT
OPERATIONAL SAFETY & MONITORING SYSTEMS	
H333000-WP402-05-042-0001	UNDERGROUND PERMANENT REFUGE STATIONS - GENERAL ARRANGEMENT
H333000-WP402-75-042-0001	OPERATIONAL SAFETY SYSTEMS - VENTILATION SYSTEM - UNDERGROUND - AIR QUALITY MONITORING SYSTEM - GA
SURFACE FACILITIES	
H333000-WP403-10-042-0001	SHAFT SERVICE FACILITY AREA (SSFA) OPERATIONS LAYOUT - GENERAL ARRANGEMENT
H333000-WP403-10-042-0002	SHAFT SERVICE FACILITY AREA (SSFA) CONSTRUCTION LAYOUT - GENERAL ARRANGEMENT
H333000-WP403-10-042-0003	SHAFT SERVICE FACILITY AREA (SSFA) SURFACE FACILITIES - CROSSING OF RAILWAY AND DITCHES TO WWMF
WASTE ROCK DISPOSAL AREA	
H333000-WP404-10-042-0001	WASTE ROCK MANAGEMENT AREA - SITE GRADING AND DRAINAGE
H333000-WP404-10-042-0002	WASTE ROCK MANAGEMENT AREA - STORMWATER MANAGEMENT POND
H333000-WP404-10-042-0003	WASTE ROCK MANAGEMENT AREA - BASE CASE
H333000-WP404-10-042-0005	WASTE ROCK MANAGEMENT AREA - NORTH-WEST AND SOUTH EAST - PERIMETER DITCH
SHAFT HOISTING SYSTEMS	
H333000-WP405-20-042-0003-02	MAIN SHAFT - PERMANENT CONDITION - SINGLE DECK MAIN CAGE - KOEPE HOIST - OPTION 2 - GENERAL ARRANGEMENT
H333000-WP405-20-042-0004	MAIN SHAFT - PERMANENT CONDITION - MAIN SHAFT KOEPE COUNTERWEIGHT GENERAL ARRANGEMENT
H333000-WP405-20-042-0005	MAIN SHAFT - PERMANENT CONDITION - AUXILIARY 2 DECK CAGE - GENERAL ARRANGEMENT
H333000-WP405-20-042-0010	MAIN SHAFT - HOIST HOUSES - SINKING CONDITION - LAYOUT
H333000-WP405-20-042-0014	VENTILATION SHAFT - PERMANENT CONDITION 9.3 TONNE SKIP GENERAL ARRANGEMENT
H333000-WP405-20-042-0015	VENTILATION SHAFT - LATERAL DEVELOPMENT BALE AND REMOVABLE SKIP GENERAL ARRANGEMENT
H333000-WP405-20-042-0016	VENTILATION SHAFT - LATERAL DEVELOPMENT BALE AND REMOVABLE SKIP GENERAL ARRANGEMENT
H333000-WP405-35-042-0001	MAIN SHAFT - PERMANENT CONDITION - AUXILIARY - COUNTERWEIGHT - GENERAL ARRANGEMENT
SHAFT HEADFRAMES	
H333000-WP406-20-042-0001	MAIN SHAFT CONCRETE HEADFRAME - GENERAL ARRANGEMENT
H333000-WP406-20-042-0002	MAIN SHAFT CONCRETE HEADFRAME - FLOOR PLANS
H333000-WP406-20-042-0003	MAIN SHAFT - HEADFRAME - SINKING CONDITION - GENERAL ARRANGEMENT
H333000-WP406-20-042-0005	WASTE PACKAGE RECEIVING BUILDING - GENERAL ARRANGEMENT
H333000-WP406-20-042-0006	VENTILATION SHAFT STEEL HEADFRAME - GENERAL ARRANGEMENT
H333000-WP406-20-042-0008	VENTILATION SHAFT - HEADFRAME - SINKING CONDITION - GENERAL ARRANGEMENT
H333000-WP406-20-042-0010	VENTILATION SHAFT COLLAR HOUSE - GENERAL ARRANGEMENT
SHAFTS	
H333000-WP407-20-042-0001	MAIN SHAFT - PRELIMINARY SHAFT SECTION - GENERAL ARRANGEMENT
H333000-WP407-20-042-0002	VENTILATION SHAFT - PRELIMINARY SHAFT SECTION - GENERAL ARRANGEMENT
H333000-WP407-20-042-0005	VENTILATION SHAFT - LOADING POCKET AND SHAFT BOTTOM - GENERAL ARRANGEMENT
H333000-WP407-20-042-0006	MAIN SHAFT PRELIMINARY LONGITUDINAL SECTION GENERAL ARRANGEMENT
H333000-WP407-35-042-0002	VENTILATION SHAFT - DGR LEVEL STATION STEELWORK ARRANGEMENT

DRAWING NUMBER	DRAWING DESCRIPTION
UNDERGROUND FACILITIES	
H333000-WP408-05-042-0001	P1 EMPLACEMENT ROOM - ALLOCATION OF WASTE PACKAGES TO EMPLACEMENT ROOMS
H333000-WP408-05-042-0002	P2 EMPLACEMENT ROOM - ALLOCATION OF WASTE PACKAGES TO EMPLACEMENT ROOMS
H333000-WP408-05-042-0003	P3 EMPLACEMENT ROOM - ALLOCATION OF WASTE PACKAGES TO EMPLACEMENT ROOMS
H333000-WP408-05-042-0004	P4 EMPLACEMENT ROOM - ALLOCATION OF WASTE PACKAGES TO EMPLACEMENT ROOMS
H333000-WP408-05-042-0005	P5 EMPLACEMENT ROOM - ALLOCATION OF WASTE PACKAGES TO EMPLACEMENT ROOMS
H333000-WP408-05-042-0006	P6 EMPLACEMENT ROOM - ALLOCATION OF WASTE PACKAGES TO EMPLACEMENT ROOMS
H333000-WP408-10-042-0001	UNDERGROUND SERVICES SANITARY AND HEALTH PHYSICS GEAR STORAGE - GENERAL ARRANGEMENT
H333000-WP408-20-015-0001	SHAFT BOTTOM RAMP CONCEPT SKETCH
H333000-WP408-20-042-0001	DGR BASE CASE (PLAN VIEW) ENE ORIENTATION - GENERAL ARRANGEMENT
H333000-WP408-20-042-0002	DGR POTENTIAL EXPANSION CASE (PLAN VIEW) ENE ORIENTATION - GENERAL ARRANGEMENT
H333000-WP408-20-042-0003	SHAFT & SERVICES AREA (PLAN VIEW - UNDERGROUND) - GENERAL ARRANGEMENT
H333000-WP408-20-042-0005	PANEL 1 WASTE EMPLACEMENT ROOM - PLAN VIEW - GENERAL ARRANGEMENT
H333000-WP408-20-042-0006	PANEL 2 WASTE EMPLACEMENT ROOM - PLAN VIEW - GENERAL ARRANGEMENT
H333000-WP408-20-042-0010	DEVELOPMENT ROCK HANDLING FACILITIES - GENERAL ARRANGEMENT
H333000-WP408-20-042-0017	UNDERGROUND SERVICES - FUEL STORAGE AND REFUELLING BAY - GENERAL ARRANGEMENT
H333000-WP408-20-042-0018	ACCESS TUNNEL DRILL AND BLAST EXCAVATION SEQUENCE PLANS AND SECTIONS
H333000-WP408-20-042-0019	EMPLACEMENT ROOM DRILL AND BLAST EXCAVATION SEQUENCE PLANS AND SECTIONS
H333000-WP408-20-042-0021	EMPLACEMENT ROOM AND ACCESS TUNNEL ROCK SUPPORT CROSS SECTIONS
H333000-WP408-20-042-0021	ACCESS TUNNEL AND EMPLACEMENT ROOM ROCK SUPPORT DETAILS
H333000-WP408-50-042-0001	UNDERGROUND SERVICES - MOBILE EQUIPMENT MAINTENANCE WORKSHOP - GENERAL ARRANGEMENT
H333000-WP408-50-042-0002	UNDERGROUND LUNCH ROOM AND OFFICE AREA GENERAL ARRANGEMENT
UNDERGROUND SERVICES	
H333000-WP409-50-030-0002	DRAINAGE AND DEWATERING SYSTEM PRELIMINARY PROCESS FLOW DIAGRAM
DECOMMISSIONING & CLOSURE	
H333000-WP411-10-042-0001	STRATIGRAPHY AND SHAFT SEALING SYSTEM LAYOUT - GENERAL ARRANGEMENT
H333000-WP411-10-042-0002	SEALING SYSTEM SHAFT SEALING SEQUENCE - CONSTRUCTION SEQUENCE

ABBREVIATIONS & SYMBOLS

B.G.S.	BELOW GROUND SURFACE	F/L	FORK LIFT
A.M.S.L.	ABOVE MEAN SEA LEVEL	*!	CENTERLINE
N	NORTHING	W.P.	WORK POINT
E	EASTING	TYP.	TYPICAL
DGR	DEEP GEOLOGIC REPOSITORY	EXP.	EXPANSION
WWMF	WESTERN WASTE MANAGEMENT FACILITY	NTS	NOT TO SCALE
AZI	AZIMUTH	DWG	DRAWING
G	GANTRY	DPG	DOUGLAS POINT GRID

NOTE:
ALL DIMENSIONS ARE IN MM UNLESS NOTED OTHERWISE

PRELIMINARY
NOT FOR CONSTRUCTION

THIS DRAWING IS FOR ESTIMATING USE ONLY
All ratings and sizes of equipment, concrete, steel, and materials, shown on this drawing are approximations only and must not be considered as final design requirements.
DO NOT USE FOR CONSTRUCTION

		DESIGNED BY S. AARONS DATE 12/01/2010		DRAWN BY A. SHAW DATE 12/01/2010		NUCLEAR WASTE MANAGEMENT ORGANIZATION DEEP GEOLOGIC REPOSITORY PROJECT	
		CHECKED BY G. KRAMER DATE 12/01/2010		DISCIP. ENGR. G. KRAMER DATE 12/01/2010		PRELIMINARY DESIGN REPORT	
DATE 00 APPROVED FOR USE GK SA 04/26/2011		PROJ. DES. COORD. N/A		PROJ. ENGR. N/A		APPENDIX E - VOLUME 1 INDEX OF DRAWINGS GENERAL NOTES AND SYMBOLS	
REV. ISSUE FOR AUTH. BY DATE		PROJ. MGR. M. DAWBORN DATE 12/01/2010		SCALE OR AS NOTED		DWG. NO. H333000-WP700-00-042-0001	
REFERENCE DRAWINGS		REVISIONS		ISSUE AUTHORIZATION		REV. 01	

H333000-WP401-05-030-0001
ON DMG

Receiving Bay

Waste Package Receiving Building

Package Staging Area

A

A

B

B

C

C

D


D

E

E

F

F

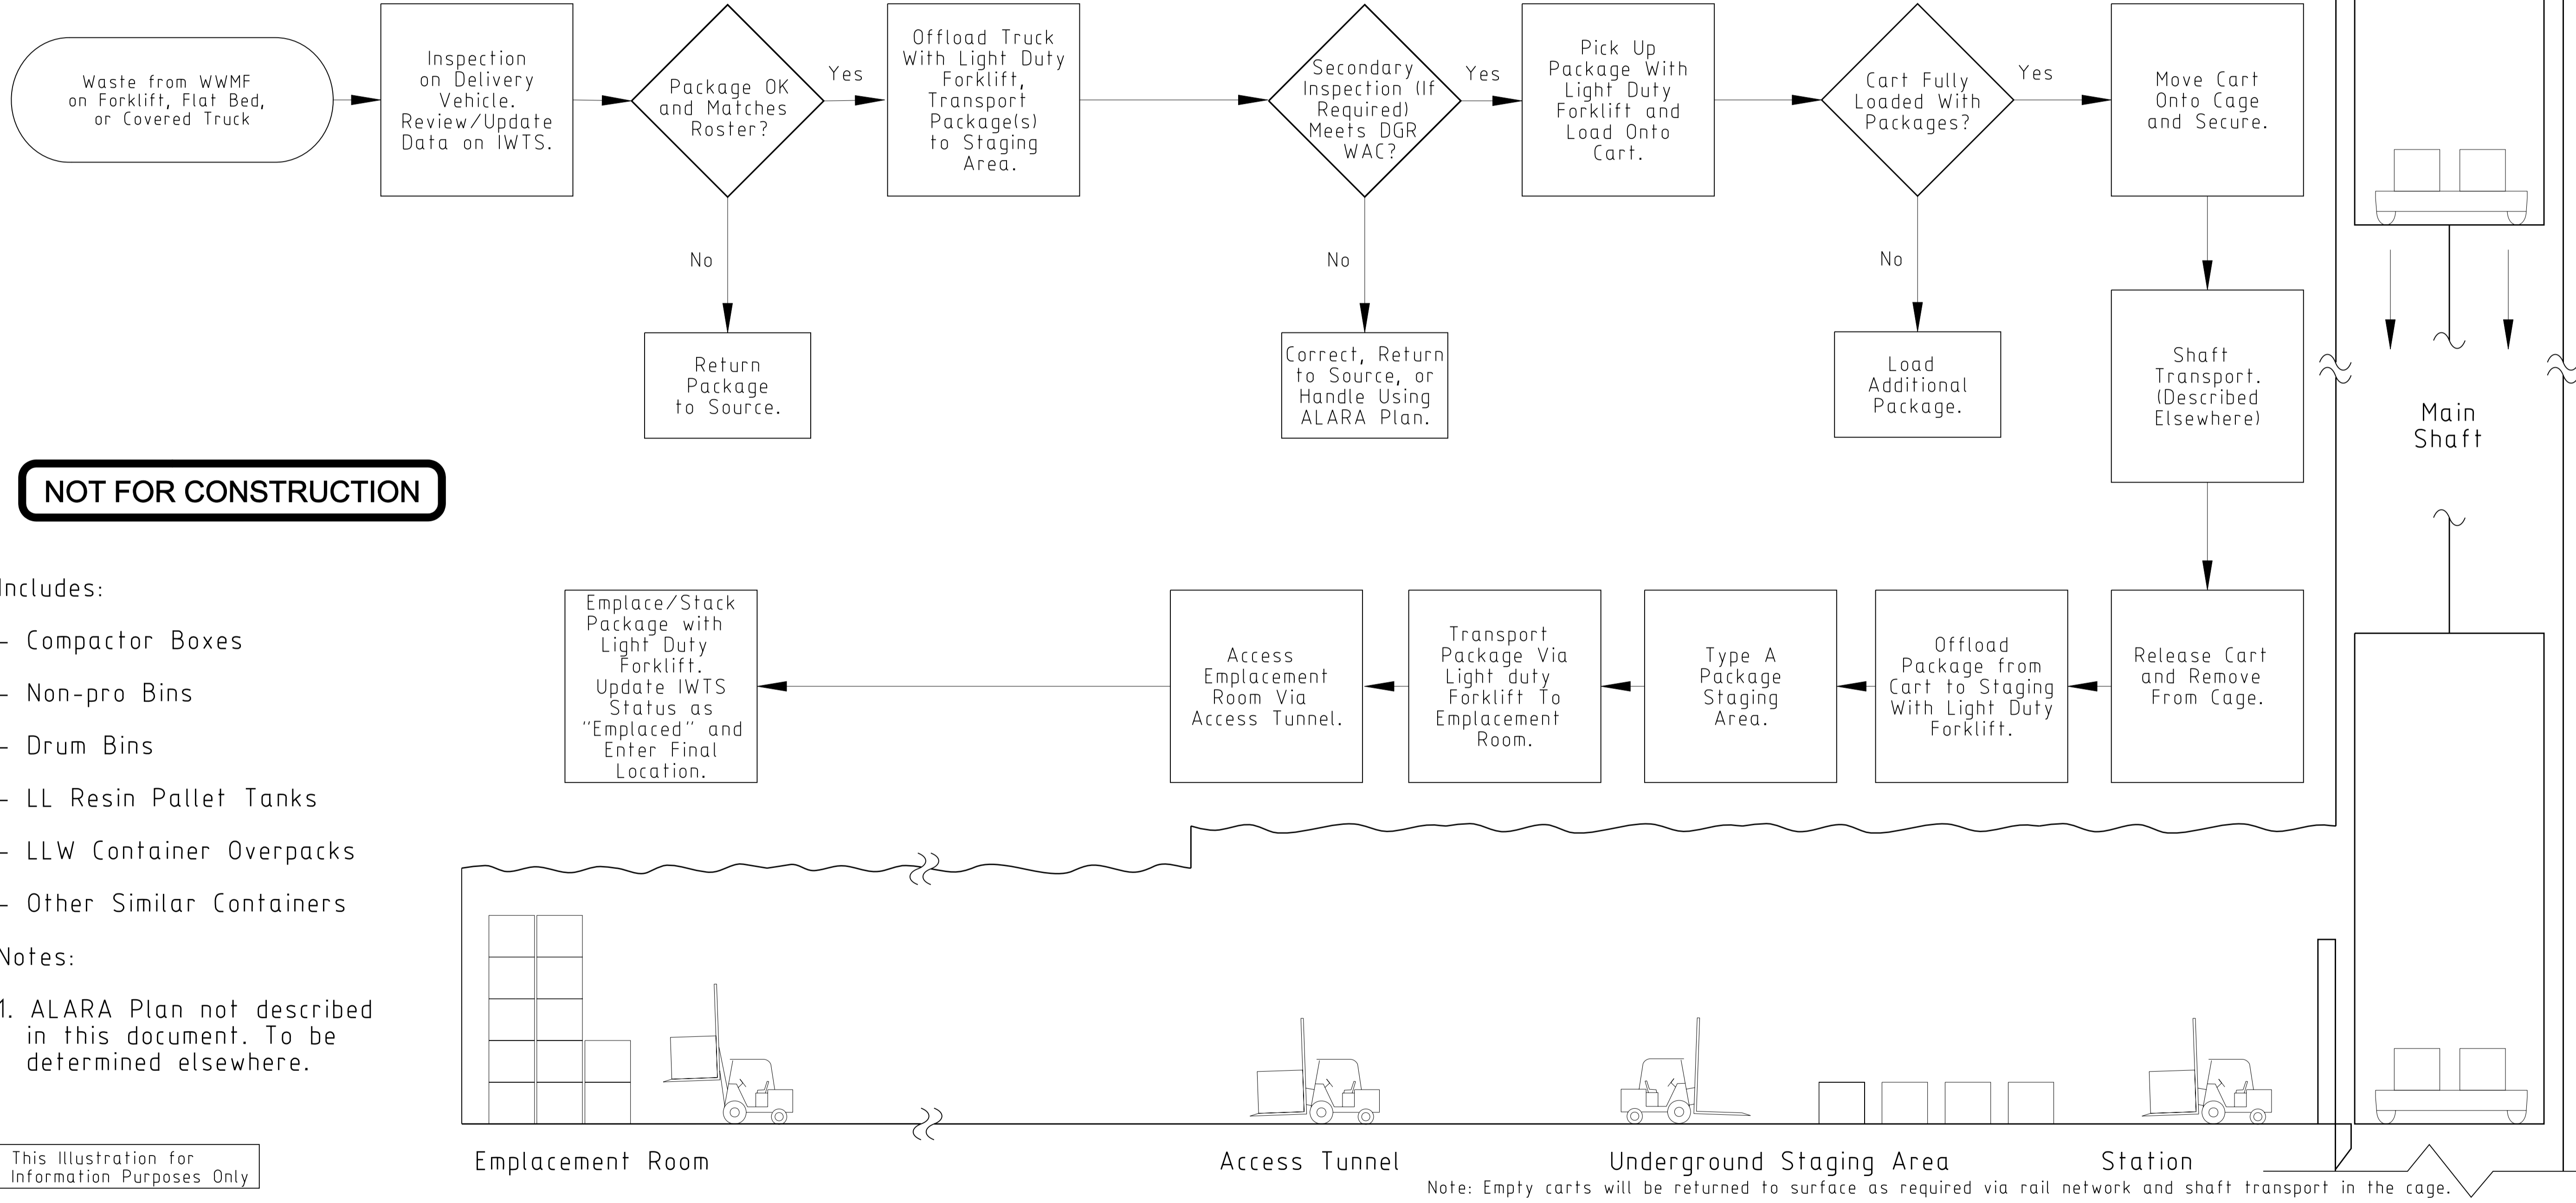

NOT FOR CONSTRUCTION

Includes:

- Compactor Boxes
- Non-pro Bins
- Drum Bins
- LL Resin Pallet Tanks
- LLW Container Overpacks
- Other Similar Containers

Notes:

1. ALARA Plan not described in this document. To be determined elsewhere.

This Illustration for Information Purposes Only

Emplacement Room

Access Tunnel

Underground Staging Area

Station

Note: Empty carts will be returned to surface as required via rail network and shaft transport in the cage.



REFERENCE DRAWINGS 1 2		REVISIONS NO. DESCRIPTION CHK'D APP'D DATE		NOT FOR CONSTRUCTION This drawing has been reviewed for the purposes of DGR Preliminary Engineering only and must not be used for other purposes. Work Package Owner <i>[Signature]</i> Area Lead <i>G.R. Davy</i> Engineering Manager Project Manager Accepted by Owner R.J. Heyster 2009.09.24 19:11:50 04/07		HATCH DESIGNED BY: D. WITOW DATE: 2009-09-15 CHECKED BY: DATE: PROJ. DES. COORD. DATE: PROJ. MGR.: M. R. DAWBORN DATE:		DRAWN BY: R. SETO DATE: 2009-09-15 DISCIPLINE: ENGR. DATE: PROJ. ENGR. DATE:		NUCLEAR WASTE MANAGEMENT ORGANIZATION DEEP GEOLOGIC REPOSITORY PROJECT GROUP A - BIN TYPE WASTE WASTE PACKAGE HANDLING METHODS PACKAGE FLOW DIAGRAM SCALE: N.T.S. OR AS NOTED DWG. NO. H333000-WP401-05-030-0001 REV. 00	
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Receiving Bay

Waste Package Receiving Building


Package Staging Area



NOT FOR CONSTRUCTION

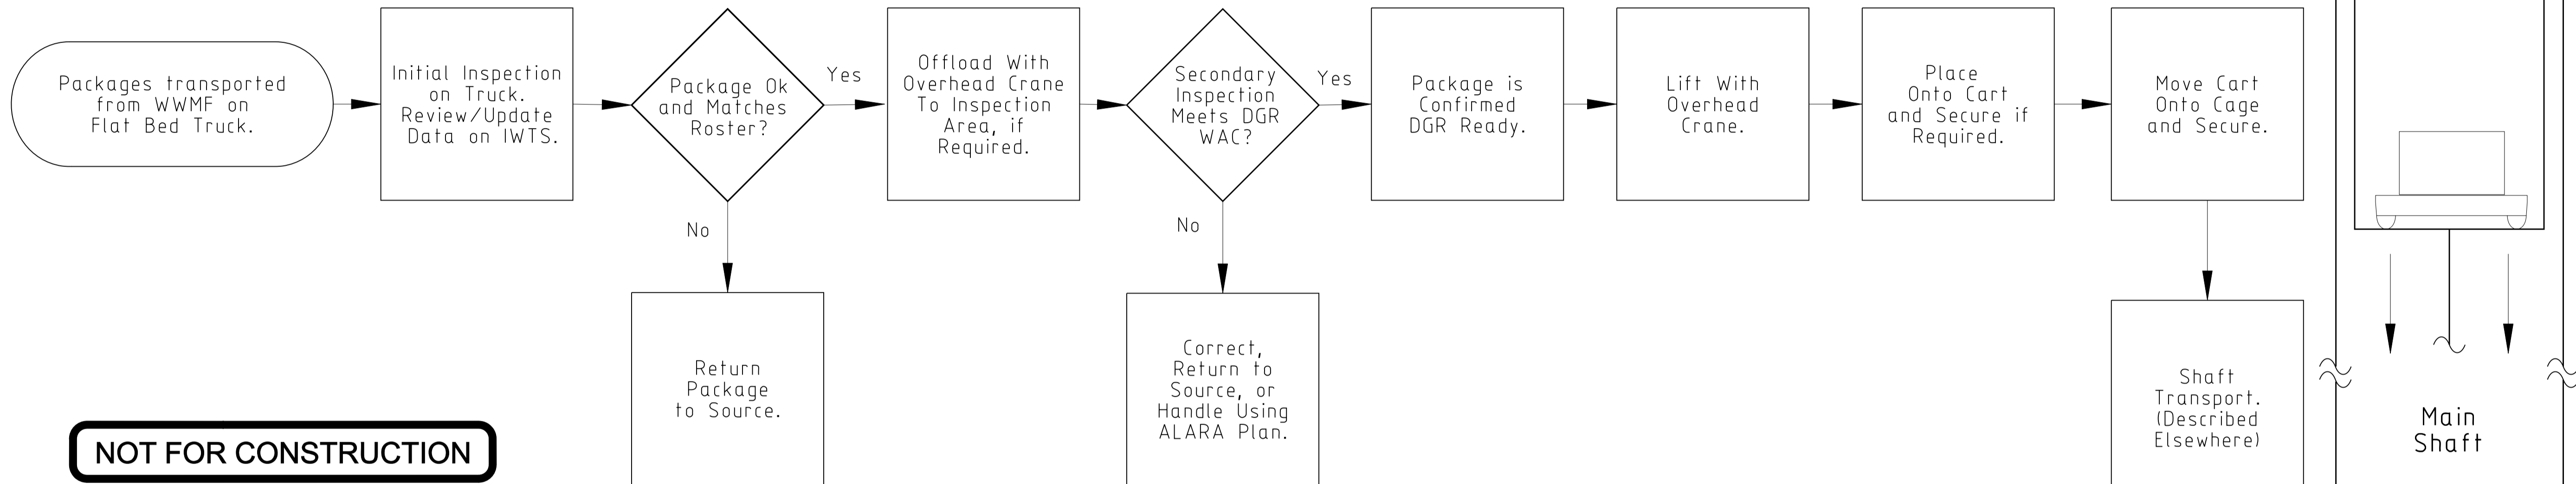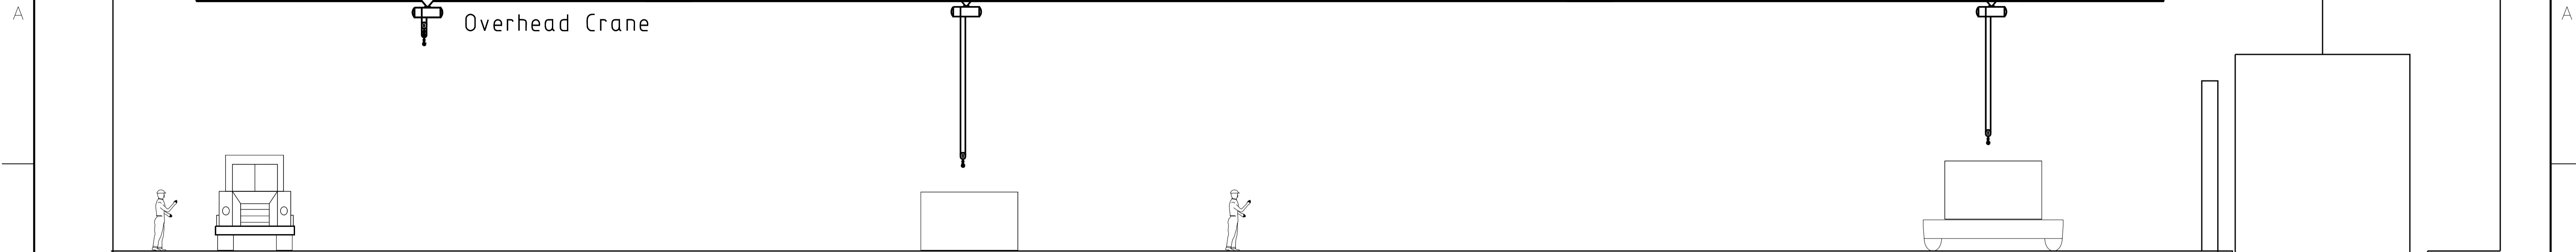
Includes:

- Shield Plug containers
- Heat Exchangers

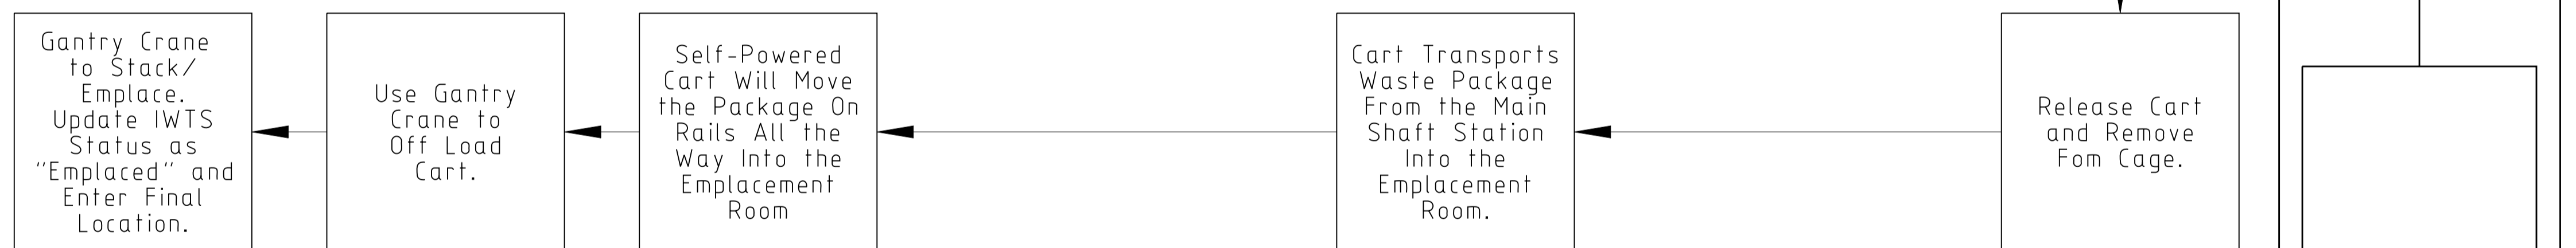

Notes:

1. ALARA Plan not described in this document. To be determined elsewhere.

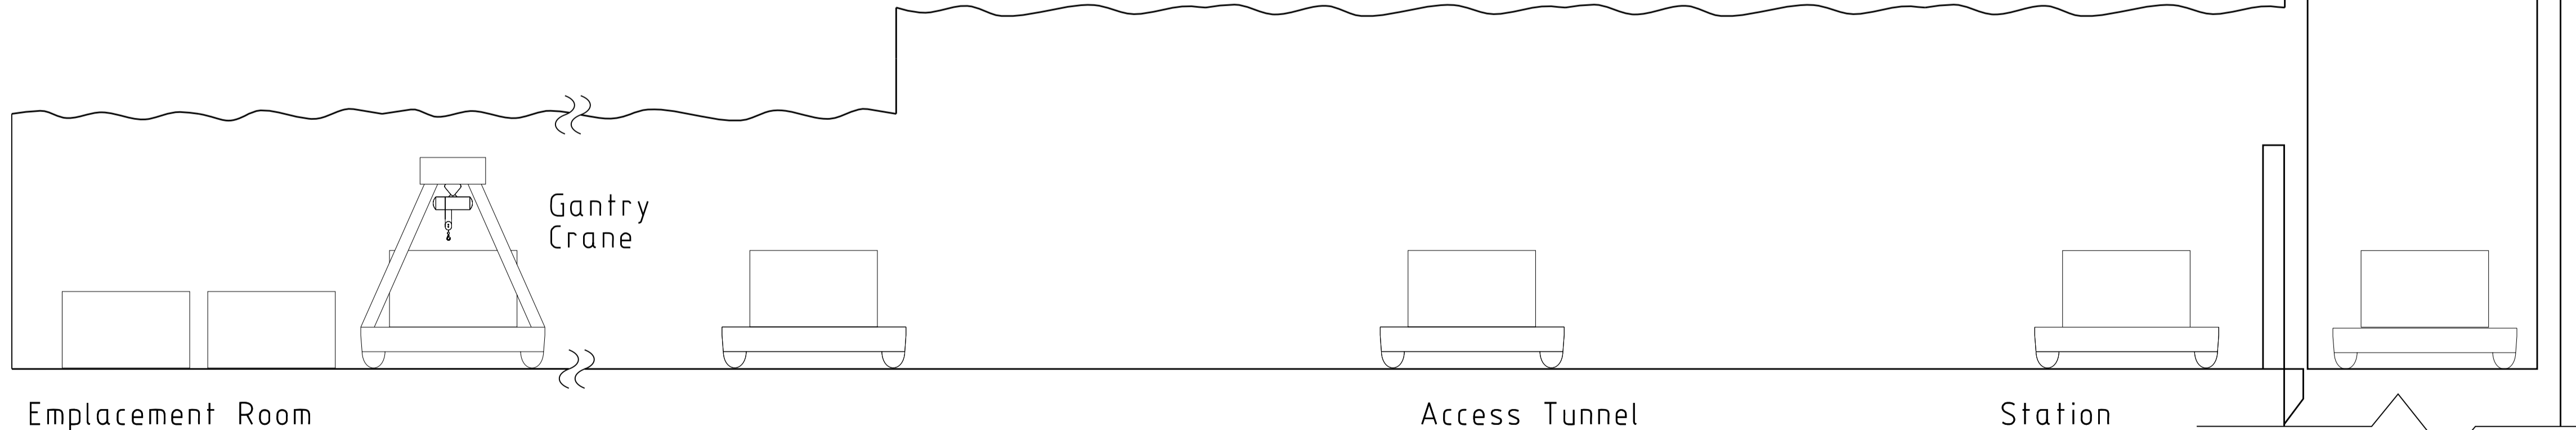

This Illustration for Information Purposes Only

Emplacement Room

Access Tunnel



Station

Note: Empty carts will be returned to surface as required via rail network and shaft transport in the cage.

<p>DESIGNED BY D. WITOW DATE 2009-09-15</p>		<p>DRAWN BY R. SETO DATE 2009-09-15</p>		<p>DISCIPLINE ENGR.</p>		<p>SCALE N.T.S. OR AS NOTED</p>		<p>DWG. NO. H333000-WP401-05-030-0002</p>		<p>REV. 00</p>	
<p>DATE PROJ. DES. COORD.</p>		<p>DATE PROJ. ENGR.</p>		<p>DATE PROJ. MGR.</p>		<p>DATE M. R. DAWBORN</p>		<p>GROUP B - HEAVY NON-FORKLIFT</p>		<p>WASTE PACKAGE HANDLING METHODS PACKAGE FLOW DIAGRAM</p>	
<p>00 APPROVED FOR USE</p>		<p>GRD SAA</p>		<p>2009-09-15</p>		<p>ISSUE AUTHORIZATION</p>		<p>REVISIONS</p>		<p>NOT FOR CONSTRUCTION This drawing has been reviewed for the purposes of DGR Preliminary Engineering only and must not be used for other purposes. Work Package Owner <i>D. Witow</i> Area Lead Digitally signed by G.R. Davidge Date: 2009.09.15 16:25:53 -0400 Engineering Manager Sherwin Adams 2009.09.16 19:22:14 -0400 Project Manager Digitally signed by M.R. Dawborn Date: 2009.09.17 11:18:29 -0400 Accepted by Owner R.J. Heyslee 2009.09.24 19:12:38 -0400</p>	
<p>DRAWING NO.</p>		<p>DRAWING TITLE</p>		<p>NO.</p>		<p>DESCRIPTION</p>		<p>CHK'D</p>		<p>APP'D</p>	
<p>REFERENCE DRAWINGS</p>		<p>NO.</p>		<p>DESCRIPTION</p>		<p>CHK'D</p>		<p>APP'D</p>		<p>DATE</p>	

Waste Package Receiving Building

Package Staging Area

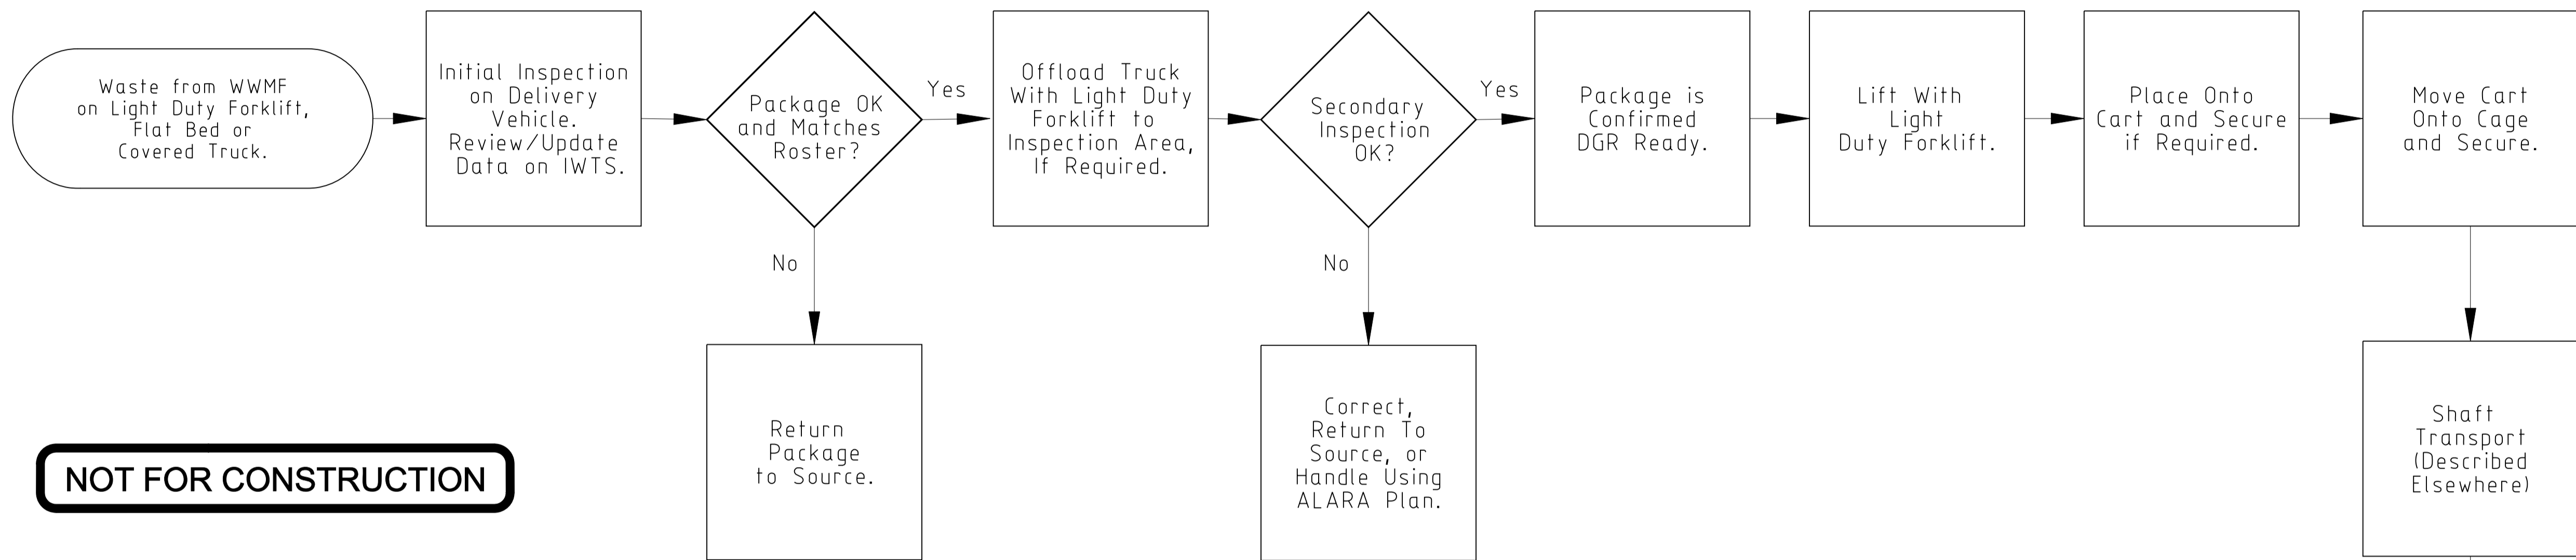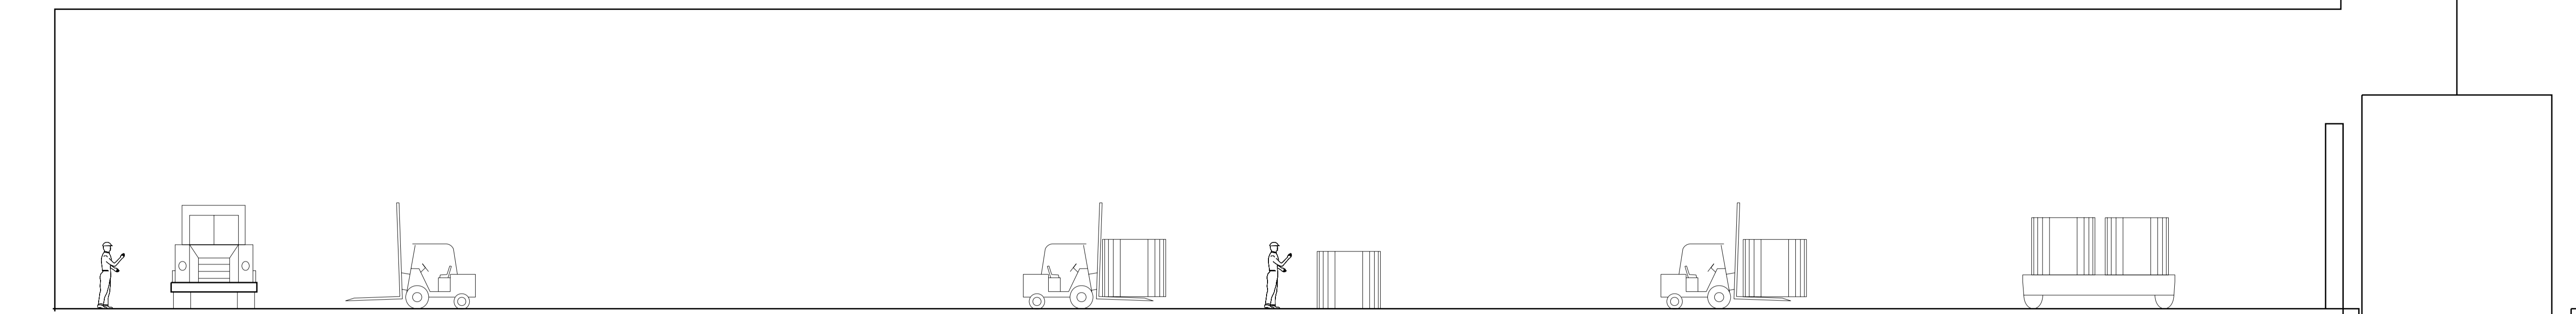


NOT FOR CONSTRUCTION

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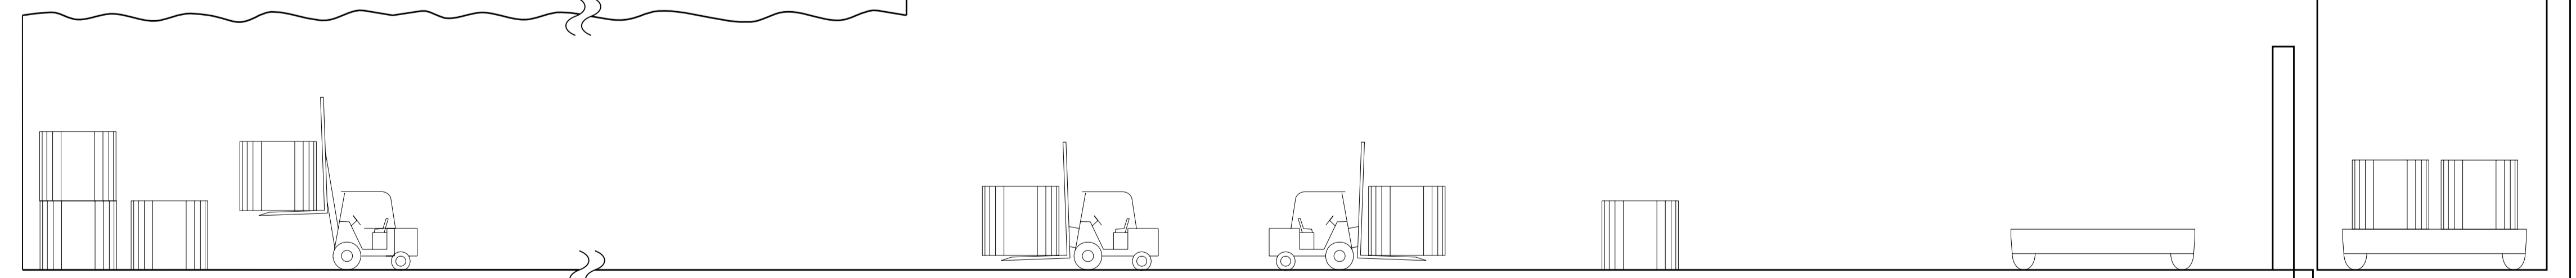
- Unshielded Resin Liners From WWMF on Sacrificial Pallets
- Resin Liners in SS Overpacks On Sacrificial Pallets
- Tile Hole Liners On Sacrificial racks
- ILW Shield

Emplace/Stack Package with Light Duty Forklift. Update IWTS Status as "Emplaced" and Enter Final Location.

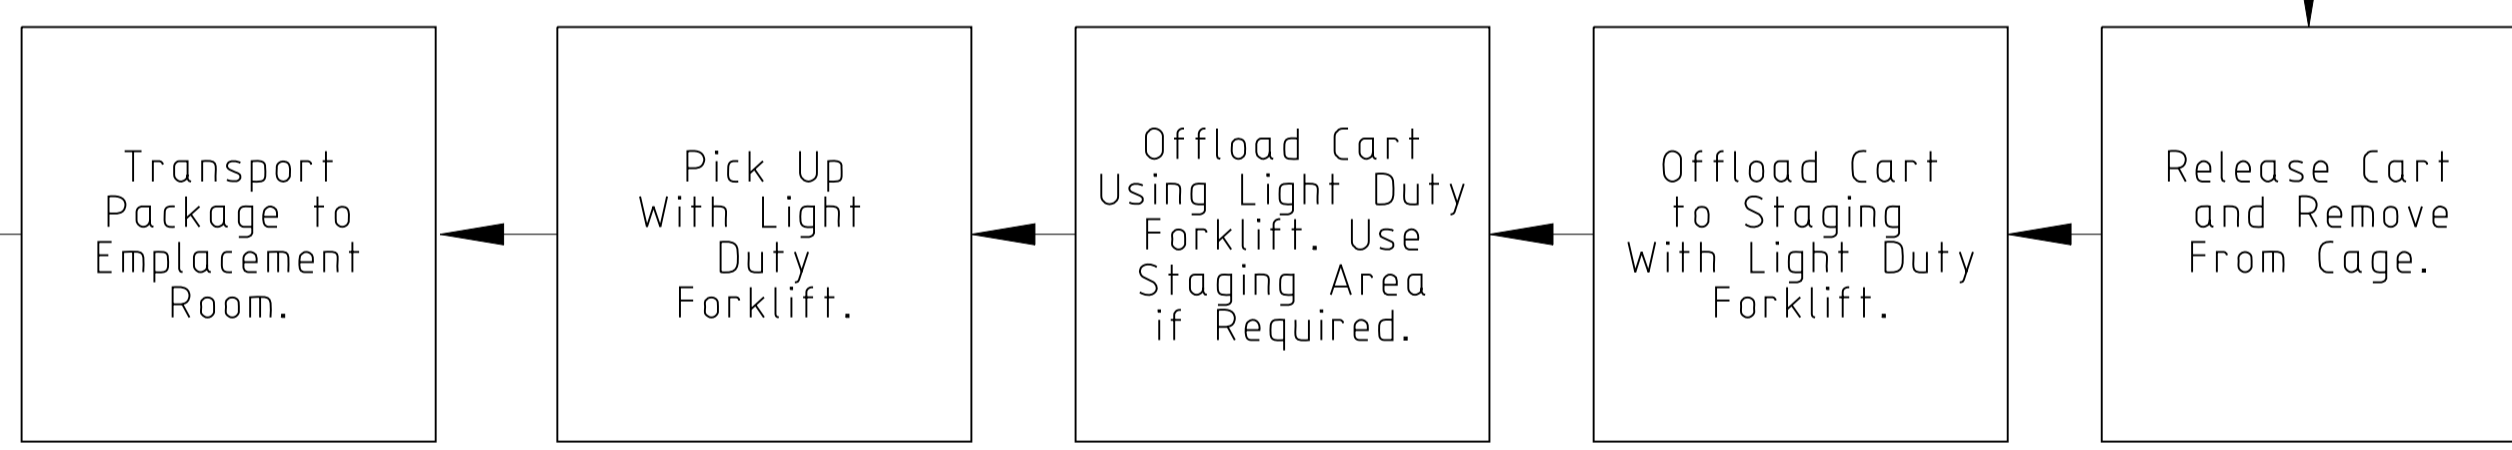

Notes:

1. ALARA Plan not described in this document. To be determined elsewhere.



This Illustration for Information Purposes Only

Emplacement Room

Access Tunnel

Underground Staging Area

Station

Note: Empty carts will be returned to surface as required via rail network and shaft transport in the cage.

DRAWING NO.		DRAWING TITLE		NO.		DESCRIPTION		CHK'D	APP'D	DATE	<p>NOT FOR CONSTRUCTION This drawing has been reviewed for the purposes of DGR Preliminary Engineering only and must not be used for other purposes. Work Package Owner <i>[Signature]</i> Area Lead G.R. Davidge Digitally signed by G.R. Davidge Date: 2009.09.15 16:27:30 -0400 Engineering Manager Sherwin Azevedo Digitally signed by M.R. Dawborn Date: 2009.09.24 19:13:15 -0400 Accepted by Owner R.J. Heystee Date: 2009.09.24 19:13:15 -0400</p>		<p>HATCH</p> DESIGNED BY D. WITOW DATE 2009-09-15 CHECKED BY G. DAVIDGE DATE PROJ. DES. COORD. DATE DRAWN BY R. SETO DATE 2009-09-15 DISCIPL. ENGR. DATE PROJ. ENGR. DATE PROJ. MGR. M. R. DAWBORN DATE		NUCLEAR WASTE MANAGEMENT ORGANIZATION DEEP GEOLOGIC REPOSITORY PROJECT GROUP C - LIGHT ILW WASTE PACKAGE HANDLING METHODS PACKAGE FLOW DIAGRAM		SCALE N.T.S. OR AS NOTED	DWG. NO. H333000-WP401-05-030-0003	REV. 00
REFERENCE DRAWINGS		REVISIONS		ISSUE AUTHORIZATION															

Receiving Bay

Waste Package Receiving Building

Staging Area for Partially Filled Resin Liner Shields

Overhead Crane

A

B


C

D

E

F

Package Transported From Nuclear Station On Flat Bed Truck, Using "Trillium Cask" or Equivalent. Initial Entry of New Package into IWTS.

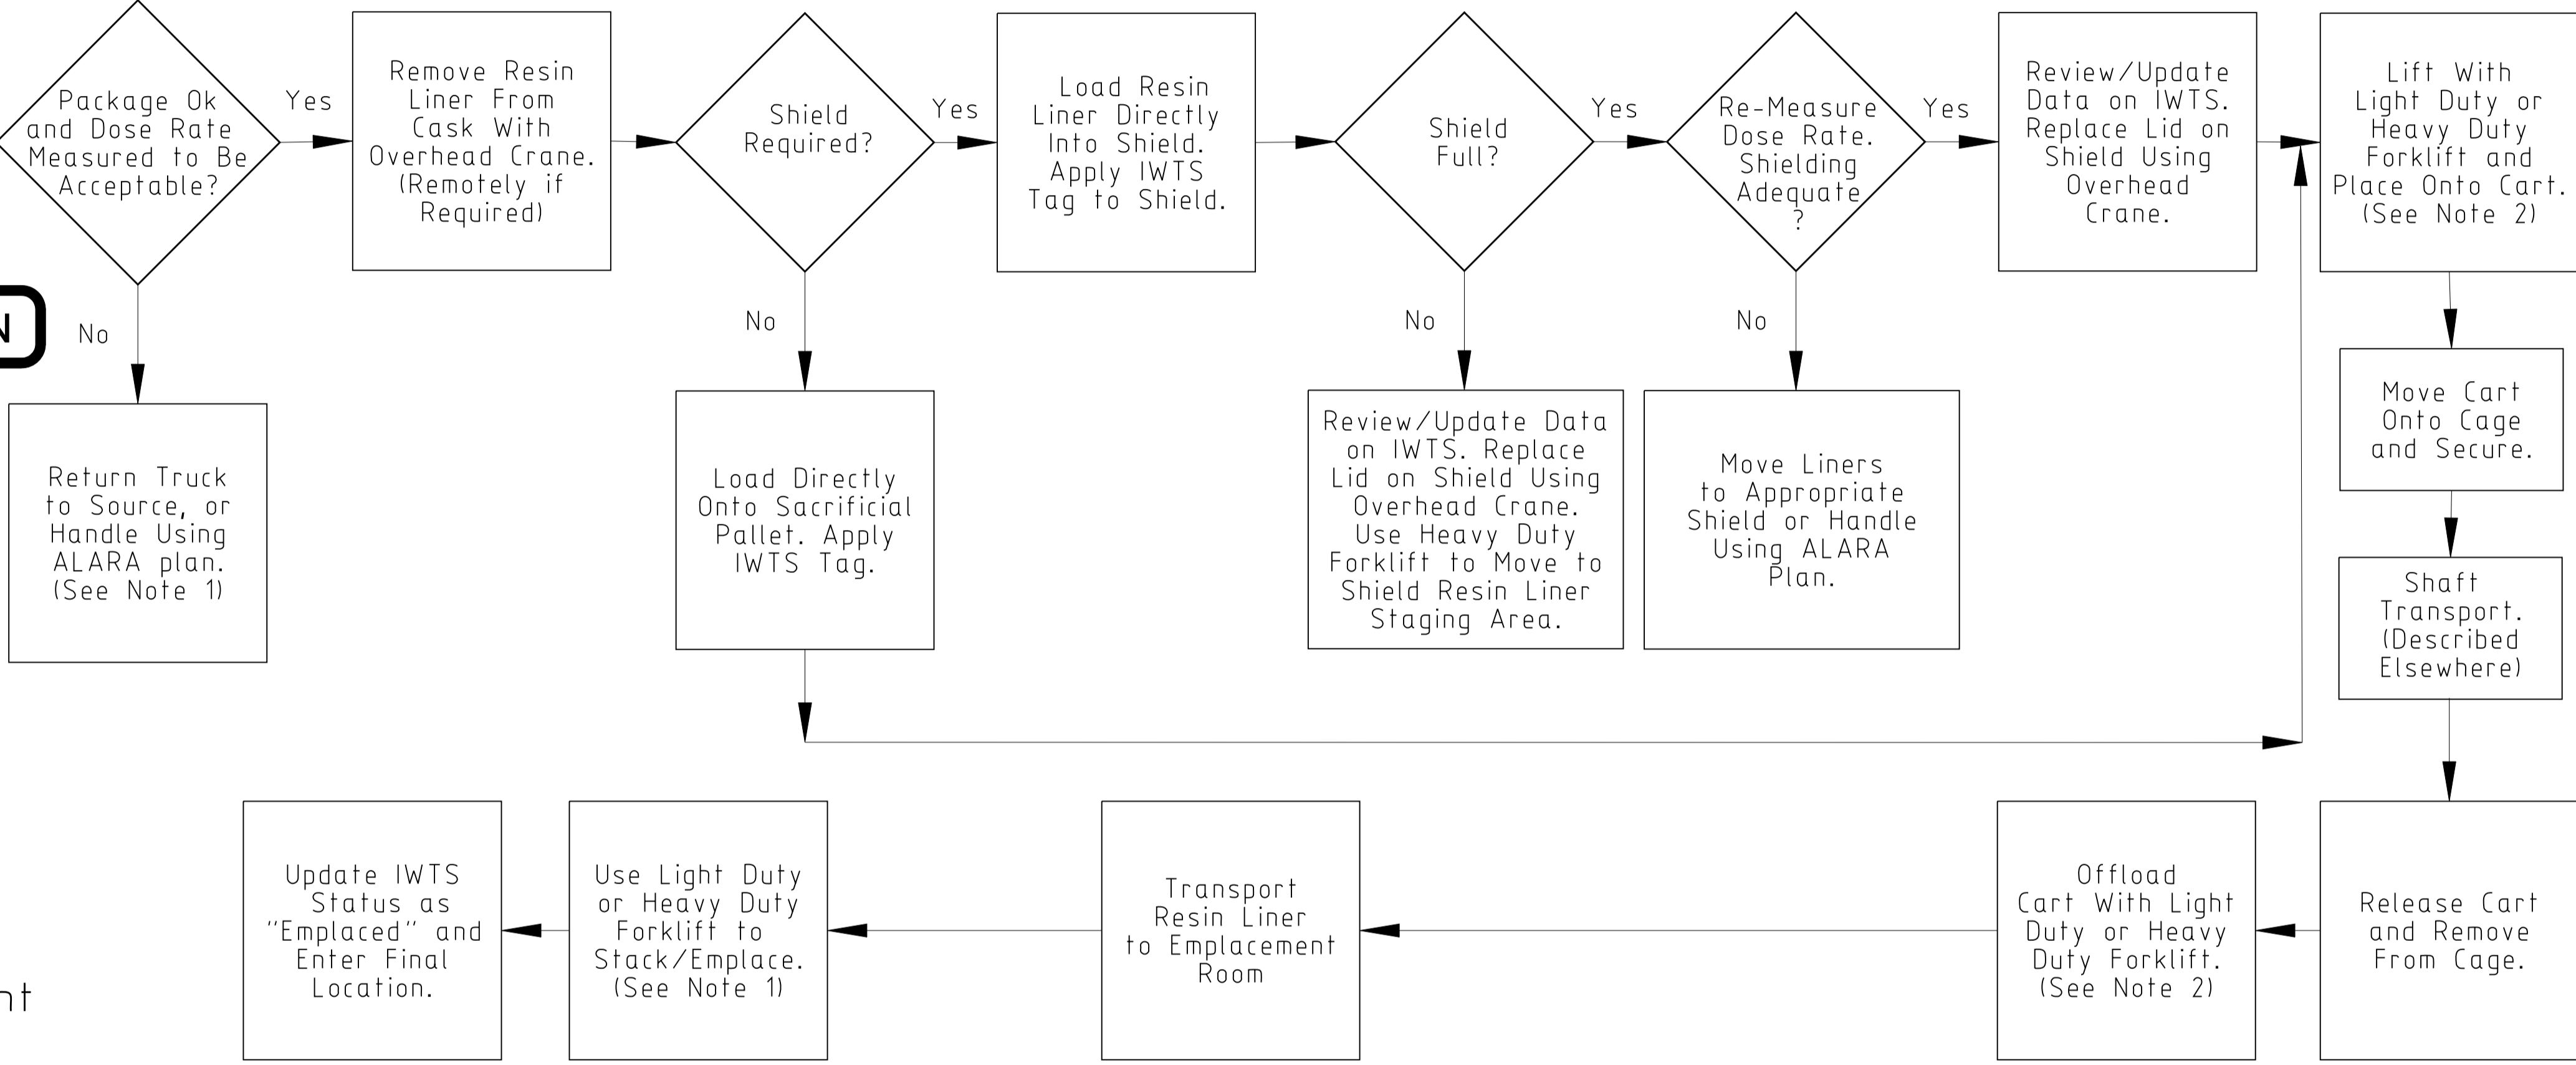

NOT FOR CONSTRUCTION

Includes:

- Fresh Resin Liners Arriving Directly from Nuclear Stations

Notes:

1. Handling may include transfer to Emplacement Room or to WWMF to allow Decay.
2. Unshielded Liners move with Light Duty Forklift. Shielded Liners move with Heavy Duty Forklift.
3. ALARA Plan not described in this document. To be determined elsewhere.

This Illustration for Information Purposes Only

Emplacement Room

Access Tunnel

Station



Note: Empty carts will be returned to surface as required via rail network and shaft transport in the cage.

<p>DESIGNED BY: D. WITOW DATE: 2009-09-15 CHECKED BY: [Signature]</p>		<p>DRAWN BY: R. SETO DATE: 2009-09-15 DISCIPLINE: ENGR.</p>		<p>DATE: [Blank] PROJ. DES. COORD. DATE: [Blank]</p>		<p>DATE: [Blank] PROJ. ENGR. DATE: [Blank]</p>		<p>SCALE: N.T.S. OR AS NOTED</p>		<p>DWG. NO. H333000-WP401-05-030-0004</p>		<p>REV. 00</p>
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Receiving Bay

Waste Package Receiving Building

Package Staging Area

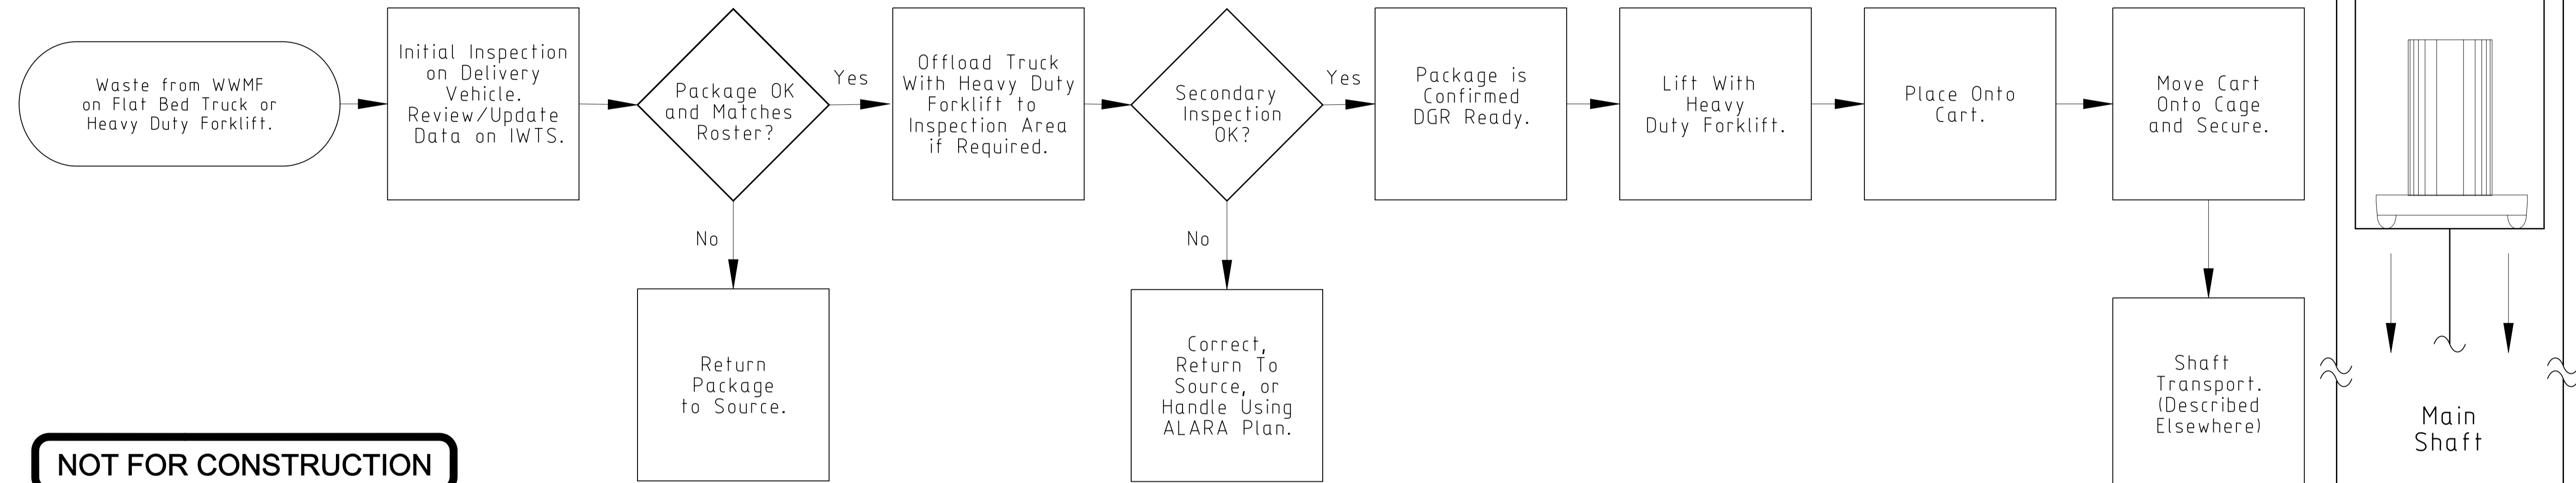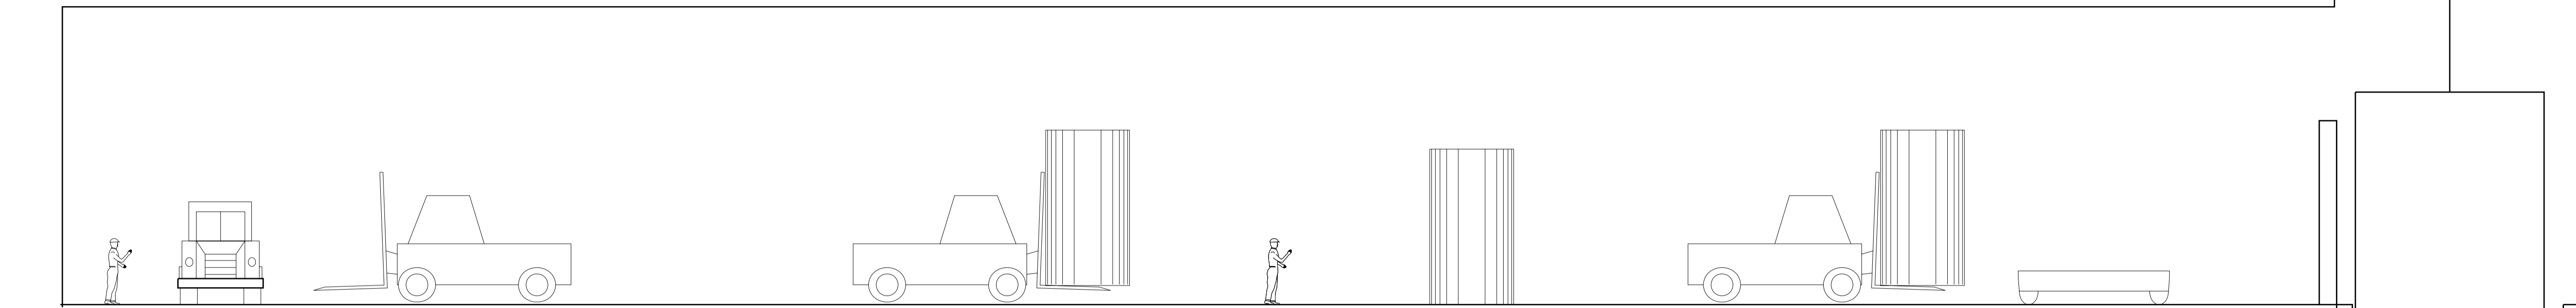


NOT FOR CONSTRUCTION

Includes:

- Encapsulated tile Holes
- Resin Liner Shields 1, 2, 3
- Retube Waste Container
- Steam Generator Segments

Notes:


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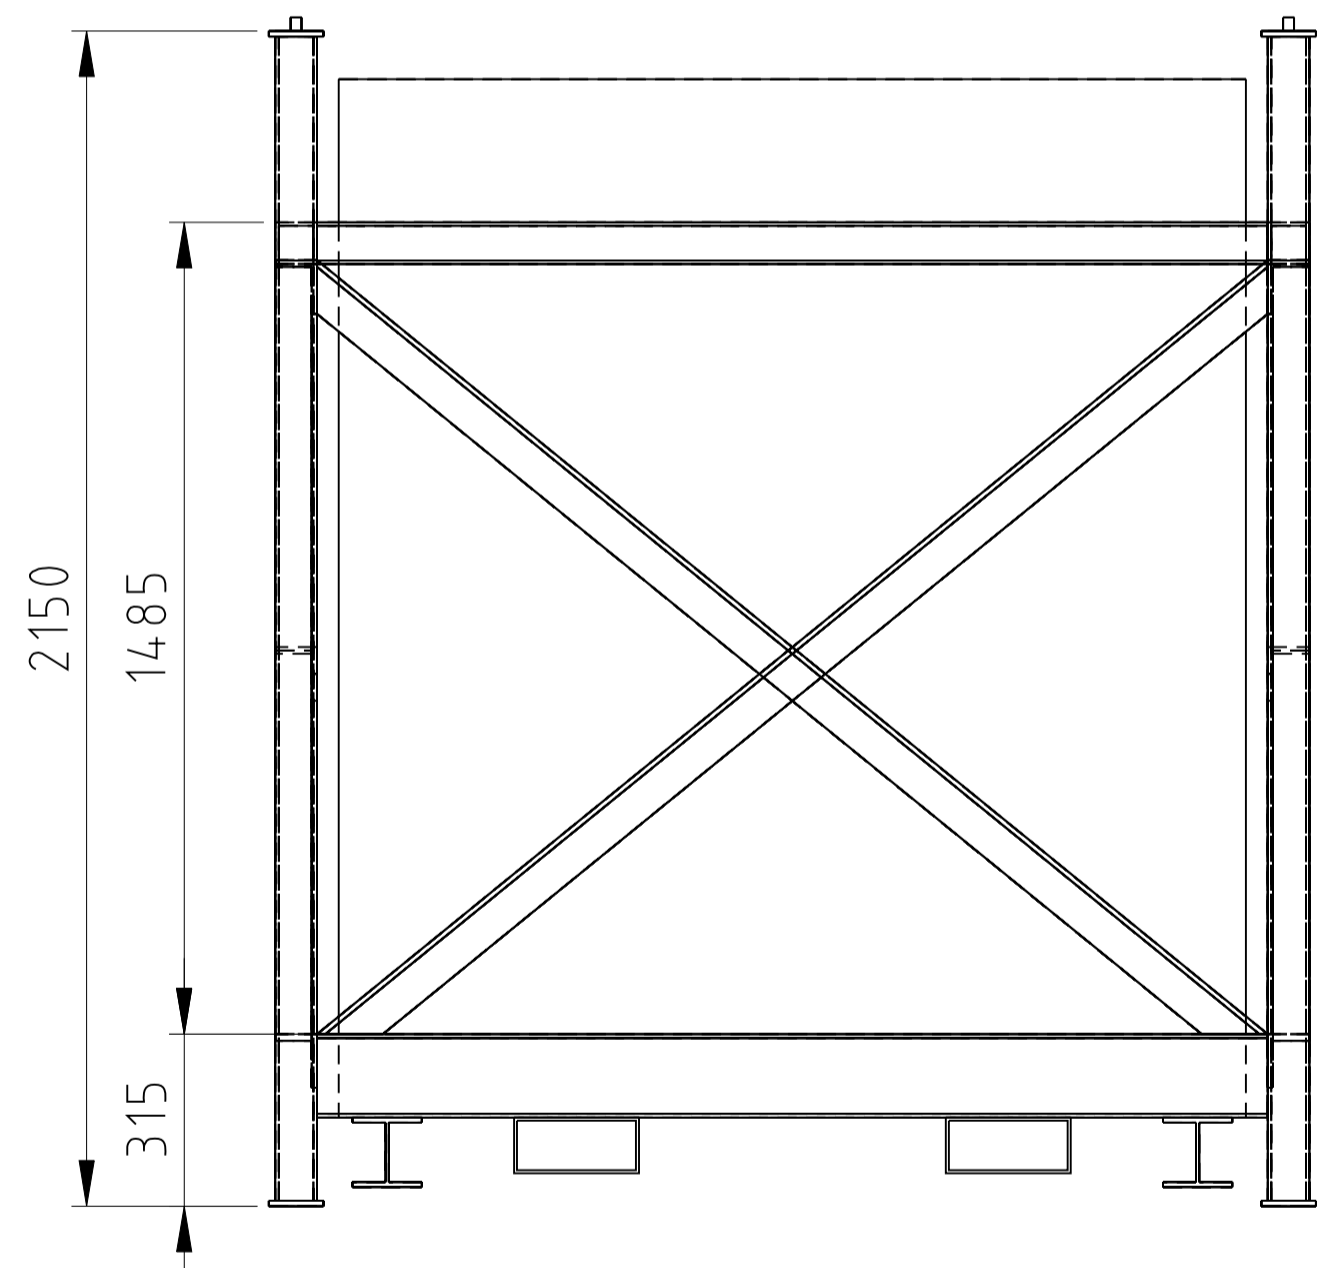
This Illustration for Information Purposes Only

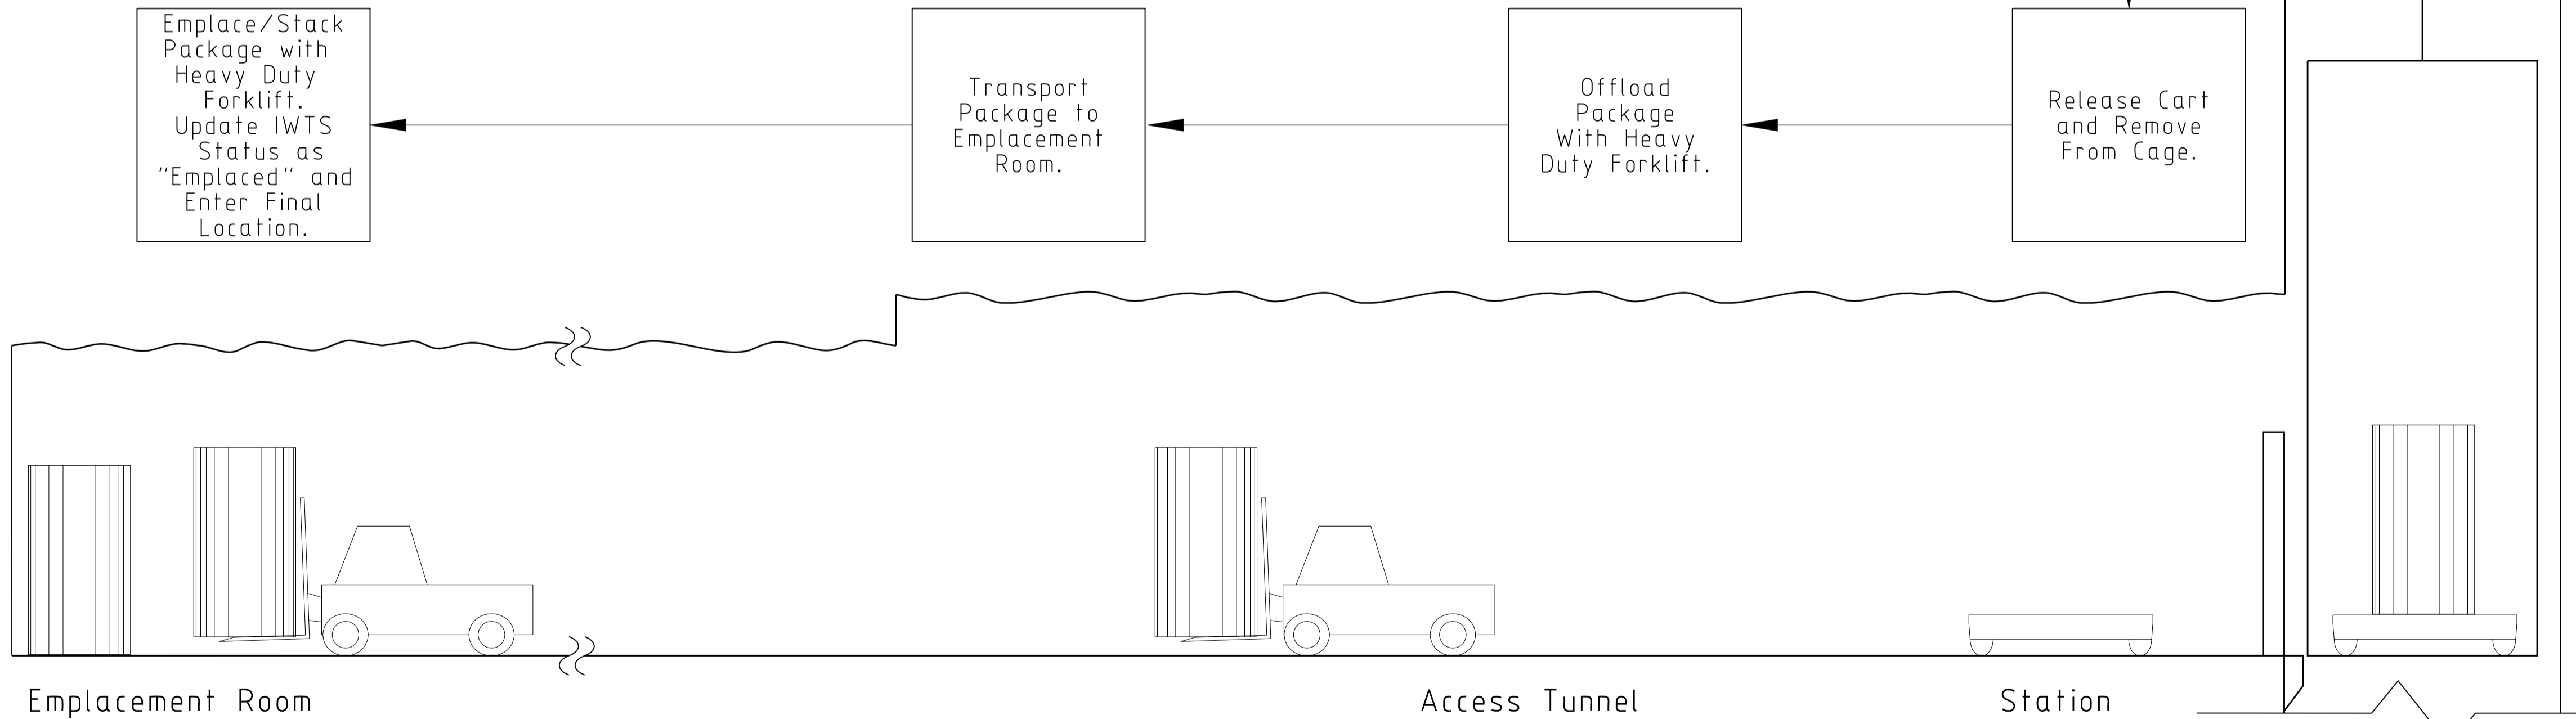Note: Empty carts will be returned to surface as required via rail network and shaft transport in the cage.


<p>DESIGNED BY D. WITOW DATE 2009-09-15</p> <p>CHECKED BY R. SETO DATE 2009-09-15</p> <p>DATE PROJ. DES. COORD.</p>			<p>DRAWN BY R. SETO DATE 2009-09-15</p> <p>DISCIPLINE ENGR.</p> <p>DATE PROJ. ENGR.</p>			<p>SCALE N.T.S. OR AS NOTED</p> <p>DWG. NO. H333000-WP401-05-030-0005</p>			<p>REV. 00 APPROVED FOR USE GRD SAA 2009-09-15</p> <p>ISSUE AUTHORIZATION</p>			<p>00</p>		
<p>NO.</p> <p>DESCRIPTION</p> <p>CHK'D</p> <p>APP'D</p> <p>DATE</p>			<p>NO.</p> <p>DESCRIPTION</p> <p>CHK'D</p> <p>APP'D</p> <p>DATE</p>			<p>NO.</p> <p>DESCRIPTION</p> <p>CHK'D</p> <p>APP'D</p> <p>DATE</p>			<p>NO.</p> <p>DESCRIPTION</p> <p>CHK'D</p> <p>APP'D</p> <p>DATE</p>			<p>NO.</p> <p>DESCRIPTION</p> <p>CHK'D</p> <p>APP'D</p> <p>DATE</p>		
<p>REFERENCE DRAWINGS</p>			<p>REVISIONS</p>			<p>REVISIONS</p>			<p>REVISIONS</p>			<p>REVISIONS</p>		



PLAN

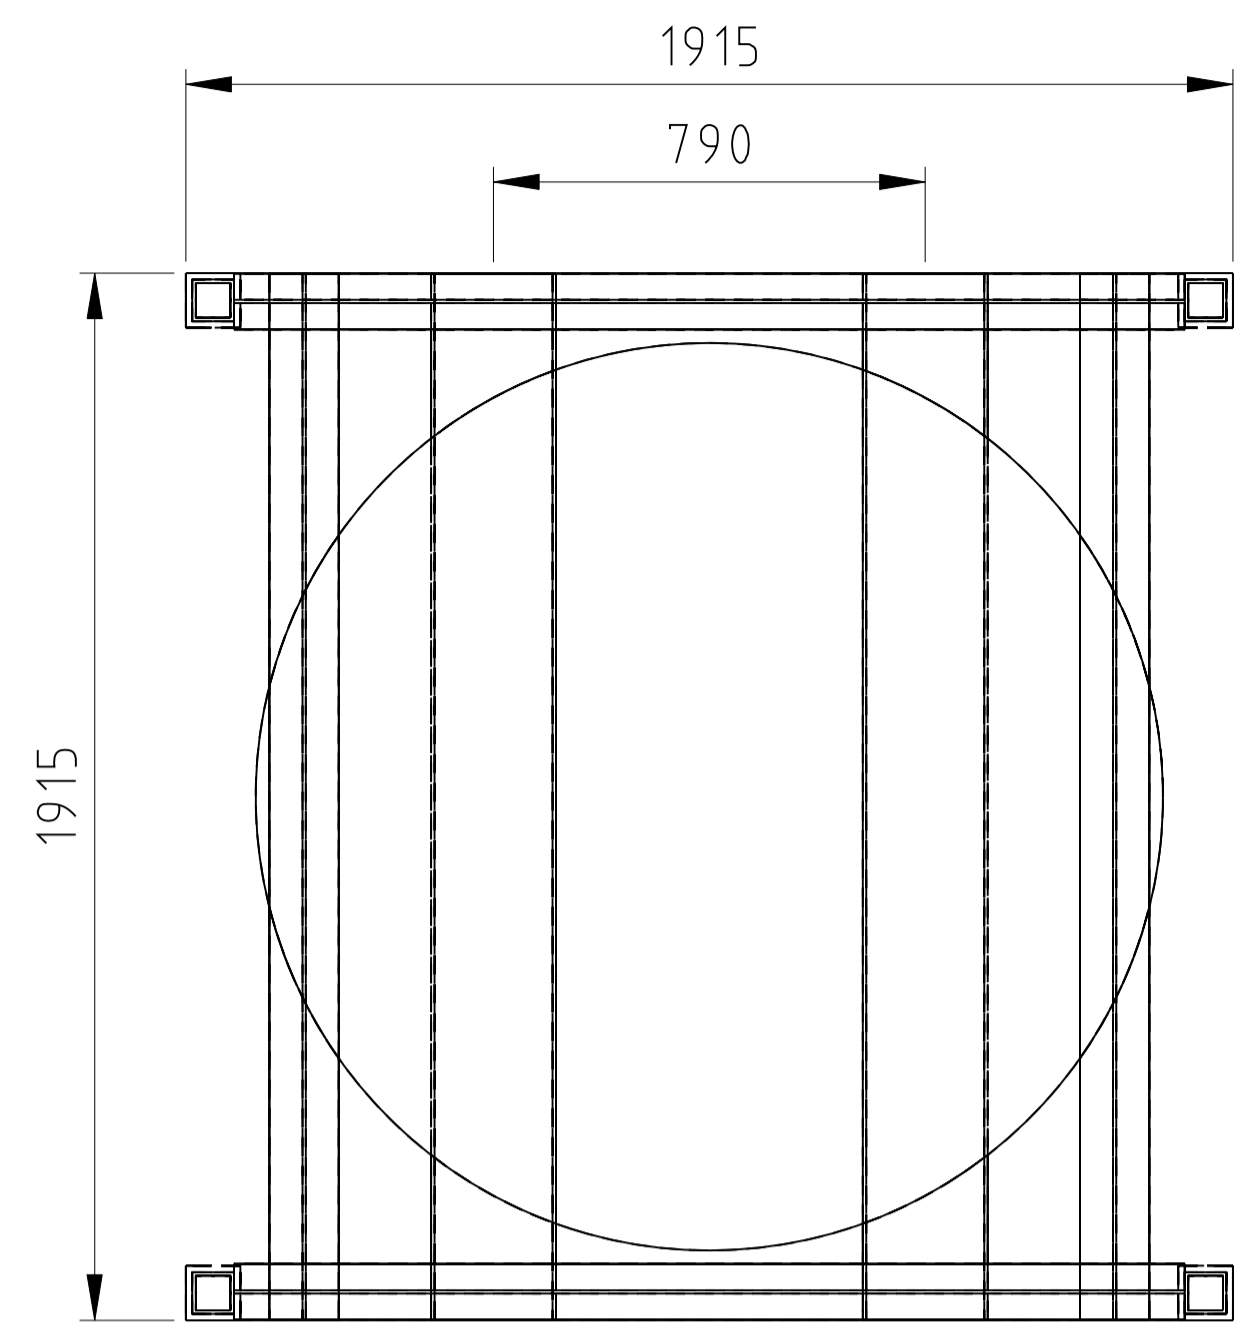

FRONT

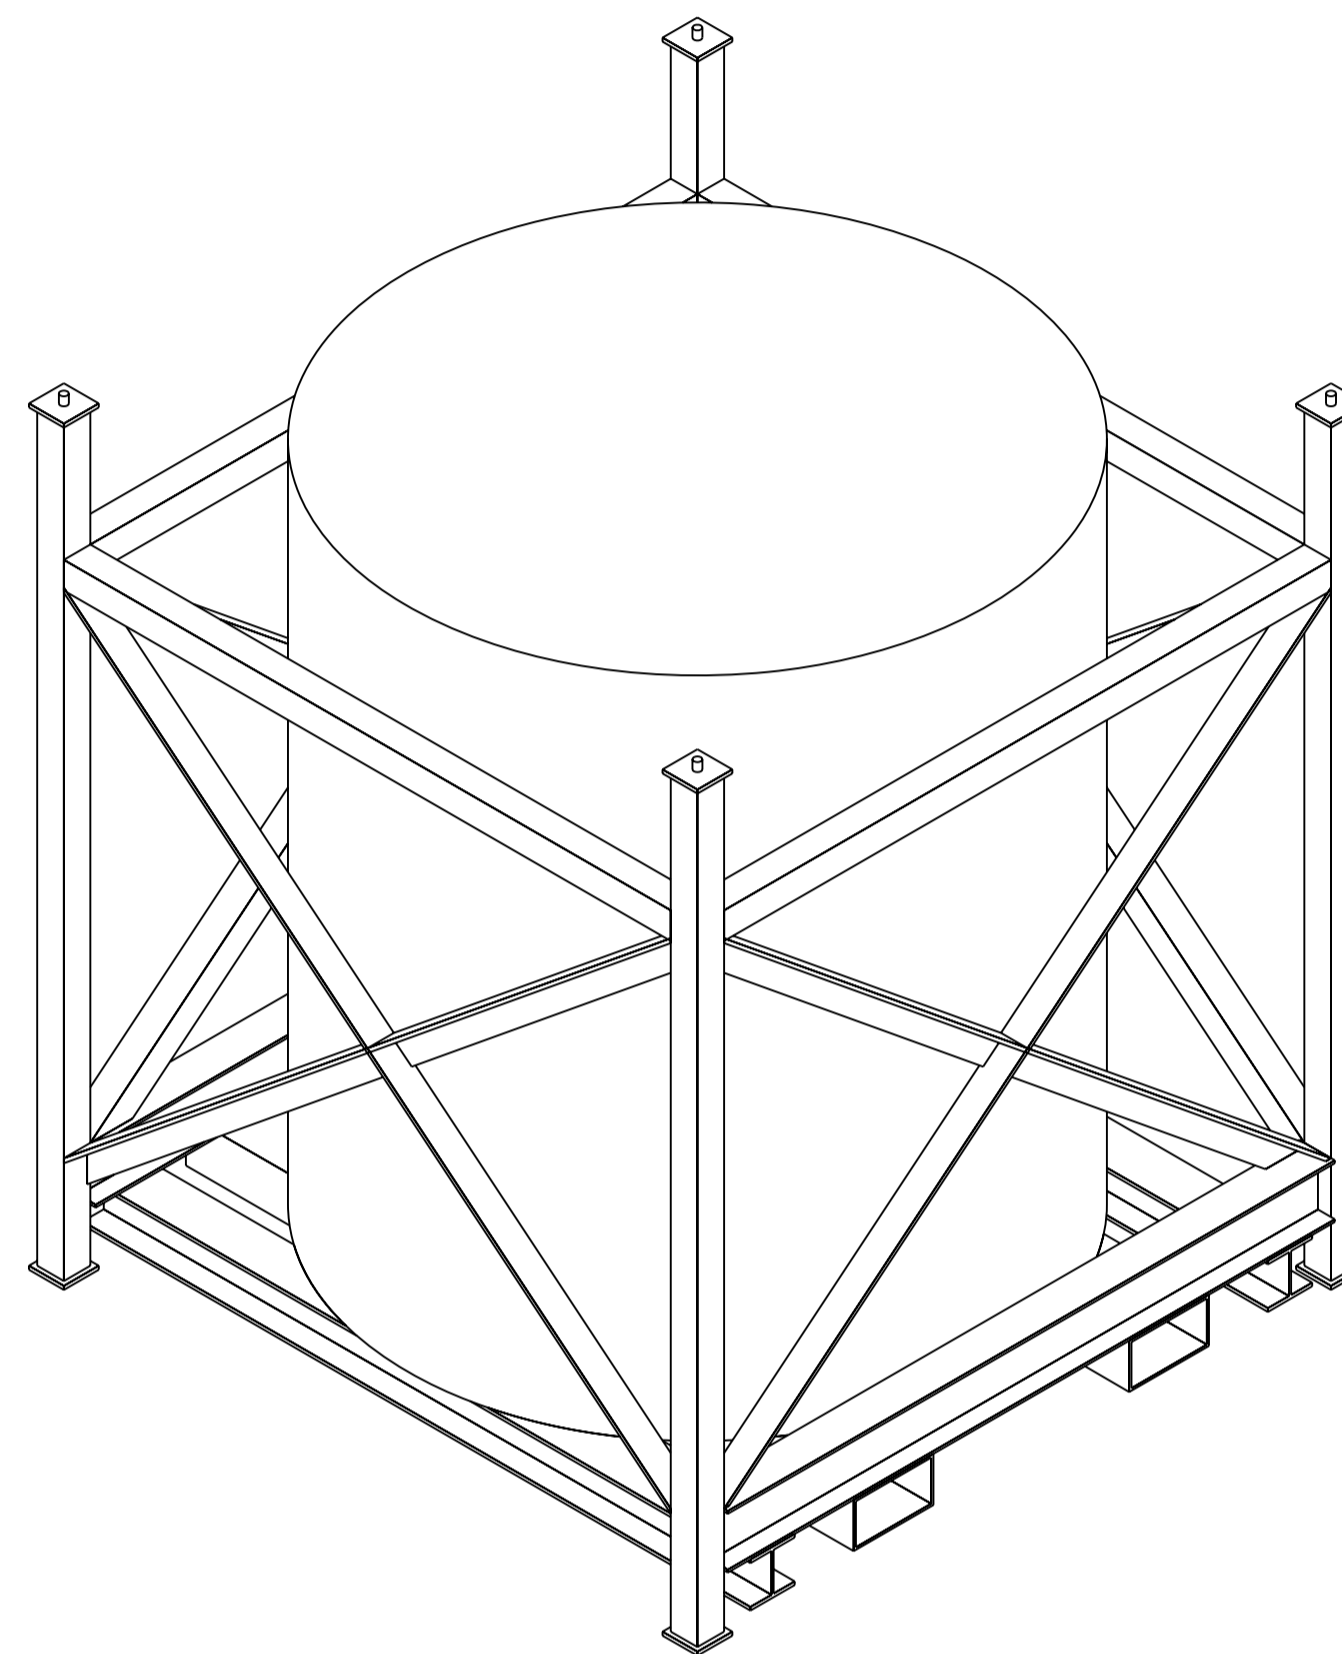

ISOMETRIC VIEW

MASS OF STRUCTURE = 670kg
 DESIGN LOAD = 6000kg
 TOTAL MASS FOR HANDLING = 6670kg
 CAPACITY = ONE UNSHIELDED RESIN LINER (WITH OR WITHOUT STAINLESS STEEL OVERPACK)

STACKING: 2-HIGH MAX

FOR DESIGN CRITERIA
 SEE H333000-WP401-10-220-0001

NOT FOR CONSTRUCTION
 This drawing has been reviewed for the purposes of DGR Preliminary Engineering only and must not be used for other purposes.
 Work Package Owner

Area Lead
[Signature]
 Digitally signed by M R Dawborn Reason: On behalf of Glen Davidge Date: 2009.10.28 10:48:11 -04'00'

Engineering Manager
[Signature]
 Sherwin Aarons 2009.10.28 10:12:40 -04'00'


Project Manager
[Signature]
 Digitally signed by M R Dawborn Date: 2009.10.28 10:48:18 -04'00'

Accepted by Owner
[Signature]
 R.J. Heystee 2009.10.30 16:27:14 -04'00'


NOT FOR CONSTRUCTION

				DESIGNED BY D. BHATTAL DATE 2009-09-23				DRAWN BY K. BUSHEY DATE 2009-09-23				HATCH				NWMO DEEP GEOLOGIC REPOSITORY PROJECT															
				CHECKED BY				DISCIP. ENGR.								GENERAL ARRANGEMENT SACRIFICIAL PALLET UNSHIELDED RESIN LINERS															
				DATE PROJ. MGR. M. DAWBORN DATE				DATE PROJ. ENGR.				SCALE NTS OR AS NOTED				DRAWING NO. H333000-WP401-35-042-0001				SHT. REV. 00											
NO.				DESCRIPTION				CHK'D APP'D				DATE				NO.				ISSUE FOR				AUTH. BY				DATE			
REVISIONS				ISSUE AUTHORIZATION				00 APPROVED FOR USE				GRD SAA 2009-10-22																			


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 10/26/2009 1:17:19 AM
 bush53169

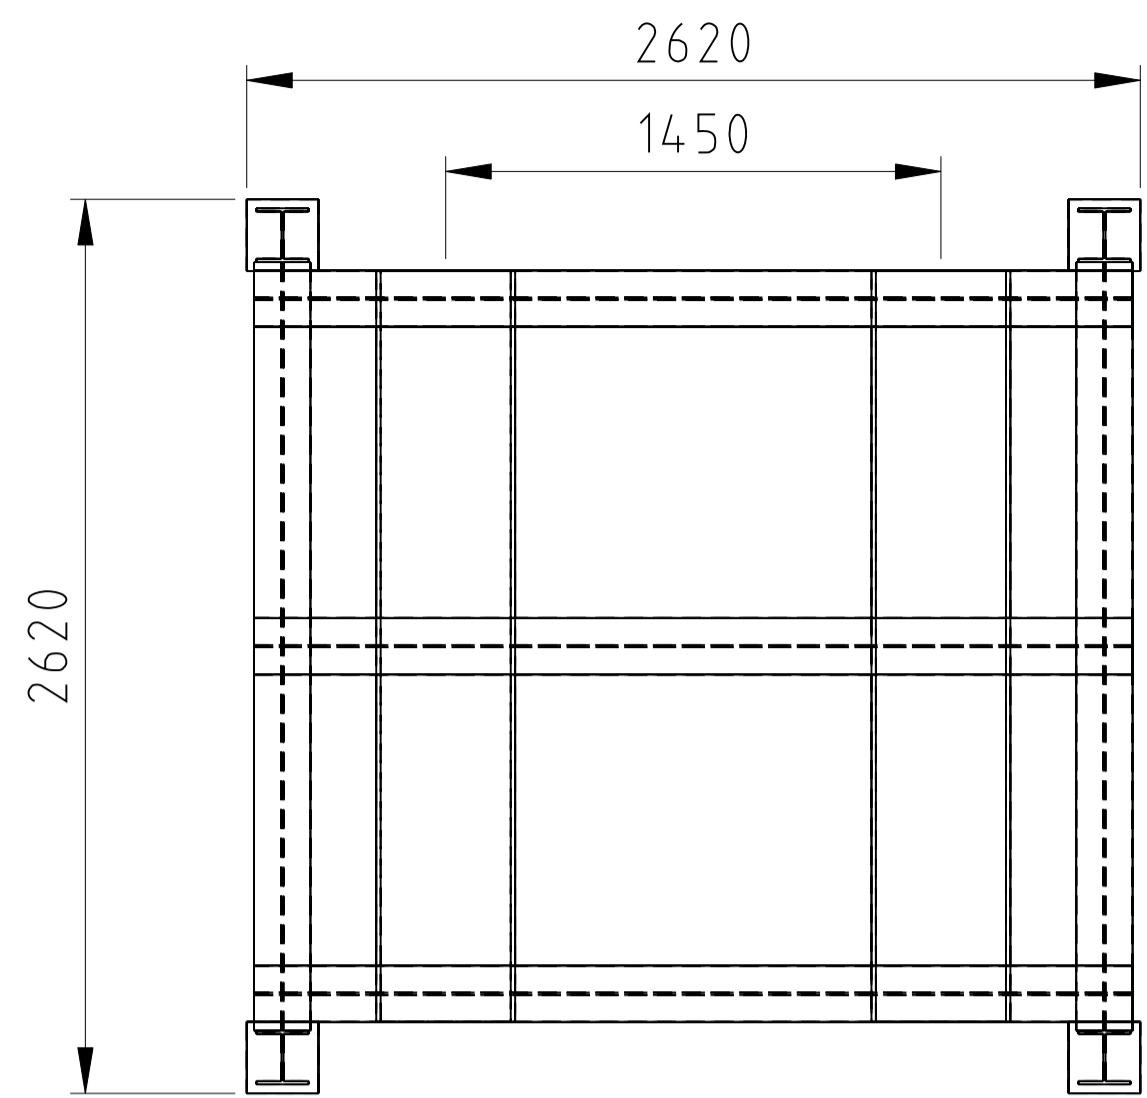

PLAN

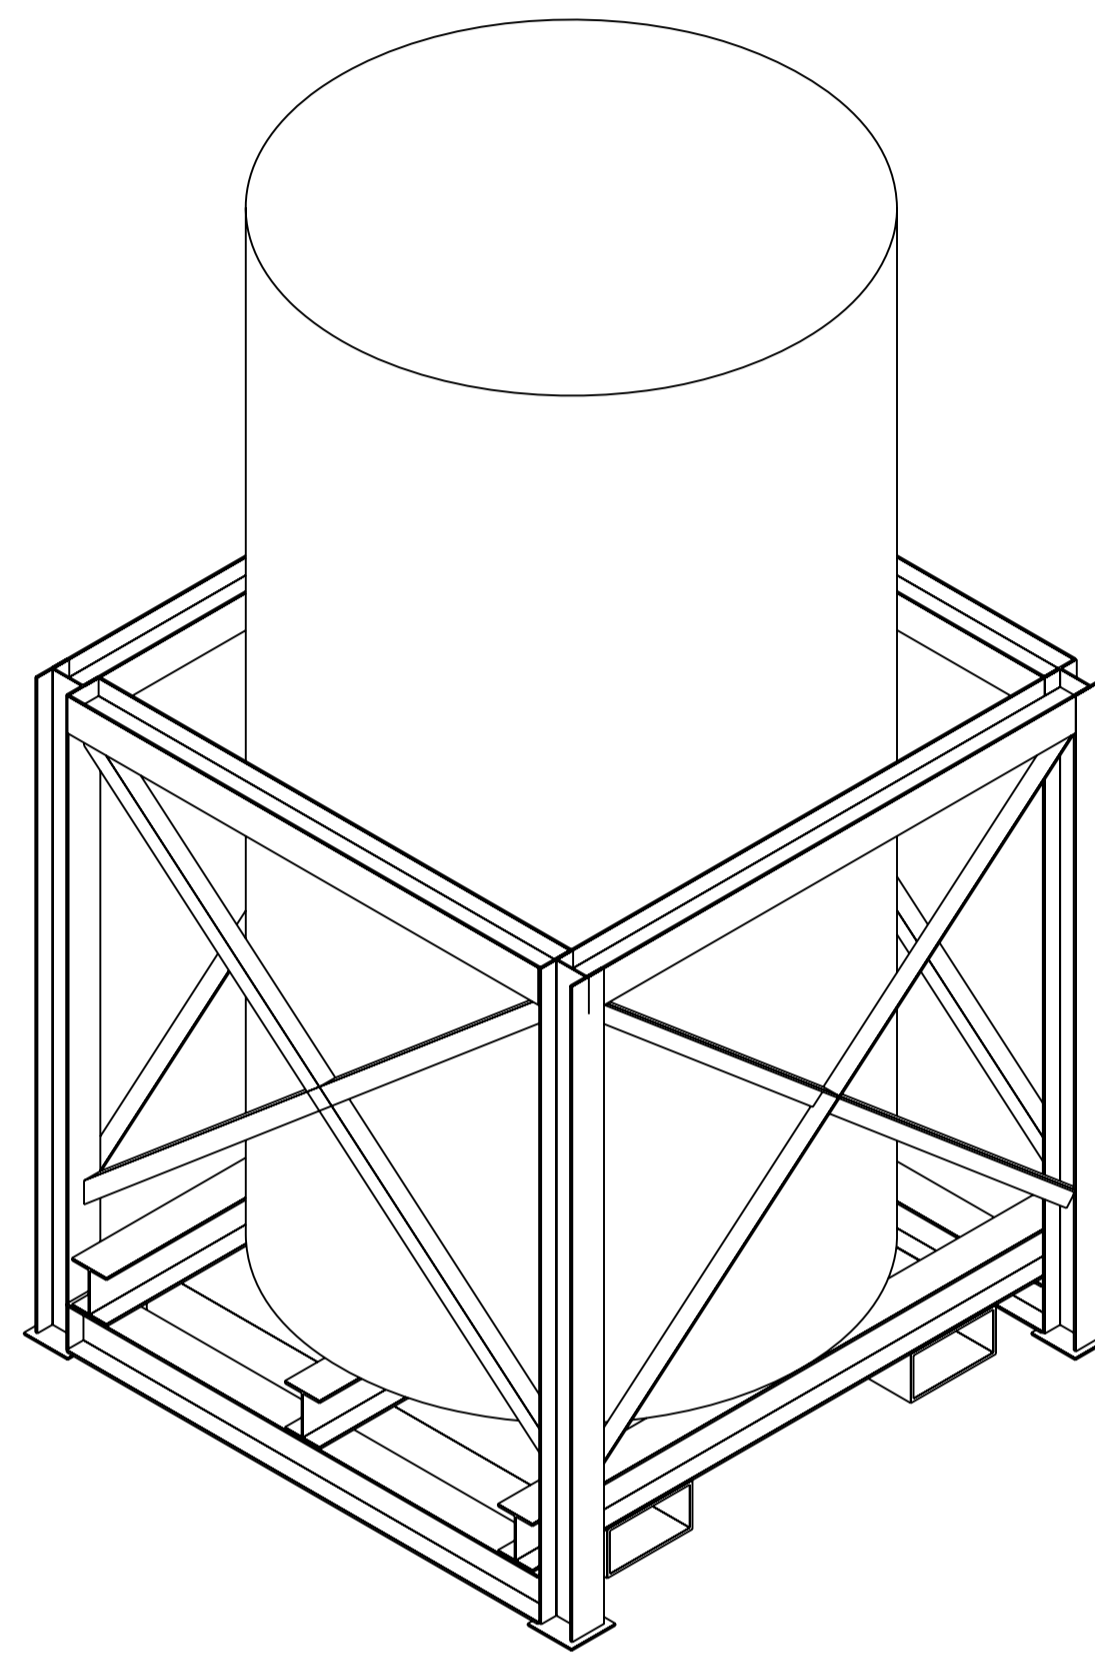

ISOMETRIC VIEW

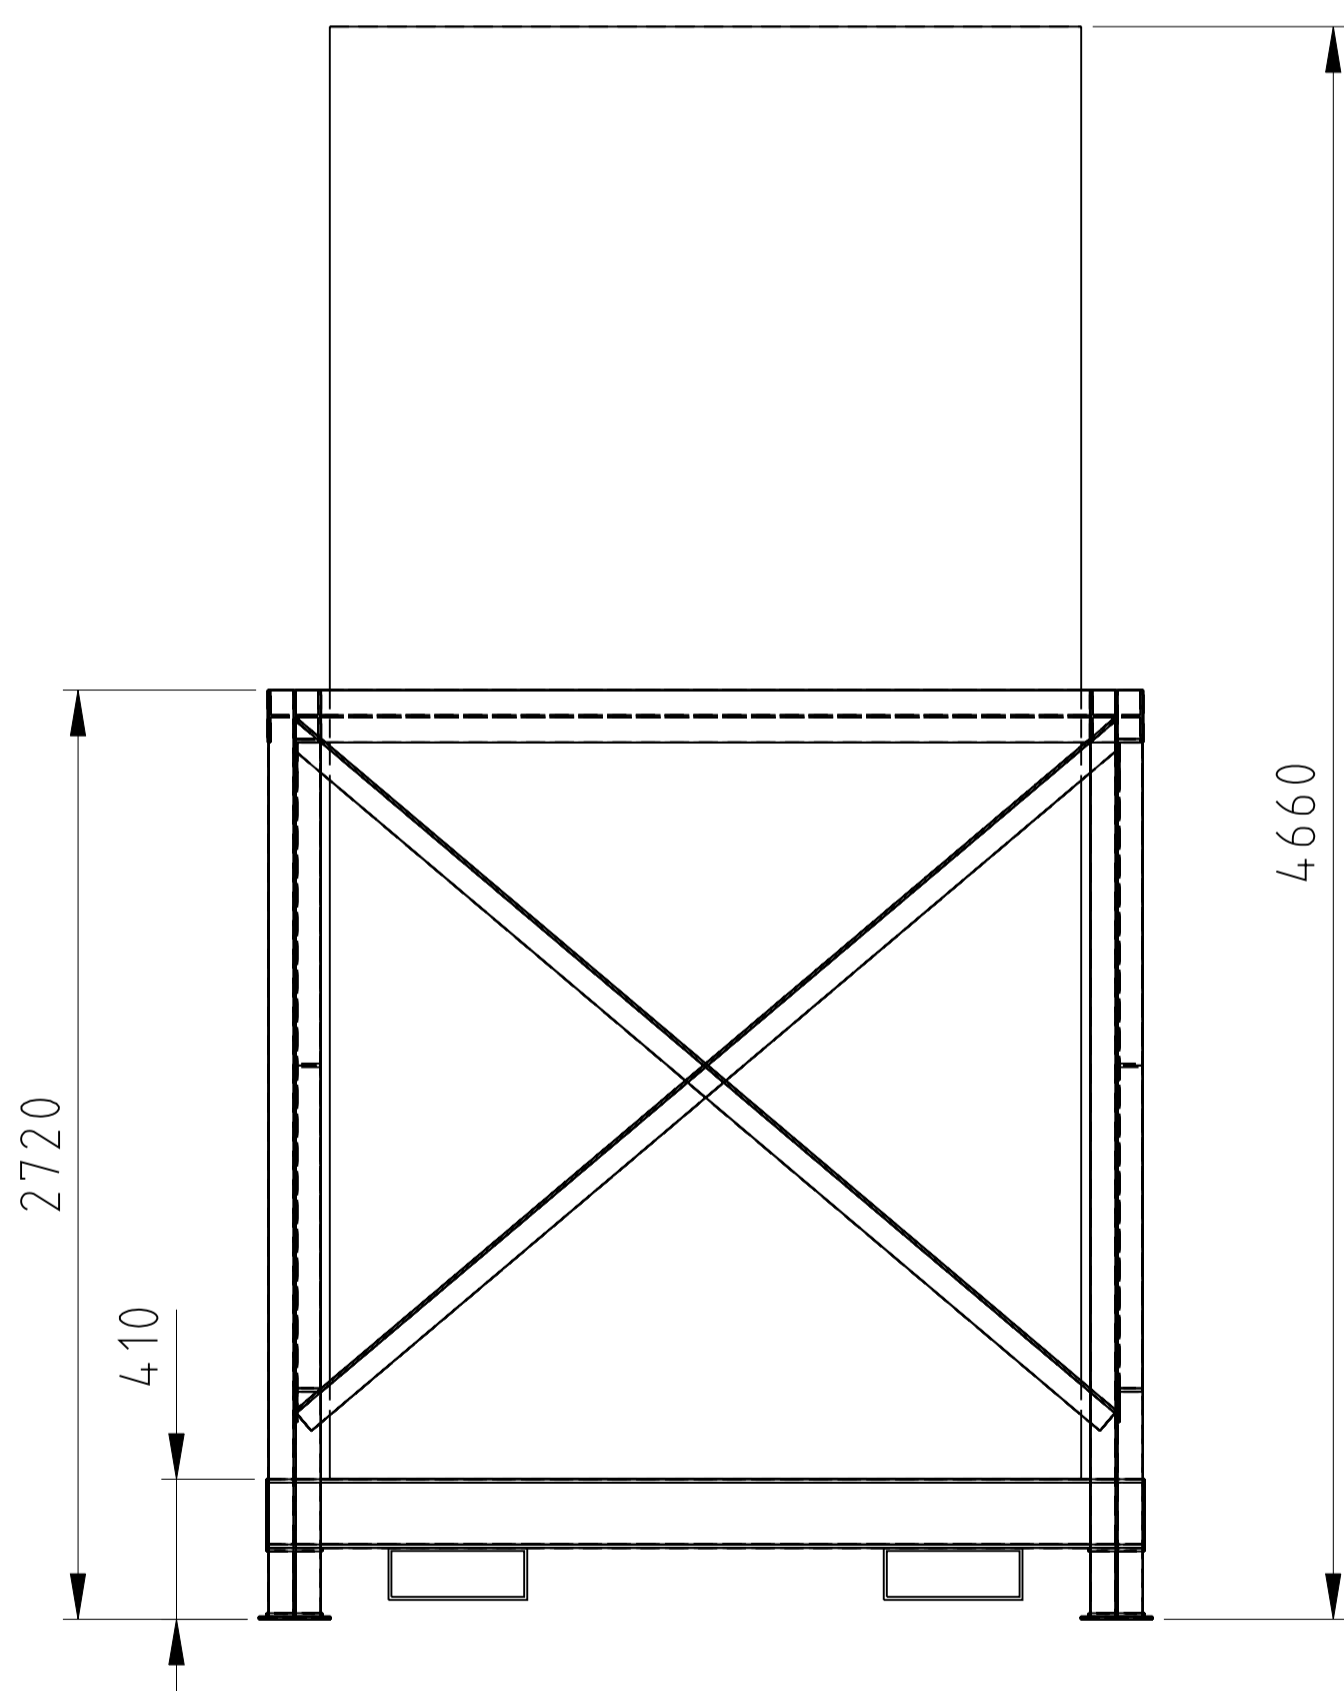

FRONT

MASS OF STRUCTURE = 1800kg
 DESIGN LOAD = 29760kg
 TOTAL MASS FOR HANDLING = 31560kg
 CAPACITY = ONE RESIN LINER SHELL "SHIELD 1"
 FROM QUADRICELL

FOR DESIGN CRITERIA
 SEE H333000-WP401-10-220-0001

NOT FOR CONSTRUCTION
 This drawing has been reviewed for the purposes of DGR Preliminary Engineering only and must not be used for other purposes.
 Work Package Owner

[Signature]
 Area Lead

[Signature]
 Engineering Manager
 Digitally signed by M R Dawborn
 Reason: On behalf of Glen Davidge
 Date: 2009.10.28 10:48:35 -04'00'

[Signature]
 Project Manager
 Sherwin Aarons
 2009.10.28 10:13:14 -04'00'

[Signature]
 Accepted by Owner
 Digitally signed by M R Dawborn
 Date: 2009.10.28 10:48:42 -04'00'

[Signature]
 R.J. Heystee
 2009.10.30 16:28:18 -04'00'

NOT FOR CONSTRUCTION


NO.	DESCRIPTION	CHK'D	APP'D	DATE	NO.	ISSUE FOR	AUTH. BY	DATE
					00	APPROVED FOR USE	GRD SAA	2009-10-22
REVISIONS				ISSUE AUTHORIZATION				

DESIGNED BY D. BHATTAL DATE 2009-09-23	DRAWN BY K. BUSHEY DATE 2009-09-23
CHECKED BY	DISCIP. ENGR.
DATE	DATE
PROJ. MGR.	PROJ. ENGR.
M. DAWBORN DATE	DATE


HATCH

SCALE
NTS
OR AS NOTED


NWMO DEEP GEOLOGIC REPOSITORY PROJECT	
GENERAL ARRANGEMENT SACRIFICIAL PALLET RESIN LINER SHELLS FROM QUADRICELLS	
DRAWING NO. H333000-WP401-35-042-0002	SHT. REV. 00

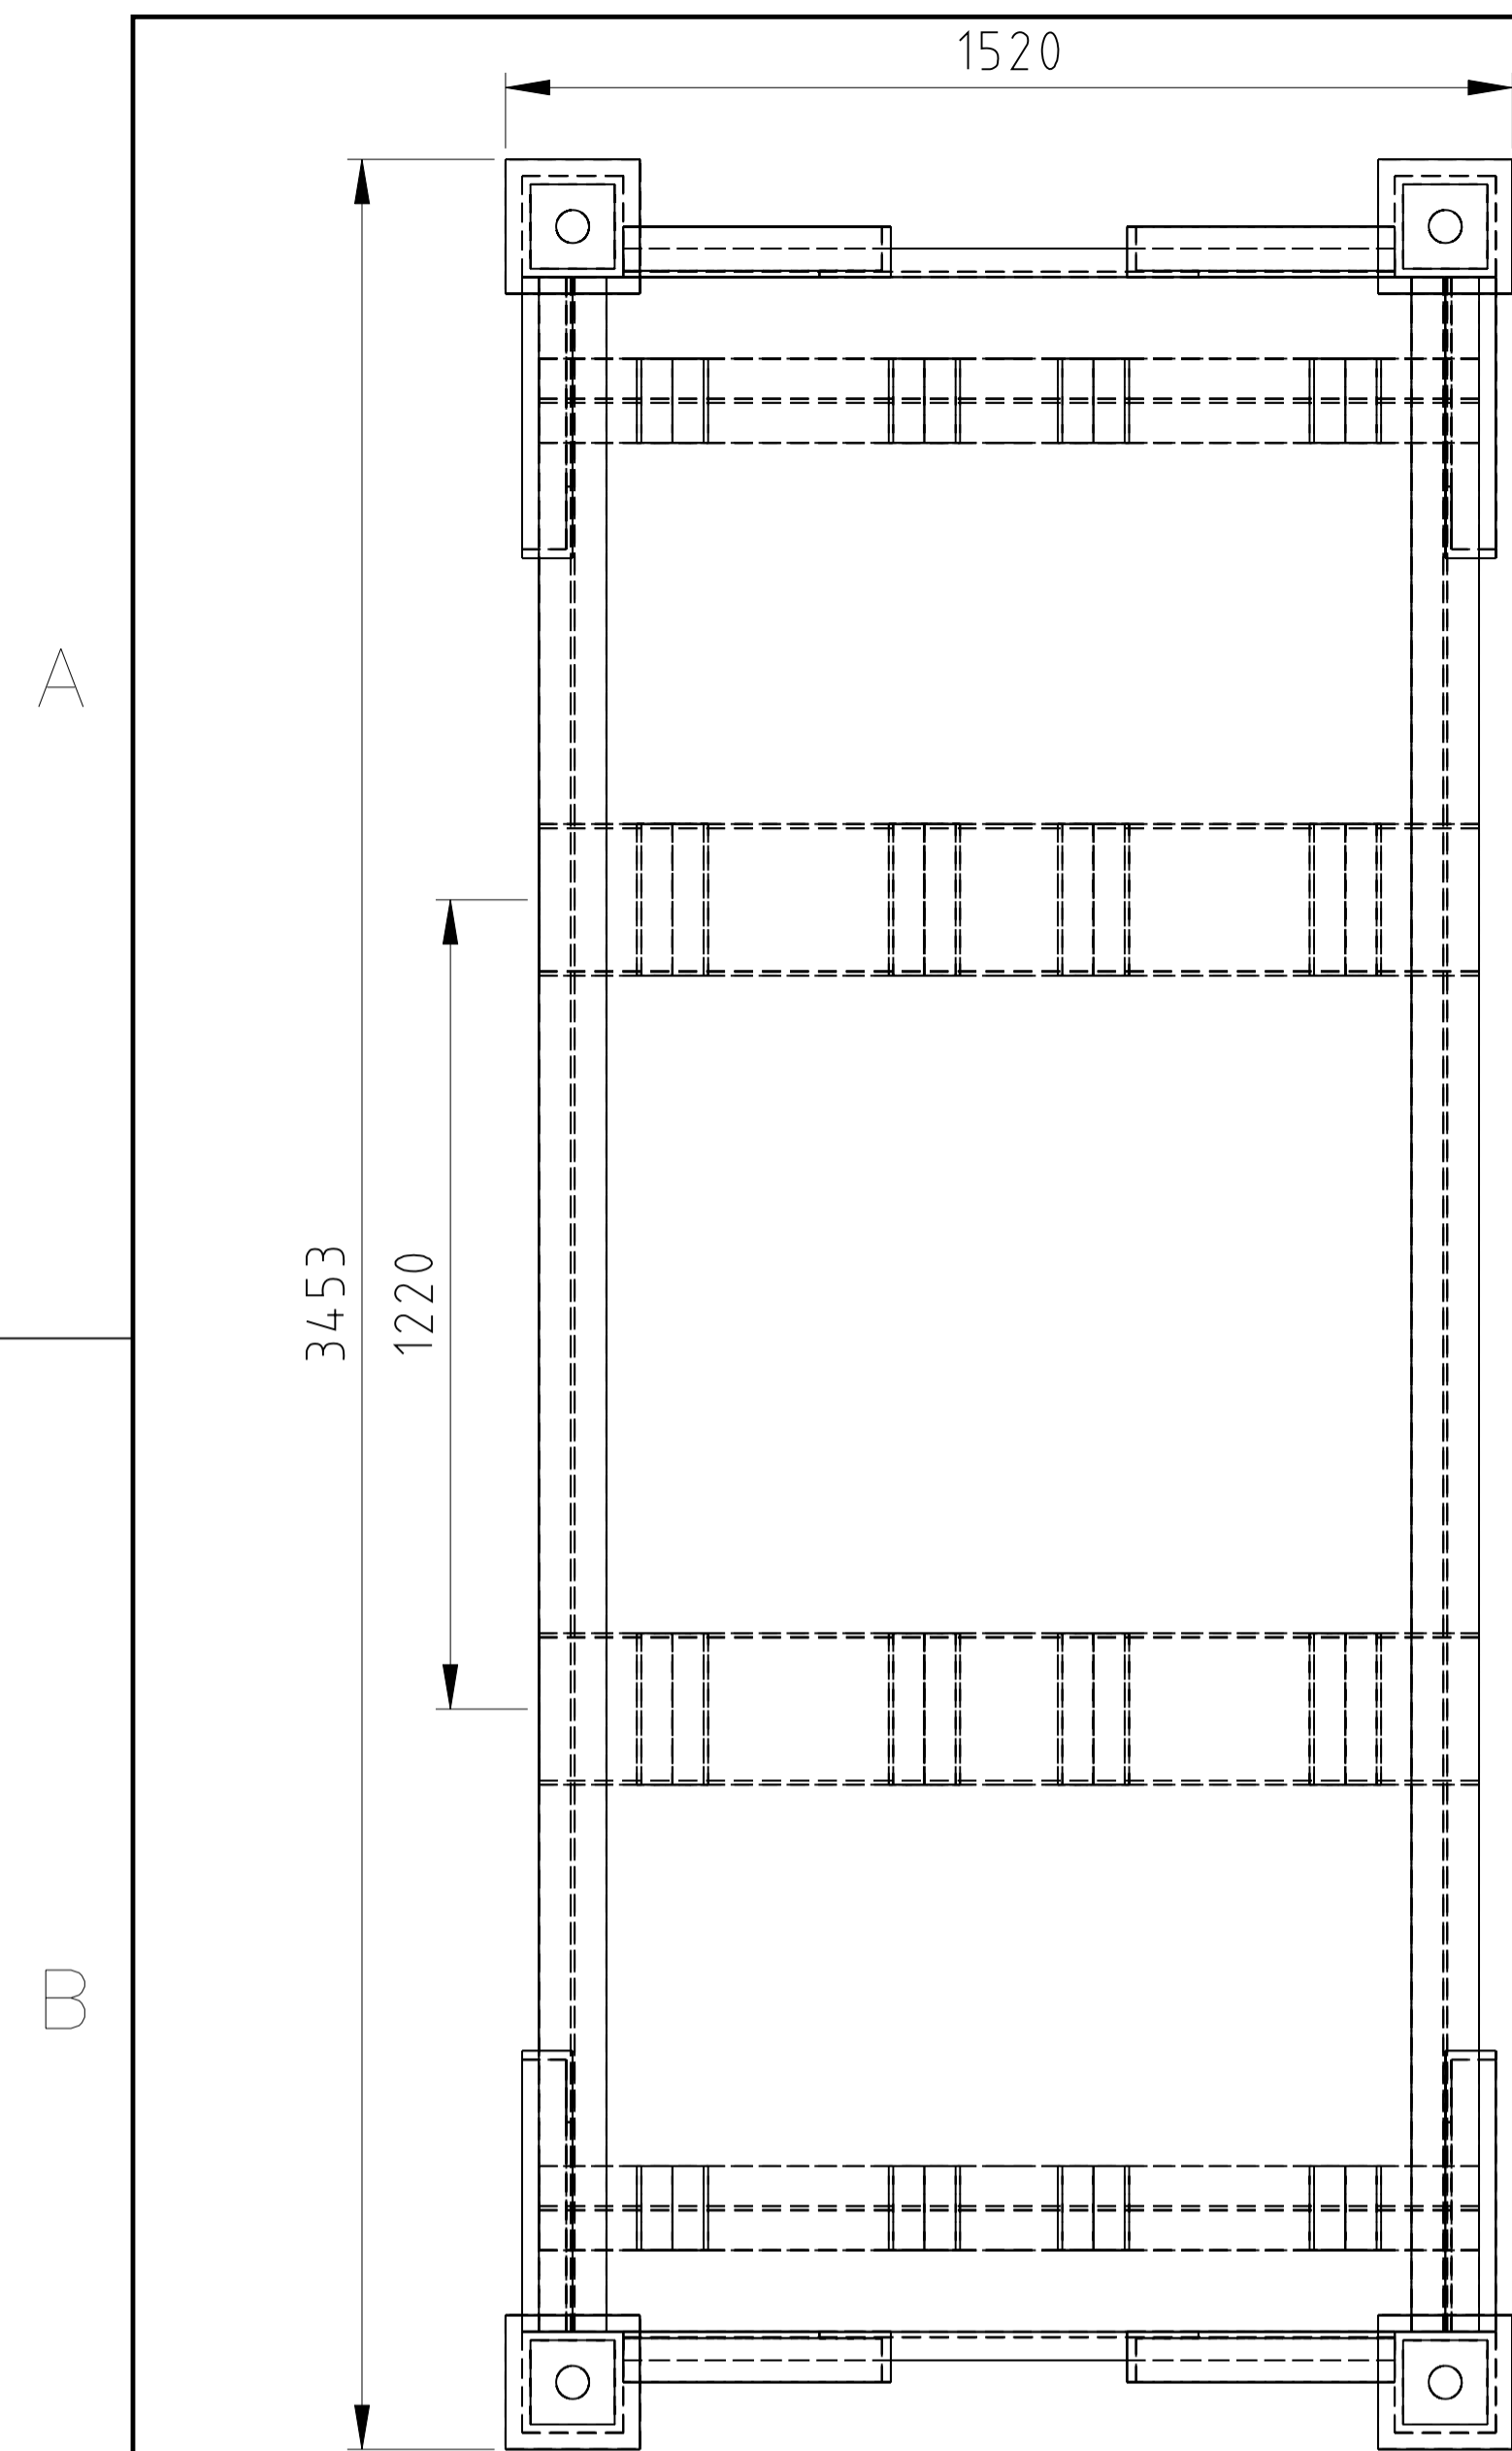


PLAN

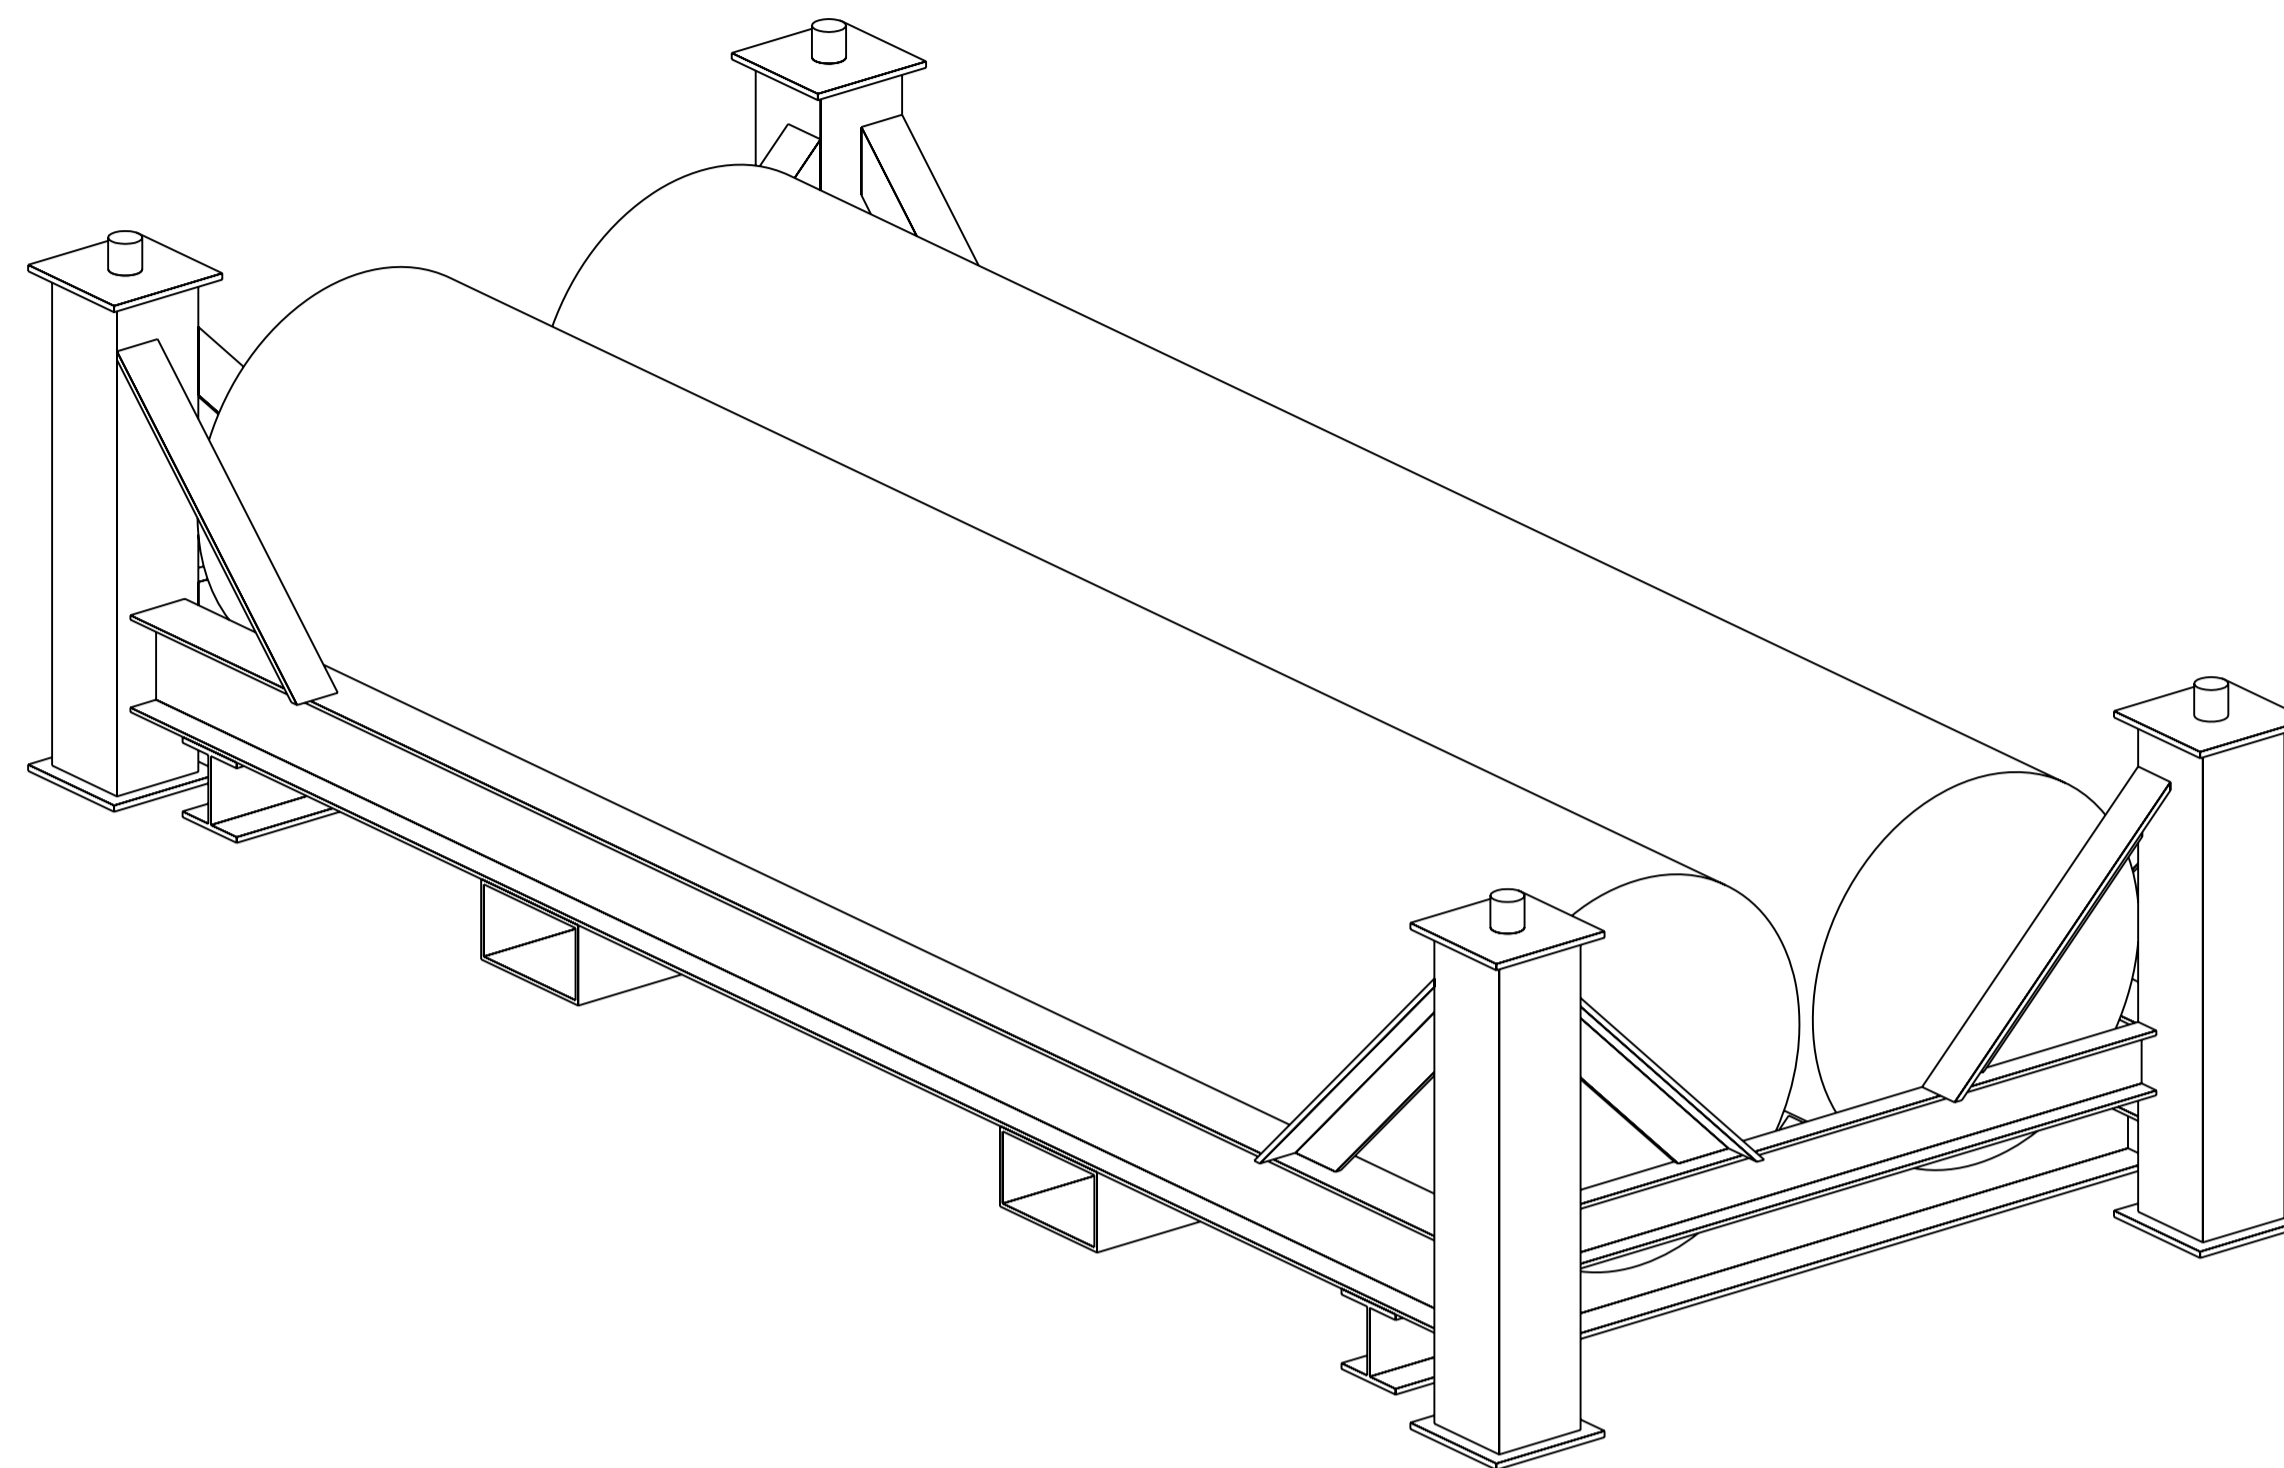

ISOMETRIC VIEW

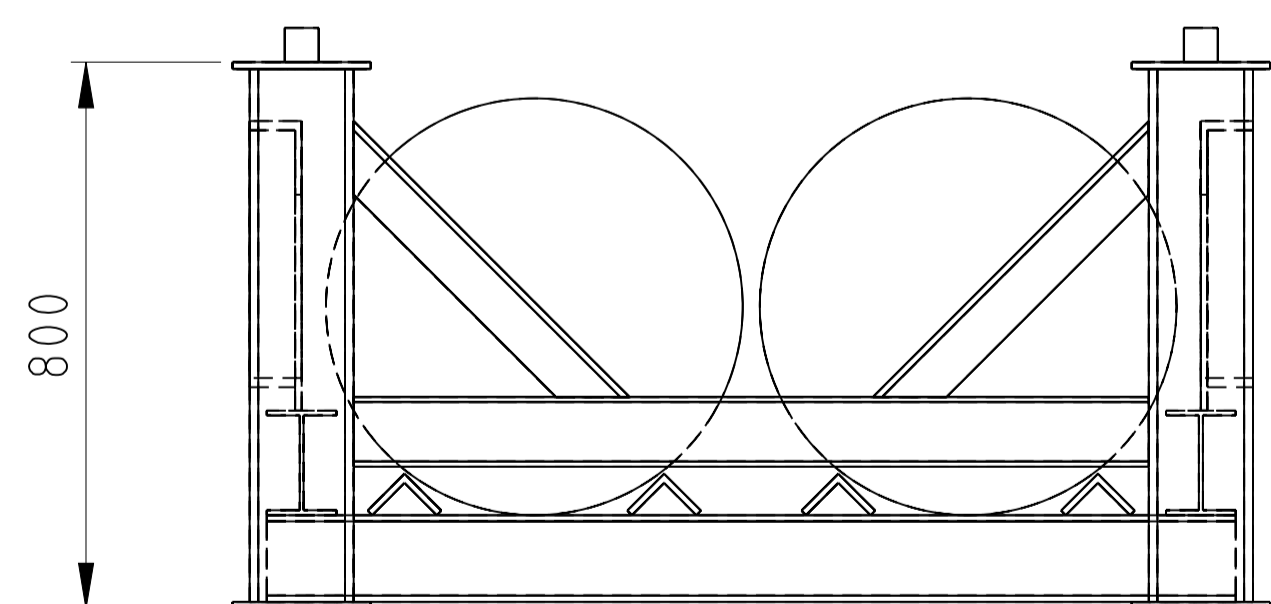

FRONT

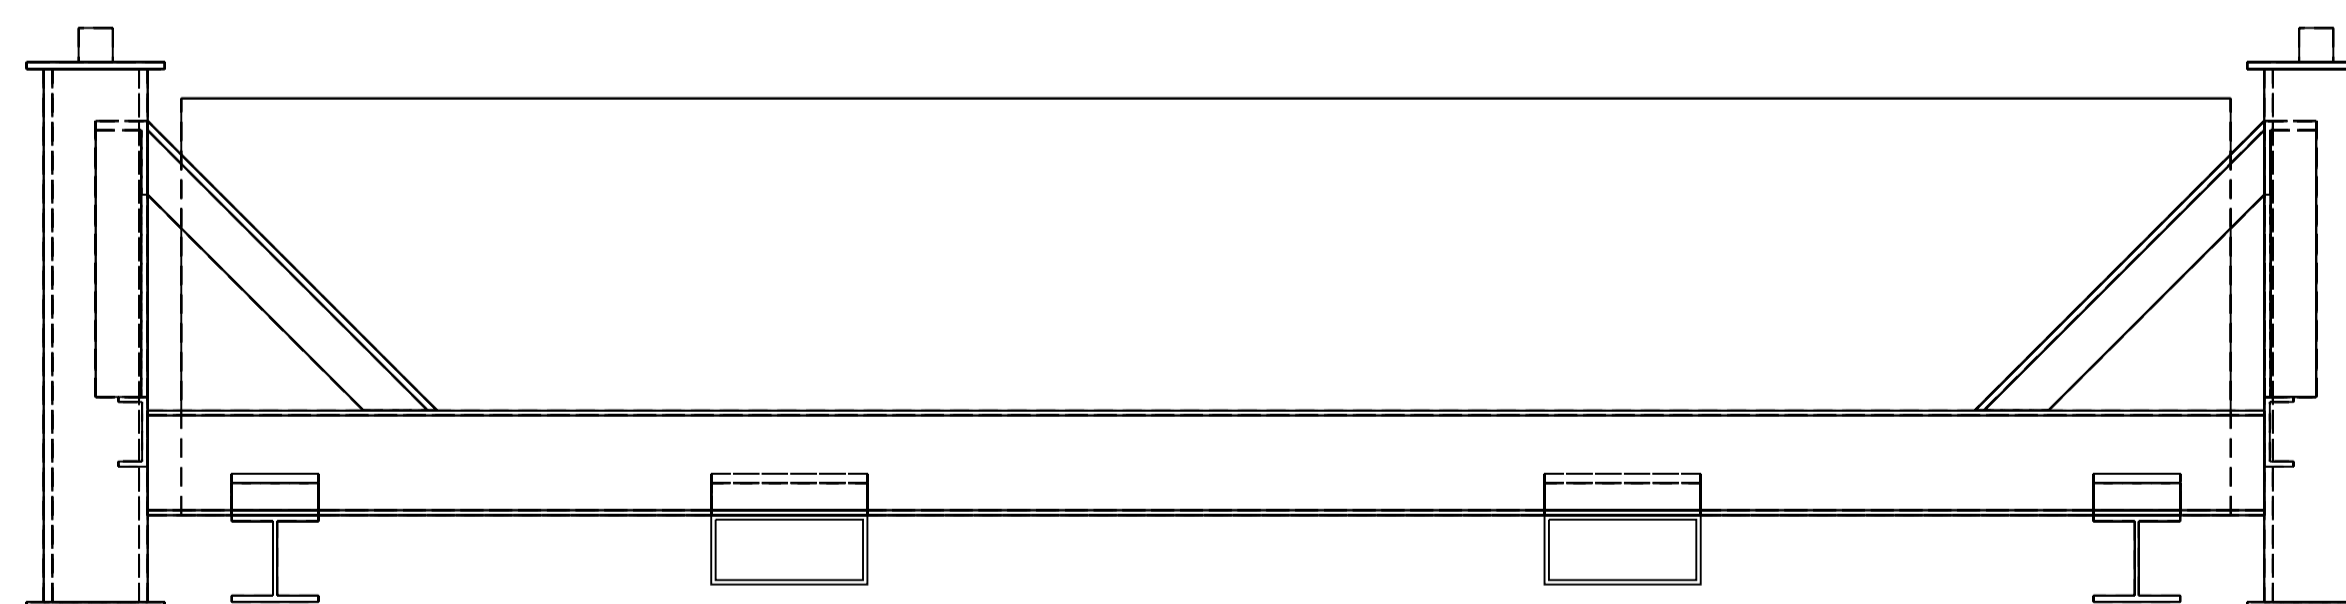

RIGHT

MASS OF STRUCTURE = 565kg
 DESIGN LOAD = 4400kg
 TOTAL MASS FOR HANDLING = 4965kg
 CAPACITY: TWO TILE HOLE LINERS

STACKING: 5-HIGH MAX

FOR DESIGN CRITERIA
 SEE H333000-WP401-10-220-0001

NOT FOR CONSTRUCTION
 This drawing has been reviewed for the purposes of DGR Preliminary Engineering only and must not be used for other purposes.
 Work Package Owner

[Signature]
 Area Lead

[Signature]
 Digitally signed by M R Dawborn
 Reason: On behalf of Glen Davidge
 Date: 2009.10.28 10:48:57 -0400
 Engineering Manager

[Signature]
 Sherwin Aarons
 2009.10.28 10:13:34 -0400
 Project Manager


[Signature]
 Digitally signed by M R Dawborn
 Date: 2009.10.28 10:49:03 -0400
 Accepted by Owner

[Signature]
 R.J. Heystee
 2009.10.30 16:29:09 -0400


NOT FOR CONSTRUCTION

				DESIGNED BY D. BHATTAL DATE 2009-09-25				DRAWN BY K. BUSHEY DATE 2009-09-25		HATCH		NWMO DEEP GEOLOGIC REPOSITORY PROJECT			
				CHECKED BY				DISCIP. ENGR.				GENERAL ARRANGEMENT SACRIFICIAL RACK TILE HOLE LINERS			
				DATE PROJ. MGR.				DATE PROJ. ENGR.		SCALE NTS OR AS NOTED		DRAWING NO. H333000-WP401-35-042-0003		SHT. REV. 00	
NO. DESCRIPTION				NO. ISSUE FOR				DATE				DATE			
REVISIONS				ISSUE AUTHORIZATION				DATE							

A

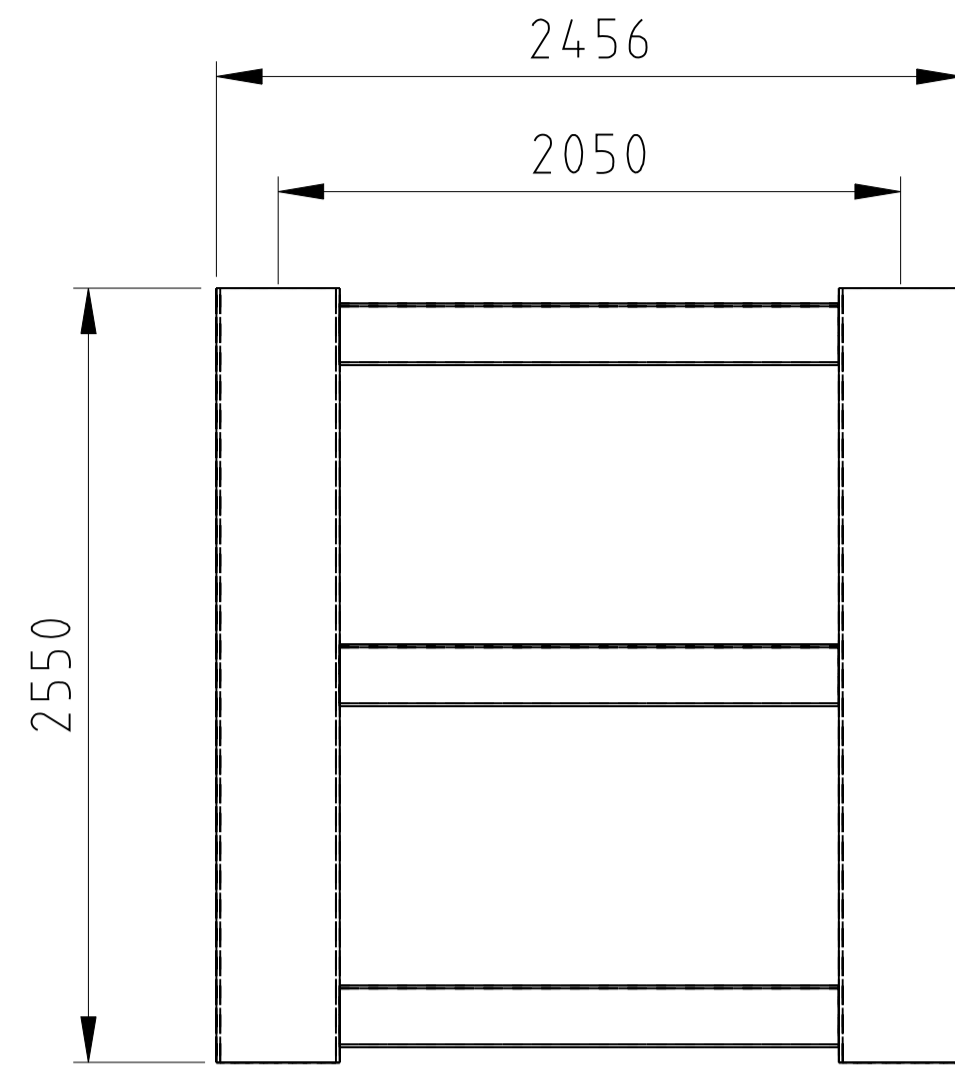


PLAN

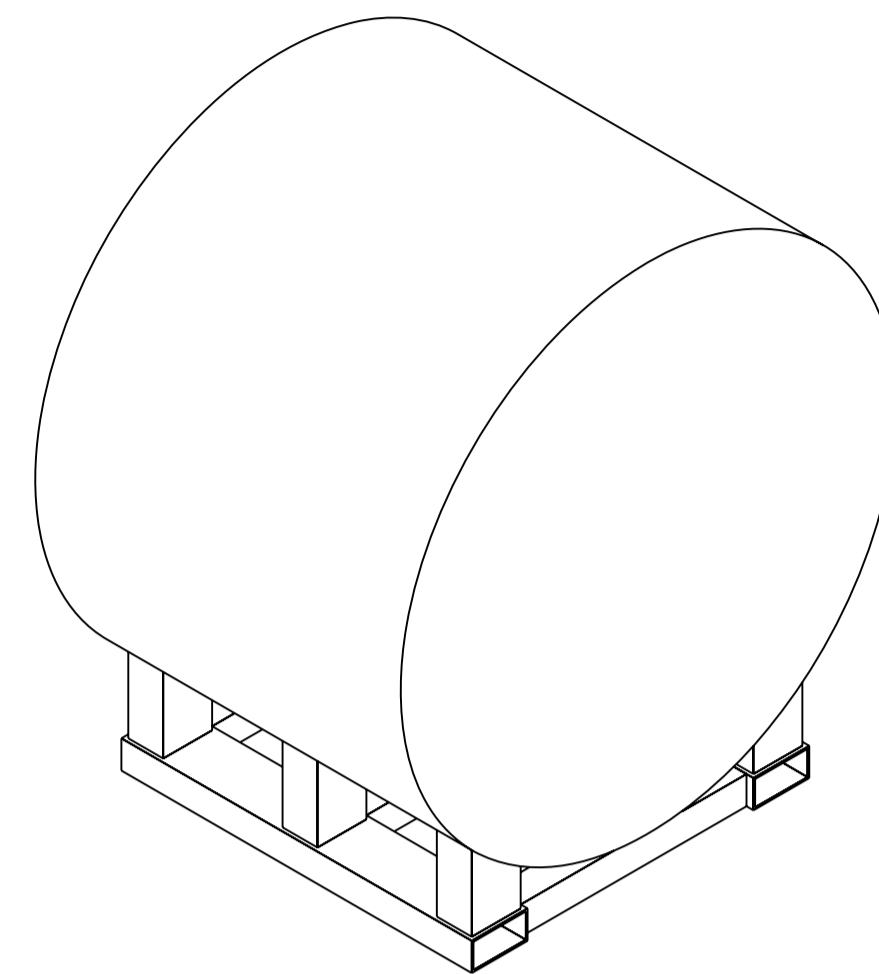


ISOMETRIC VIEW

B

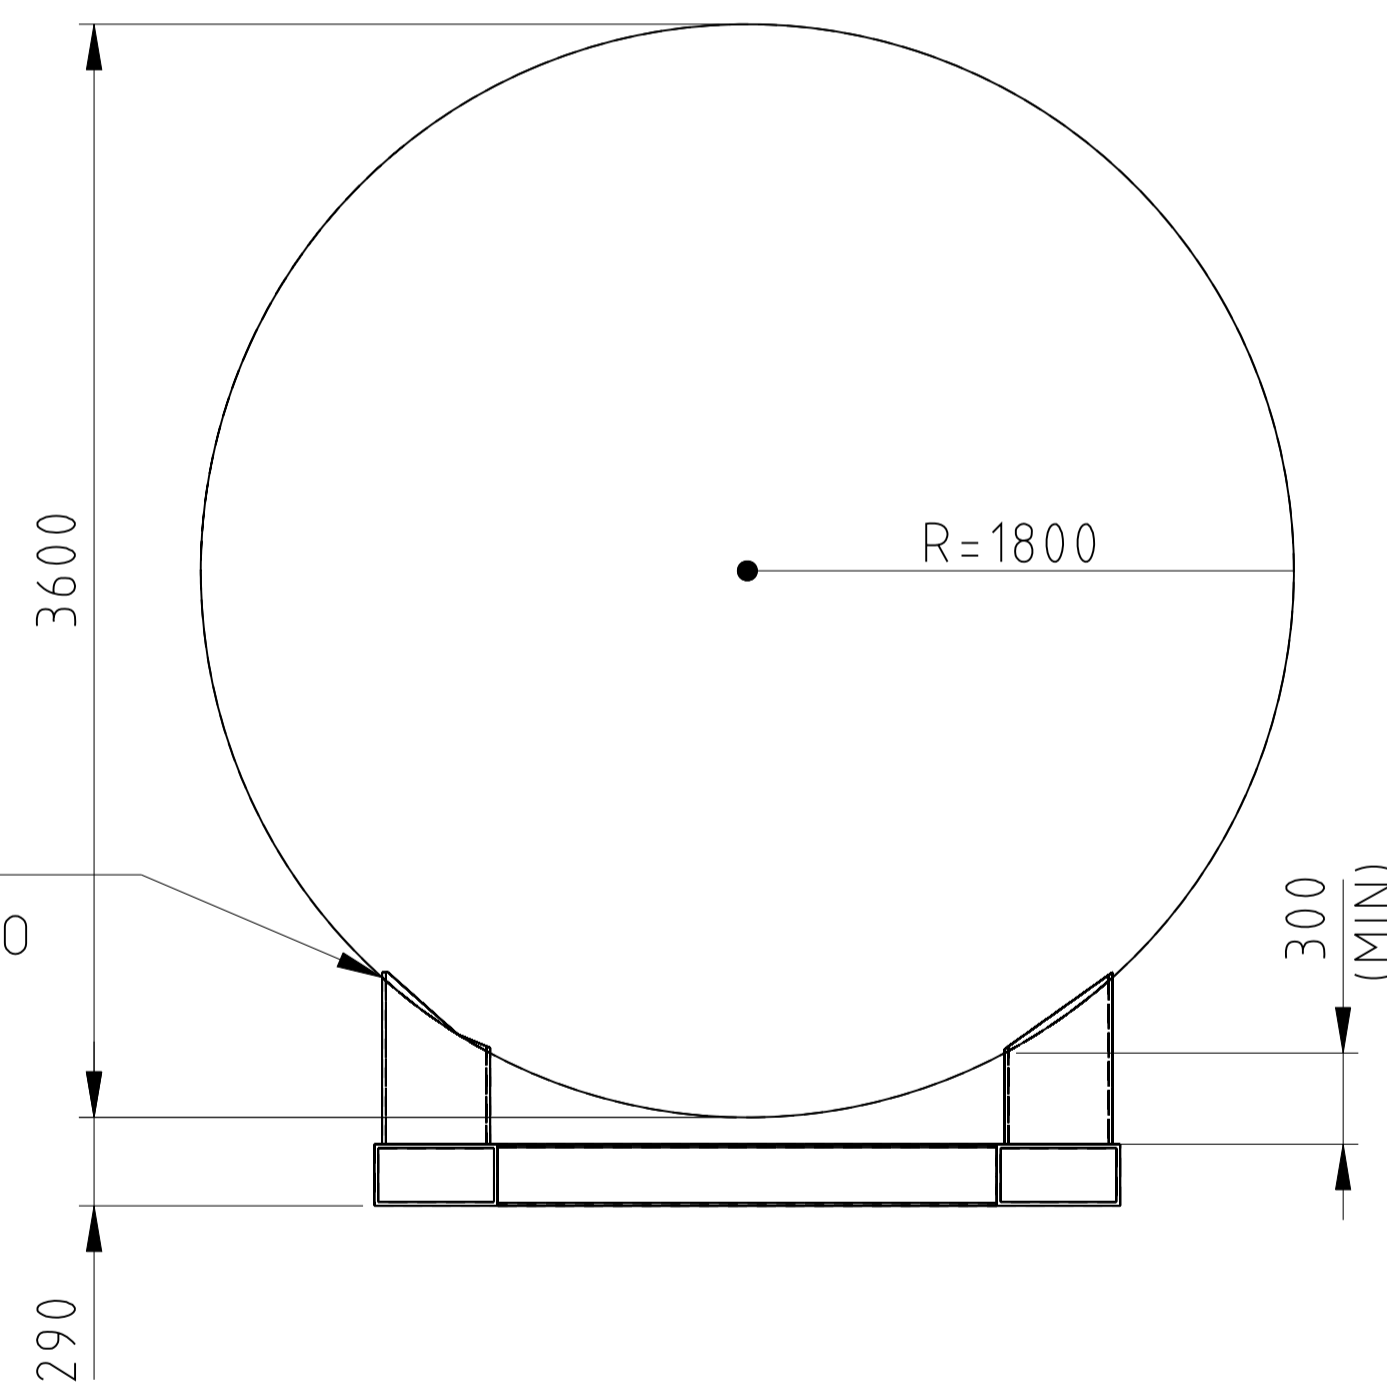

FRONT

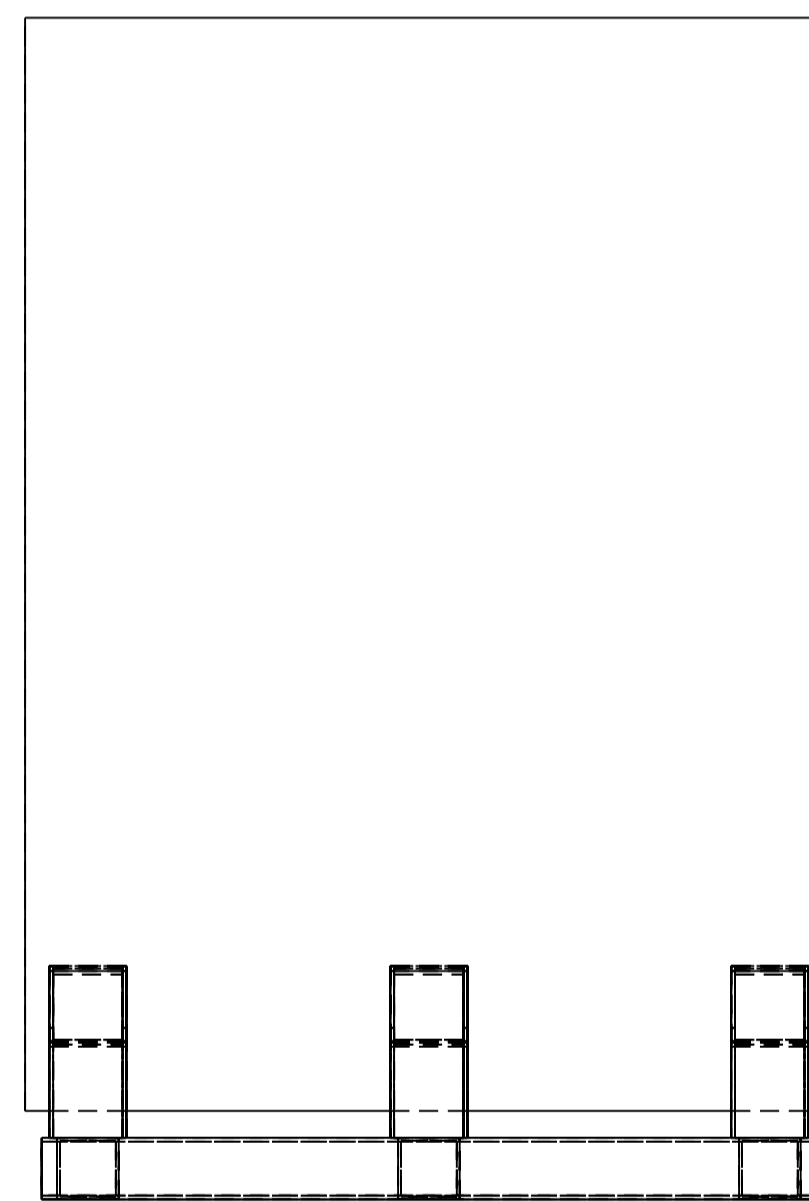

RIGHT

C

MASS OF STRUCTURE = 970kg
 DESIGN LOAD = 35000kg
 TOTAL MASS FOR HANDLING = 35970kg
 CAPACITY = ONE BRUCE B STEAM GENERATOR SEGMENT

FOR DESIGN CRITERIA
 SEE H333000-WP401-10-220-0001

NOT FOR CONSTRUCTION
 This drawing has been reviewed for the purposes of DGR Preliminary Engineering only and must not be used for other purposes.
 Work Package Owner

Parryl Watson

Area Lead
 Digitally signed by M R Dawborn
 Reason: On behalf of Glen Davidge
 Date: 2009.10.28 10:47:46 -04'00'

Engineering Manager
 Sherwin Aarons
 2009.10.28 10:12:16 -04'00'

Project Manager
 Digitally signed by M R Dawborn
 Date: 2009.10.28 10:47:52 -04'00'

Accepted by Owner
 R.J. Heystee
 2009.10.30 16:26:29 -04'00'

NOT FOR CONSTRUCTION


				00 APPROVED FOR USE			GRD	SAA	2009-10-22
NO.	DESCRIPTION	CHK'D	APP'D	DATE	NO.	ISSUE FOR	AUTH. BY	DATE	
REVISIONS				ISSUE AUTHORIZATION					

DESIGNED BY D. BHATTAL DATE 2009-09-24	DRAWN BY K. BUSHEY DATE 2009-09-24
CHECKED BY	DISCIP. ENGR.
DATE PROJ. MGR.	DATE PROJ. ENGR.
DATE	DATE


HATCH

SCALE
NTS
OR AS NOTED


NWMO DEEP GEOLOGIC REPOSITORY PROJECT	
GENERAL ARRANGEMENT SUPPORT FRAME BRUCE B STEAM GENERATOR SEGMENT	
DRAWING NO. H333000-WP401-35-042-0004	SHT. REV. 00

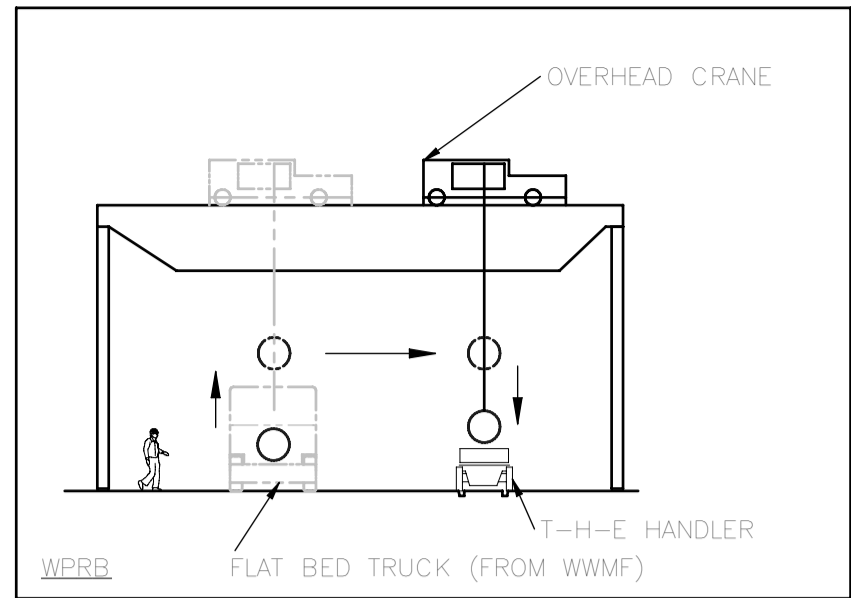


1) OVERHEAD CRANE UNLOADS T-H-E TRANSFER BELL FROM FLAT-BED TRUCK AND LOADS T-H-E HANDLER INSIDE THE WPRB.

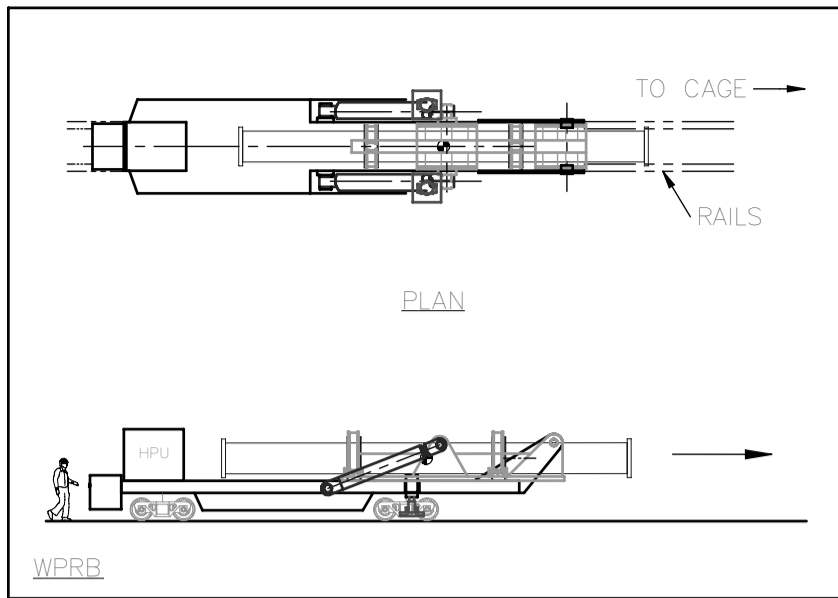


2) THE TRANSFER BELL IS SECURED TO THE T-H-E HANDLER. THE T-H-E HANDLER DRIVES TOWARD CAGE.

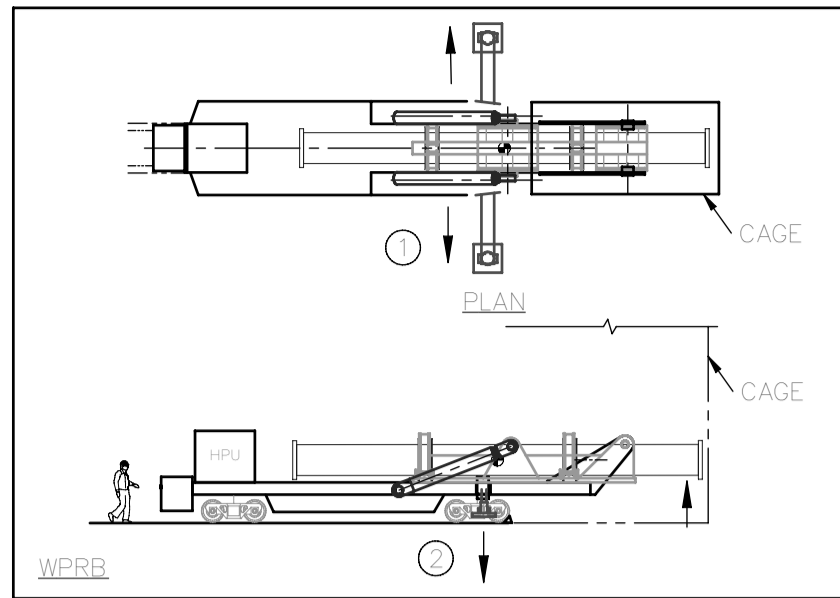


3) WITH END OF TRANSFER BELL INSIDE CAGE, T-H-E HANDLER EXTENDS OUTRIGGER STABILIZERS OUT, THEN DOWN.

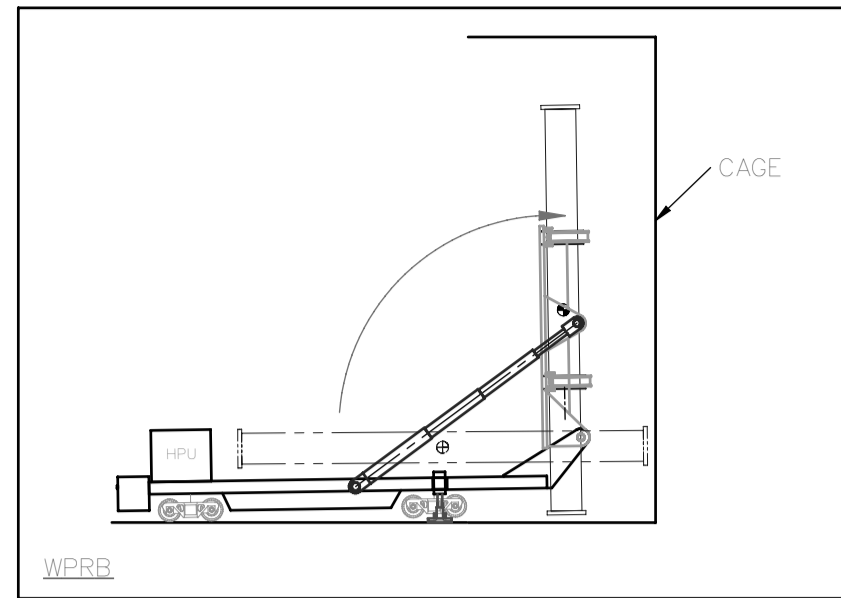


4) TRANSFER BELL IS ROTATED INTO VERTICAL POSITION.

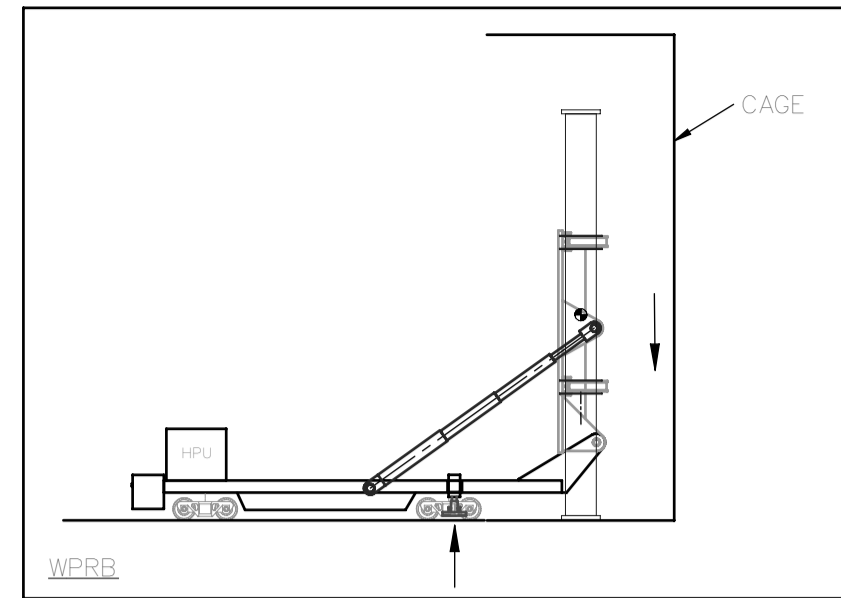


5) T-H-E HANDLER LOWERS TRANSFER BELL ONTO CAGE FLOOR. TRANSFER BELL IS SECURED TO CAGE. (CAGE SECURING HARDWARE NOT SHOWN)

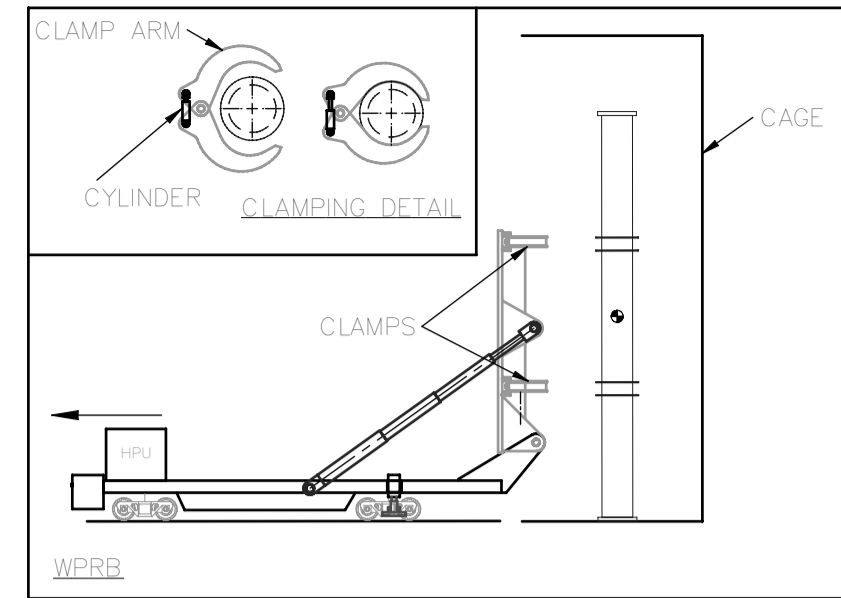


6) T-H-E HANDLER RELEASES CLAMPS, AND WITHDRAWS FROM CAGE. CAGE DESCENDS TO REPOSITORY LEVEL.

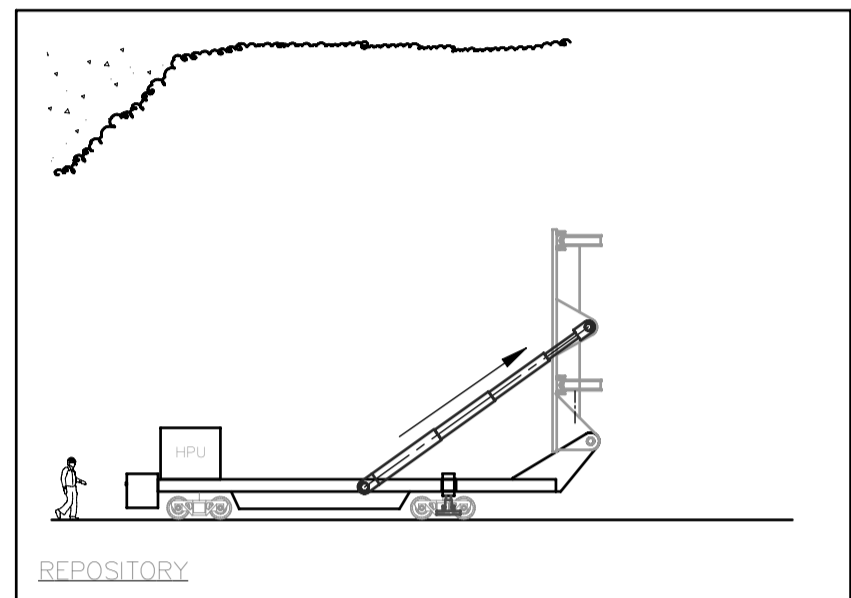


7) T-H-E HANDLER AT REPOSITORY LEVEL EXTENDS MAIN HOISTING CYLINDERS.

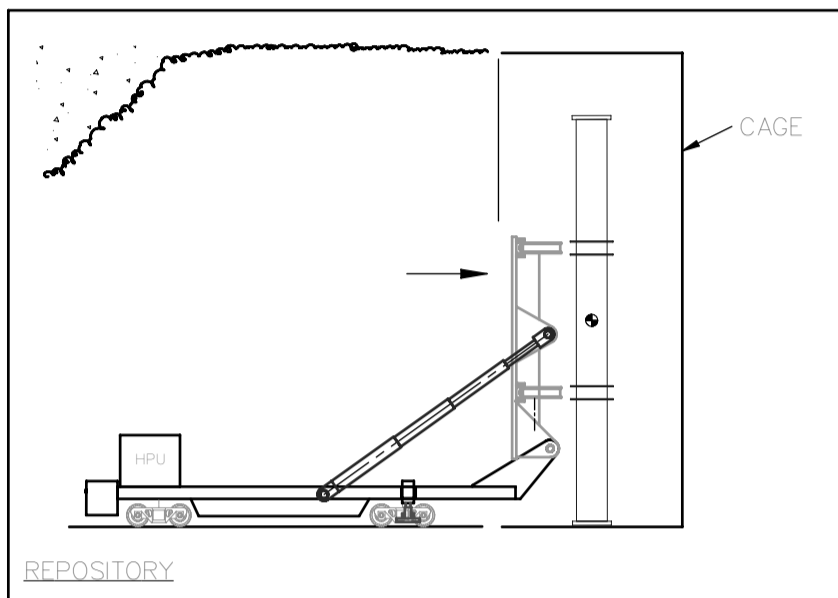


8) CAGE ARRIVES AT REPOSITORY LEVEL. T-H-E HANDLER APPROACHES CAGE TO LOCATE CLAMPS AROUND TRANSFER BELL COLLARS.

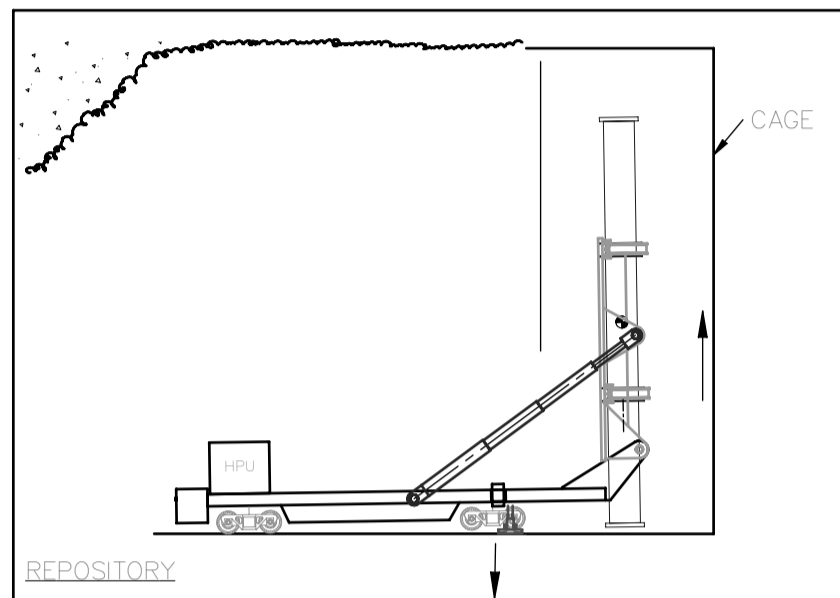


9) T-H-E HANDLER LIFTS TRANSFER BELL WITH OUTRIGGER STABILIZERS

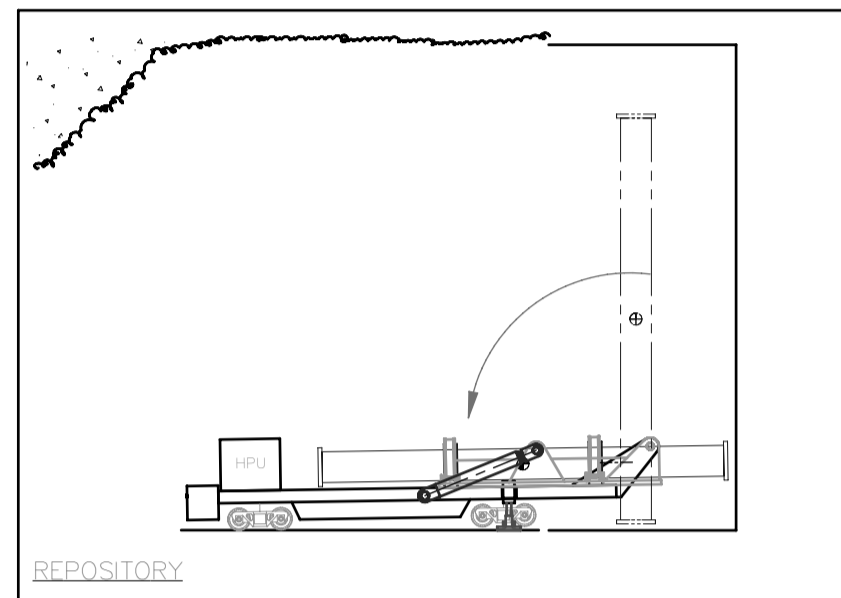


10) T-H-E HANDLER ROTATES TRANSFER BELL INTO HORIZONTAL POSITION.

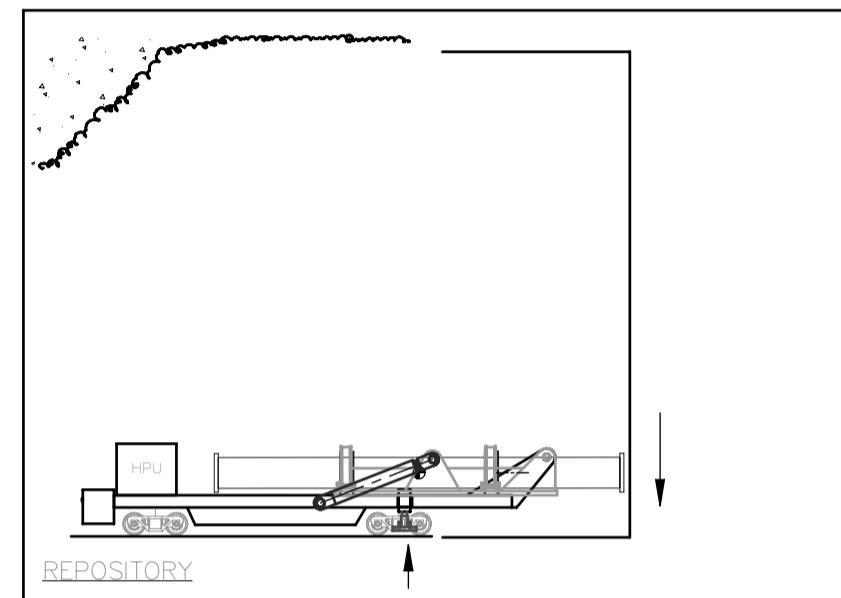


11) T-H-E HANDLER RETRACTS OUTRIGGER STABILIZERS, AND DRIVES AWAY FROM CAGE.

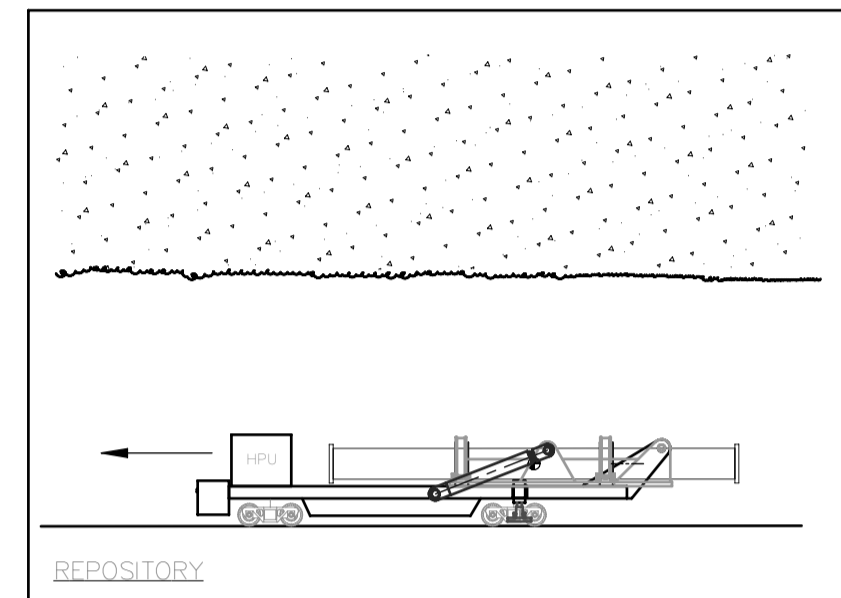


12) T-H-E HANDLER TRANSPORTS TRANSFER BELL (IN HORIZONTAL POSITION) ALONG RAILS TOWARD EMPLACEMENT ROOM.

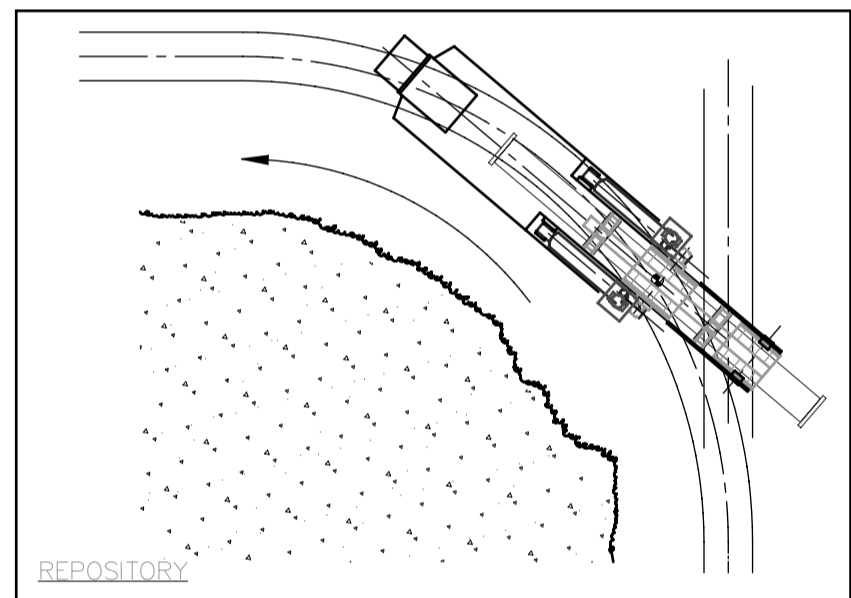


13) T-H-E HANDLER ENTERS EMPLACEMENT ROOM BY FOLLOWING CURVATURE OF RAIL.

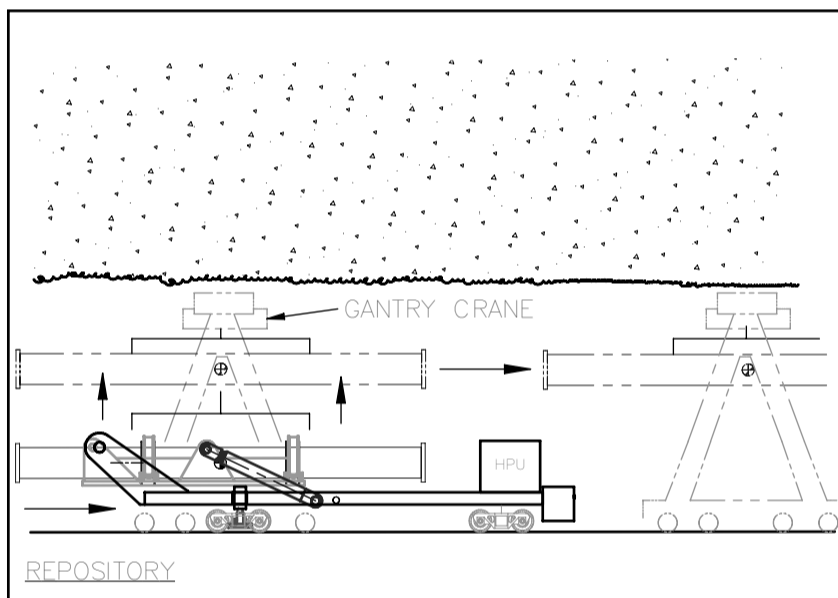


14) GANTRY CRANE REMOVES T-H-E TRANSFER BELL FROM T-H-E HANDLER.

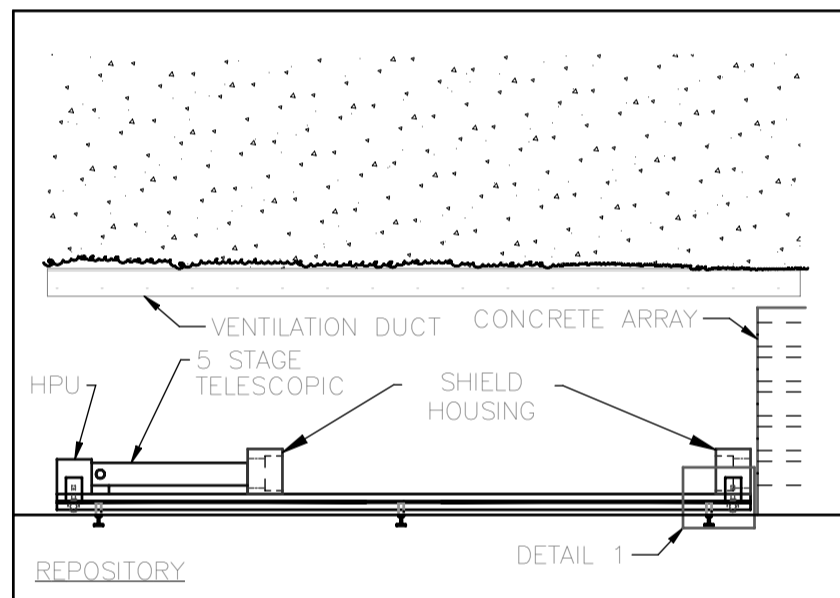


15) AT THE CONCRETE ARRAY LOCATION, HEM ROLLS TO CENTRE OF TRAVERSE RAILS TO PREPARE FOR TRANSFER BELL LOADING.

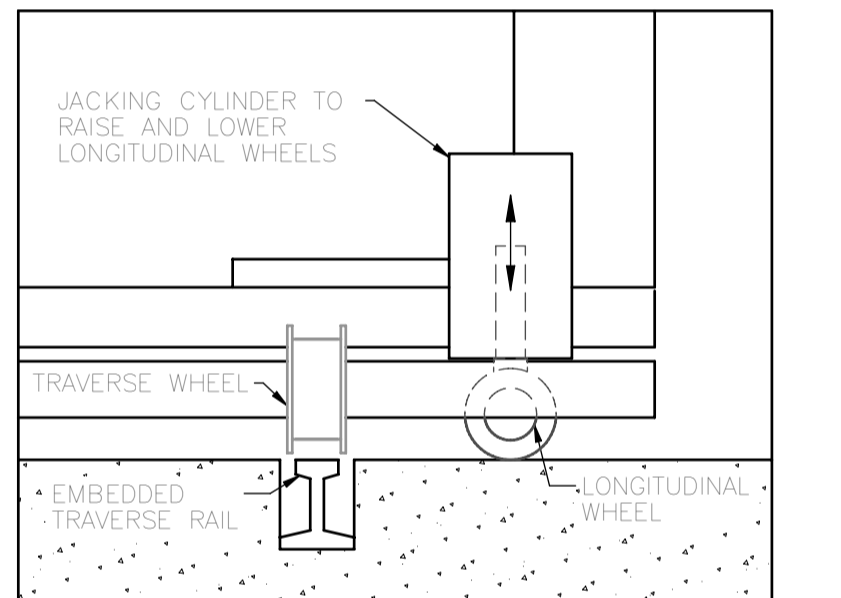


16) GANTRY CRANE (NOT SHOWN) LOWERS TRANSFER BELL ONTO HEM. TRANSFER BELL SUPPORTED ON ROLLERS.

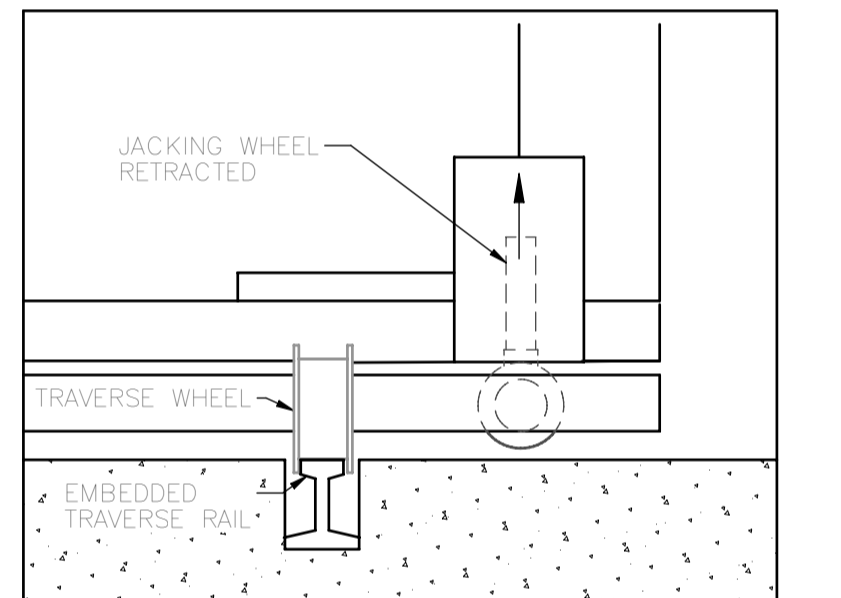


17) SHIELD HOUSINGS ON BOTH ENDS PULLED OVER TRANSFER BELL BY HYDRAULIC CYLINDERS.

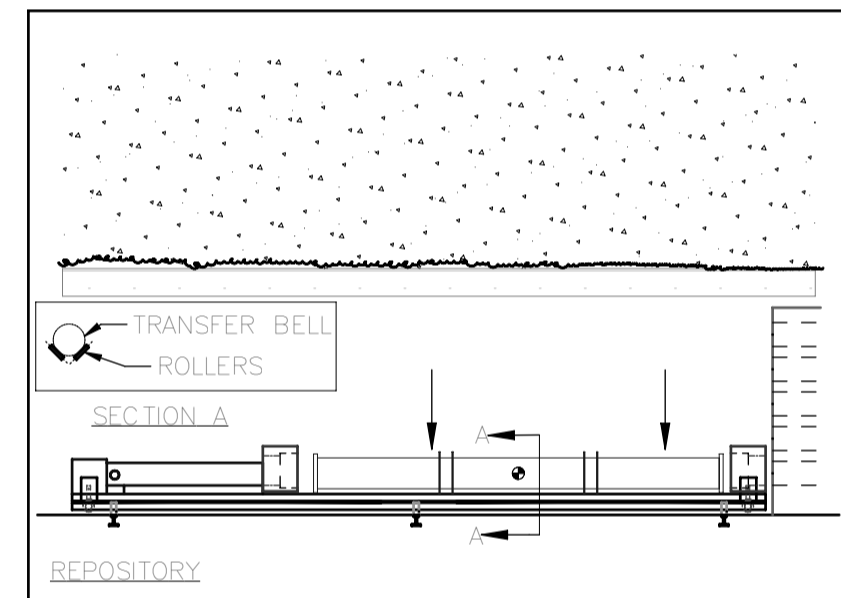


18) HEM MOVES ALONG TRAVERSE RAILS TO ITS INTENDED 'X' POSITION.

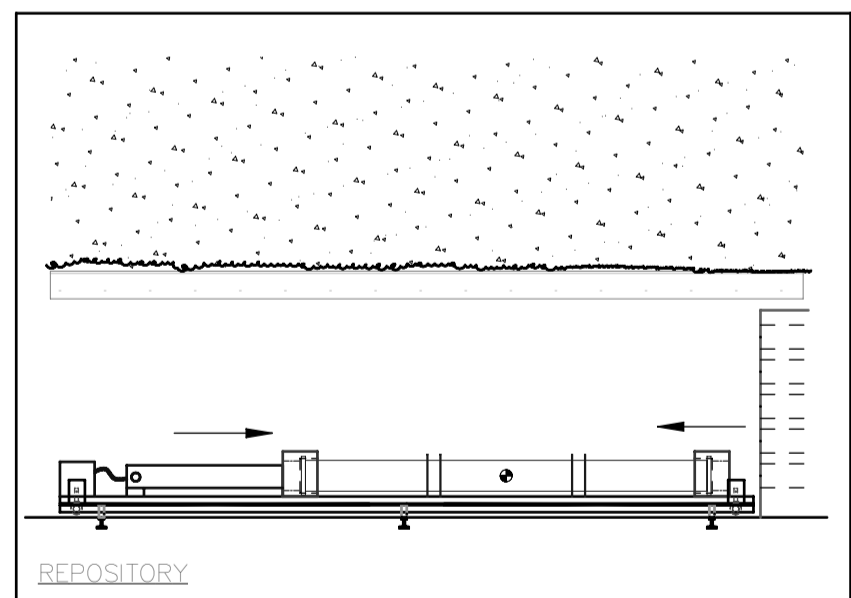


19) HEM IS SECURED TO CONCRETE FLOOR USING PRE-INSTALLED EMBEDDED CLIPS. HEM RISES TO ALIGN TRANSFER BELL WITH CONCRETE DISPOSAL TUBE 'Y' POSITION.

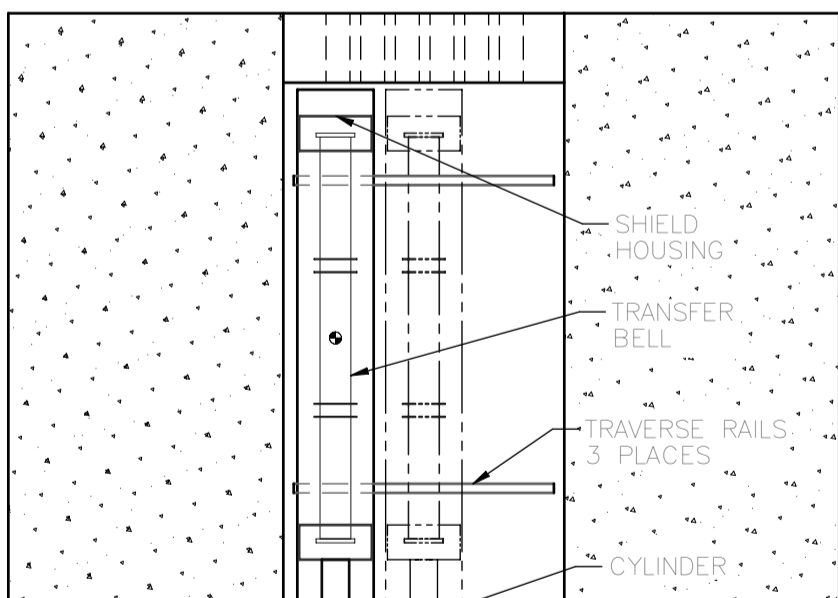


20) FRONT VIEW OF CONCRETE ARRAY AS HEM POSITIONS ITSELF TO EMPLACE T-H-E LINER.

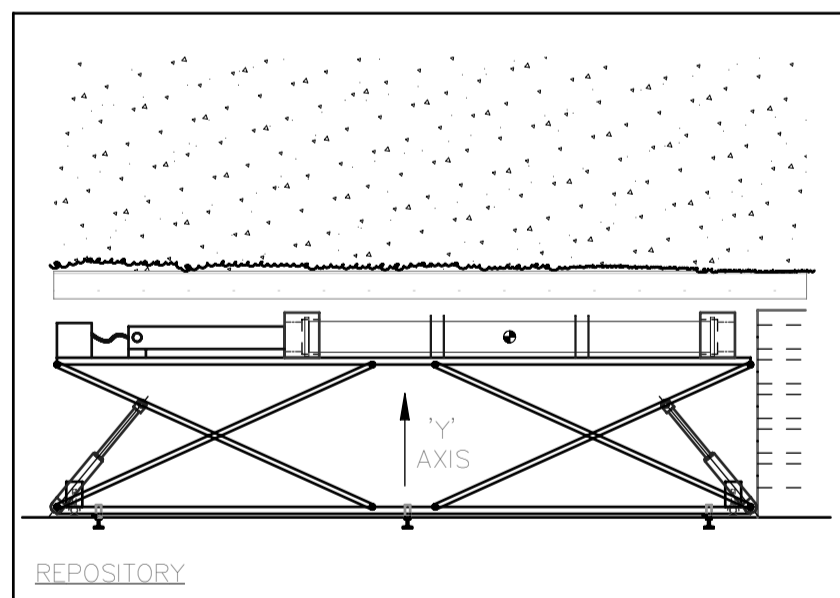


21) HYDRAULIC CYLINDERS MOVE SHIELD HOUSINGS AND TELESCOPIC CYLINDER UNTIL FLUSH WITH FACE OF CONCRETE ARRAY. SHIELD HOUSING OPENS END CAPS.

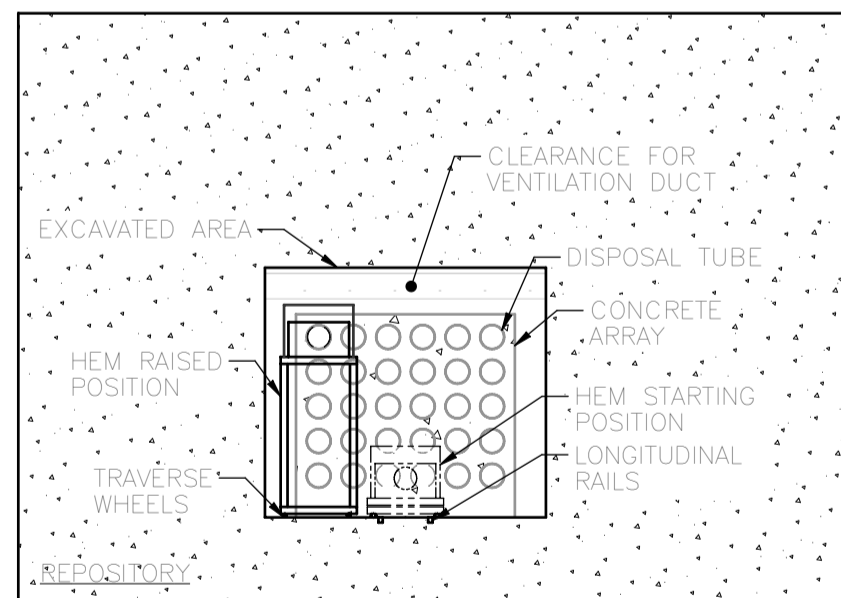

22) 5-STAGE HYDRAULIC CYLINDER EXTENDS, PUSHING T-H-E LINER THROUGH TRANSFER BELL AND INTO CONCRETE ARRAY. DISPOSAL TUBE IS CAPPED WITH CONCRETE PLUG.

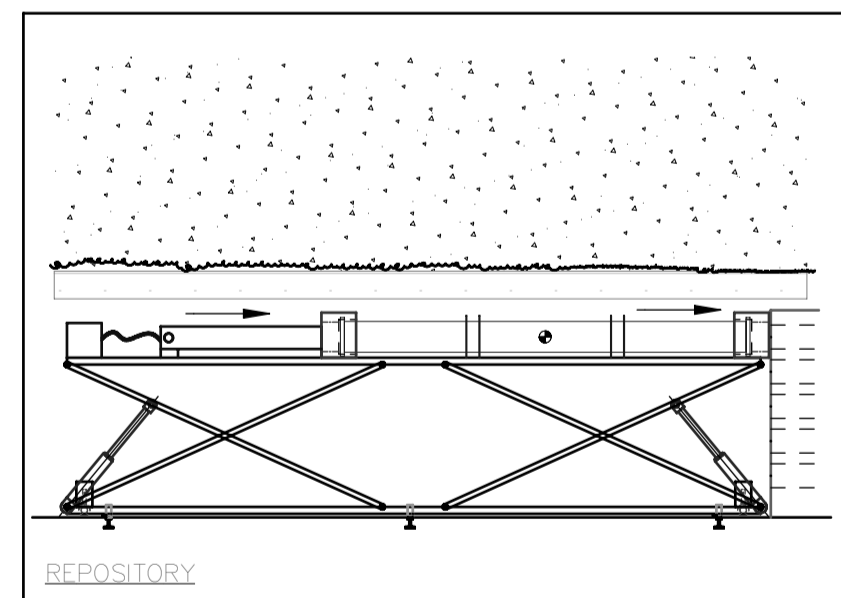

DETAIL 1-A

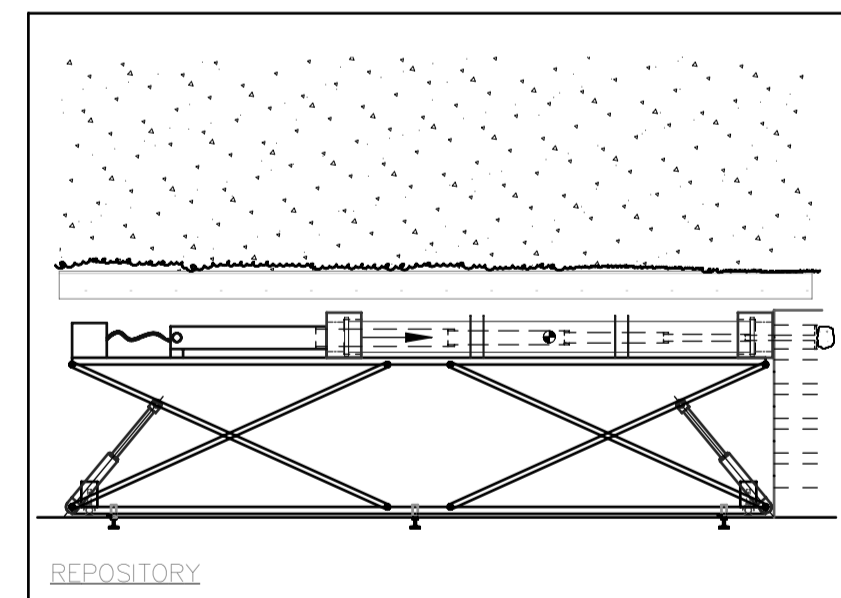

DETAIL 1-B

1. THIS DRAWING IS CONCEPT ONLY. NOT TO BE USED FOR FABRICATION.
2. THIS DRAWING MUST BE READ WITH IN CONJUNCTION FUNCTIONAL DESCRIPTIONS H333000-WP401-50-109-0001 AND H333000-WP401-50-109-0002.

NOT FOR CONSTRUCTION
This drawing has been reviewed for the purposes of DGR Preliminary Engineering only and must not be used for other purposes.
Work Package Owner

Area Lead
G.R. Danzig
Digitally signed by G.R. Danzig
Date: 2009.09.15 14:22:14 -0400

Engineering Manager
Sherwin Aarons
2009.09.15 18:16:03 -0400

Project Manager
Digitally signed by M.D. Dawson
Date: 2009.09.17 11:13:54 -0400

Accepted by Owner
R.J. Hayes
2009.09.24 19:29:25 -0400



DESIGNED BY
G. HOLOHAN/I. AHMAD
DATE 2009-09-15

DRAWN BY
G. HOLOHAN/I. AHMAD
DATE 2009-09-15

CHECKED BY
DISCIPL. ENGR.

DATE
PROJ. DES. COORD.
DATE
PROJ. ENGR.

NUCLEAR WASTE MANAGEMENT ORGANIZATION
DEEP GEOLOGIC REPOSITORY PROJECT

T-H-E HANDLING CONCEPT STORY BOARD
GENERAL ARRANGEMENT

SCALE
N.T.S.
OR AS NOTED

DWG. NO.
H333000-WP401-50-042-0001

REV.
00


CONCEPT ONLY
NOT FOR FABRICATION
This Illustration for
Information Purposes Only

DRAWING NO. DRAWING TITLE

Table with columns: NO., DESCRIPTION, CHK'D, APP'D, DATE

Table with columns: REV., APPROVED FOR USE, ISSUE FOR, AUTH., BY, DATE

- NOTES:
- FOR REFUGE STATION FUNCTIONAL SPECIFICATION SEE H333000-WP402-20-109-0001.
 - THIS ARRANGEMENT APPLIES TO BOTH REFUGE STATIONS.
 - CAPACITY: 25 PERSONS


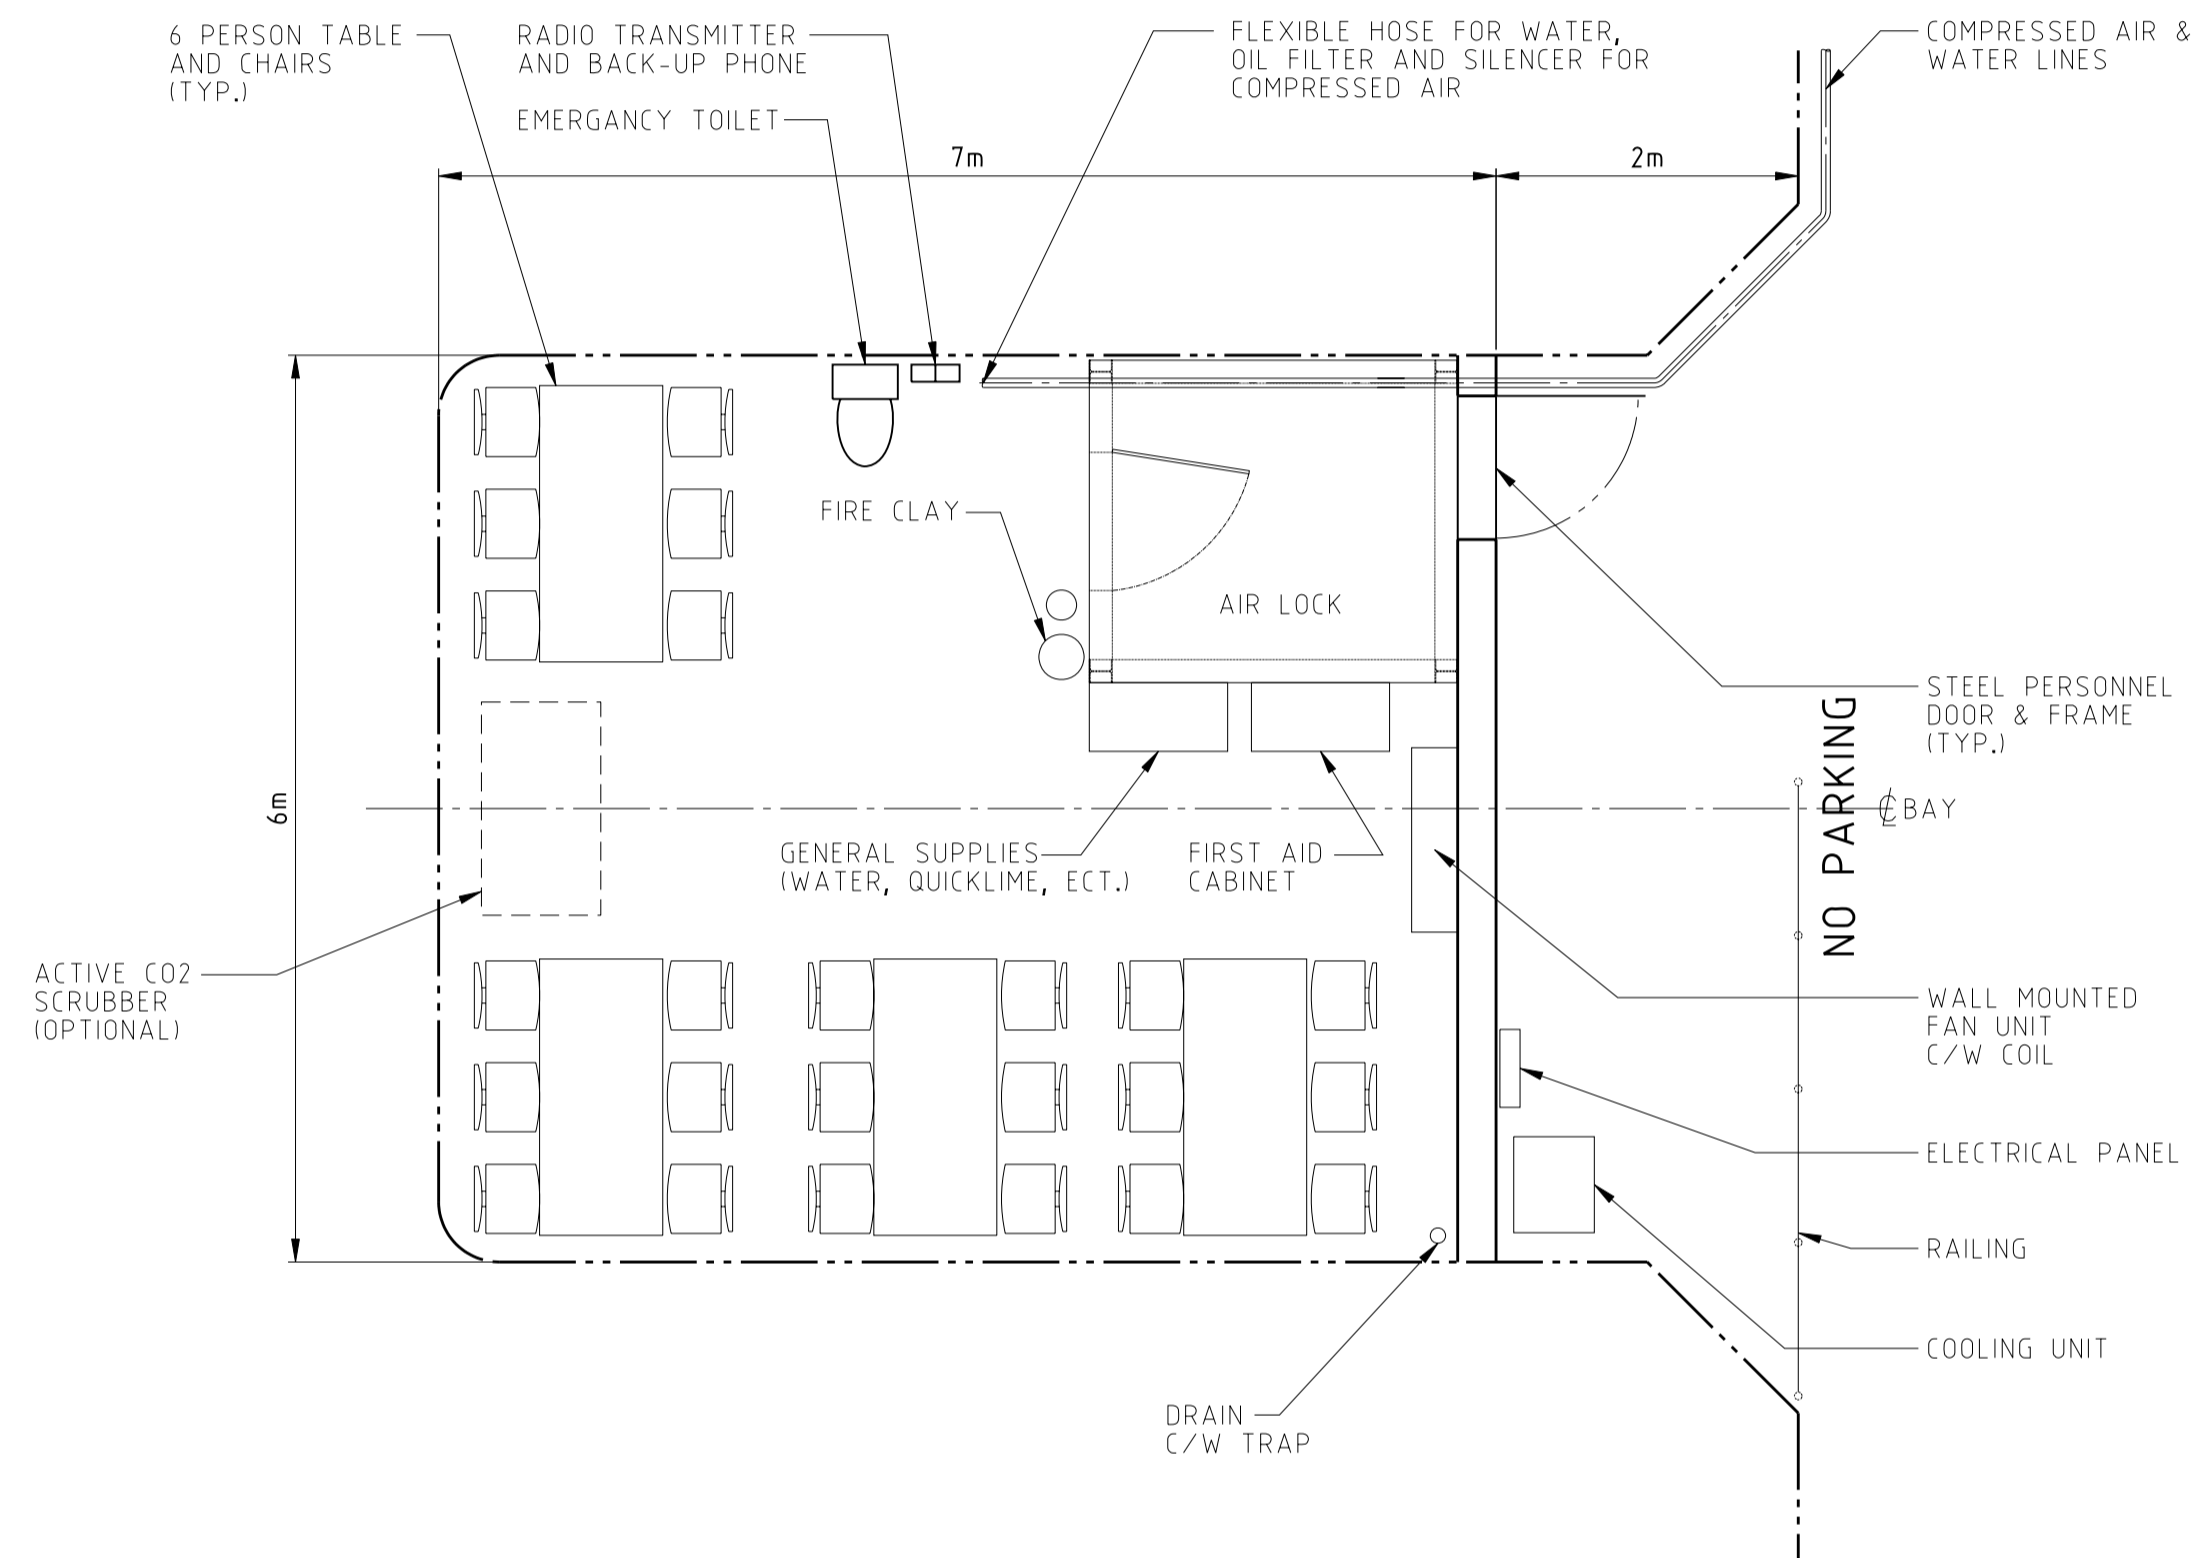


REFUGE STATION
 (TYP.)

PRELIMINARY
NOT FOR CONSTRUCTION

DRAWING NO.		DRAWING TITLE		NO.		DESCRIPTION		CHK'D		APP'D		DATE		NOT FOR CONSTRUCTION This drawing has been reviewed for the purposes of DGR Preliminary Engineering only and must not be used for other purposes. Work Package Owner Area Lead G.R. Davy Digitally signed by G.R. Davy Date: 2009.11.26 17:18:58 +05'00' Engineering Manager Sherwin Asens Date: 2009.11.27 11:15:31 +05'00' Project Manager Digitally signed by M.R. Dawborn Date: 2009.11.30 14:28:09 +05'00' Accepted by Owner R.J. Heyslee Date: 2009.12.03 16:18:49 +05'00'		HATCH DESIGNED BY B. PERRY DATE 09.10.09 CHECKED BY DATE 09.10.09 DATE PROJ. DES. COORD. DATE DRAWN BY K. BUSHEY DATE 09.10.09 DISCIPLIN. ENGR. DATE PROJ. ENGR. DATE		NUCLEAR WASTE MANAGEMENT ORGANIZATION DEEP GEOLOGIC REPOSITORY PROJECT PRELIMINARY DESIGN UNDERGROUND PERMANENT REFUGE STATIONS GENERAL ARRANGEMENT		SCALE 1:50 OR AS NOTED	DWG. NO. H333000-WP402-05-042-0001	REV. 00
REFERENCE DRAWINGS				REVISIONS				ISSUE AUTHORIZATION				00 APPROVED FOR USE AB SAA 2009-11-25 DATE PROJ. MGR. M.R. DAWBORN DATE										


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 11/25/2009 2:25:59 PM
 bushe5169

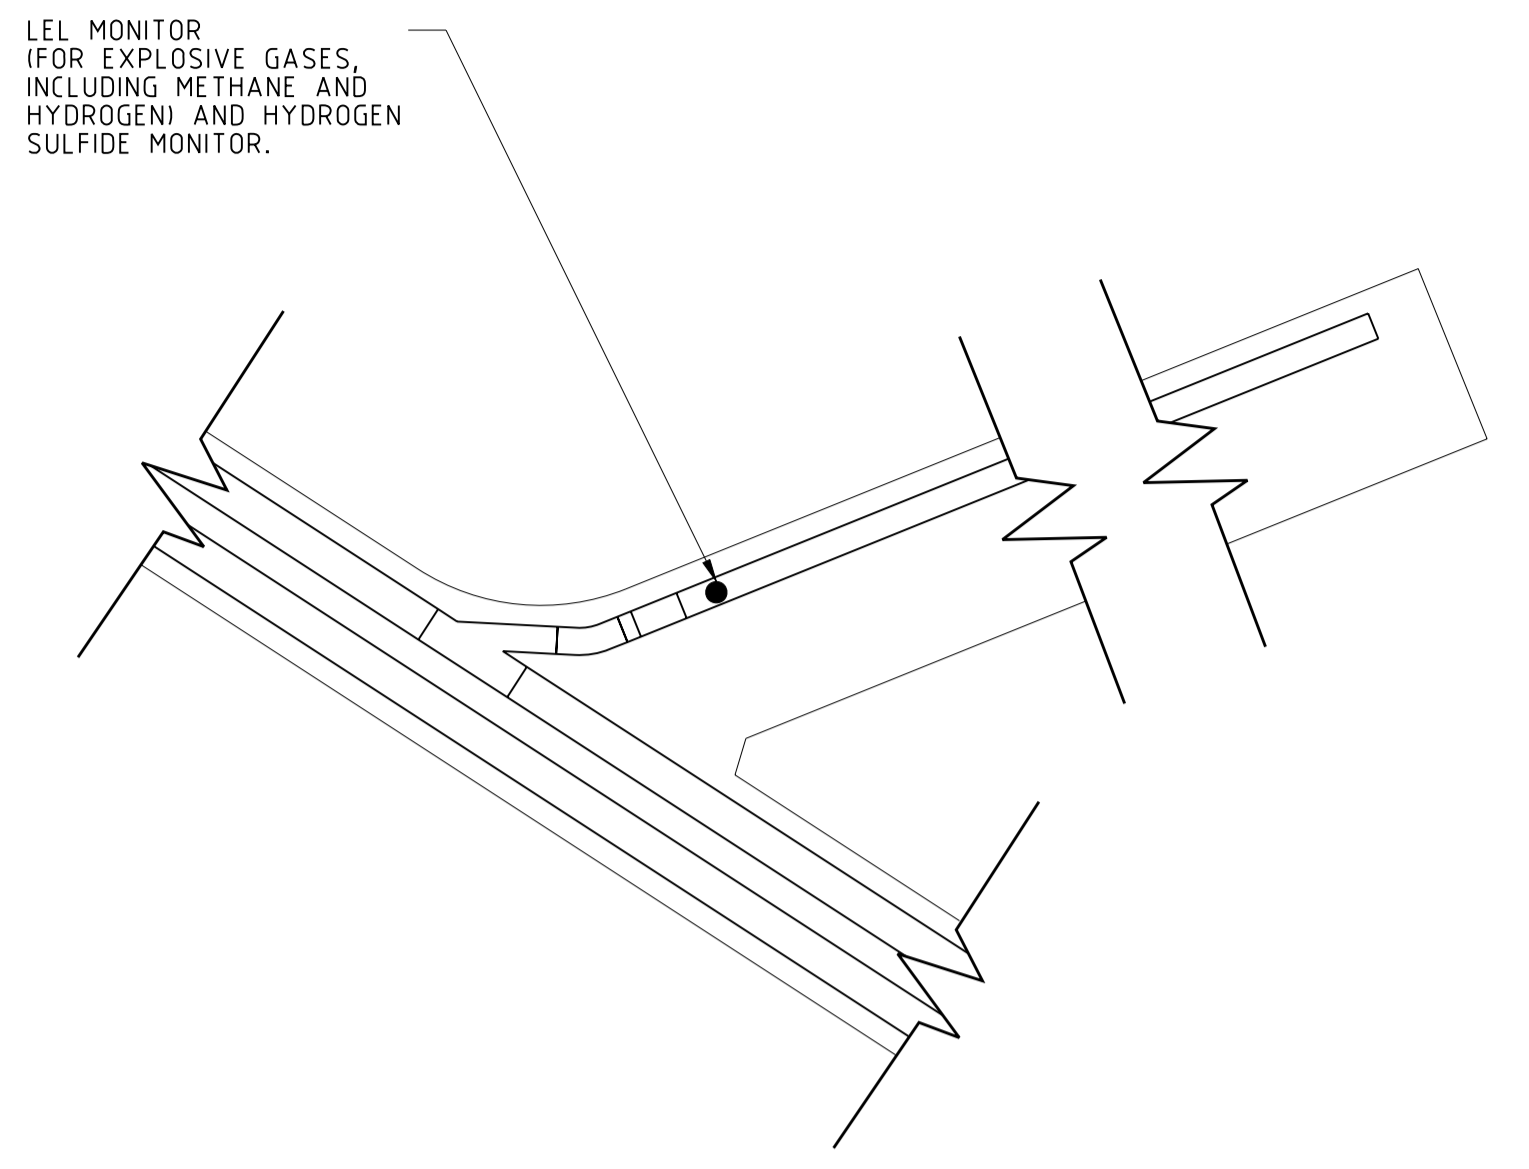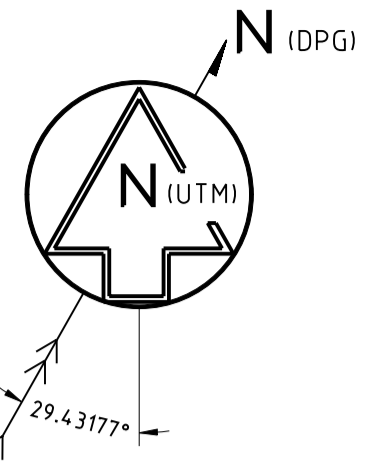

TYPICAL EMPLACEMENT ROOM DETAIL
 (NTS)

- NOTES:
1. THE INTAKE AIR PLENUM ON SURFACE WILL BE MONITORED FOR CARBON MONOXIDE, WET BULB TEMPERATURE AND DRY BULB TEMPERATURE.
 2. ADDITIONAL CARBON MONOXIDE DETECTORS WILL BE INSTALLED AS PART OF THE FIRE DETECTION SYSTEM, INCLUDING IN THE EMPLACEMENT ROOM EXHAUST DUCTS AND THROUGHOUT THE SERVICES AREA.
 3. MONITORING FOR RADIOACTIVITY (e.g. RADON, TRITIUM, AND C-14) WILL LIKELY BE REQUIRED.

PRELIMINARY
NOT FOR CONSTRUCTION

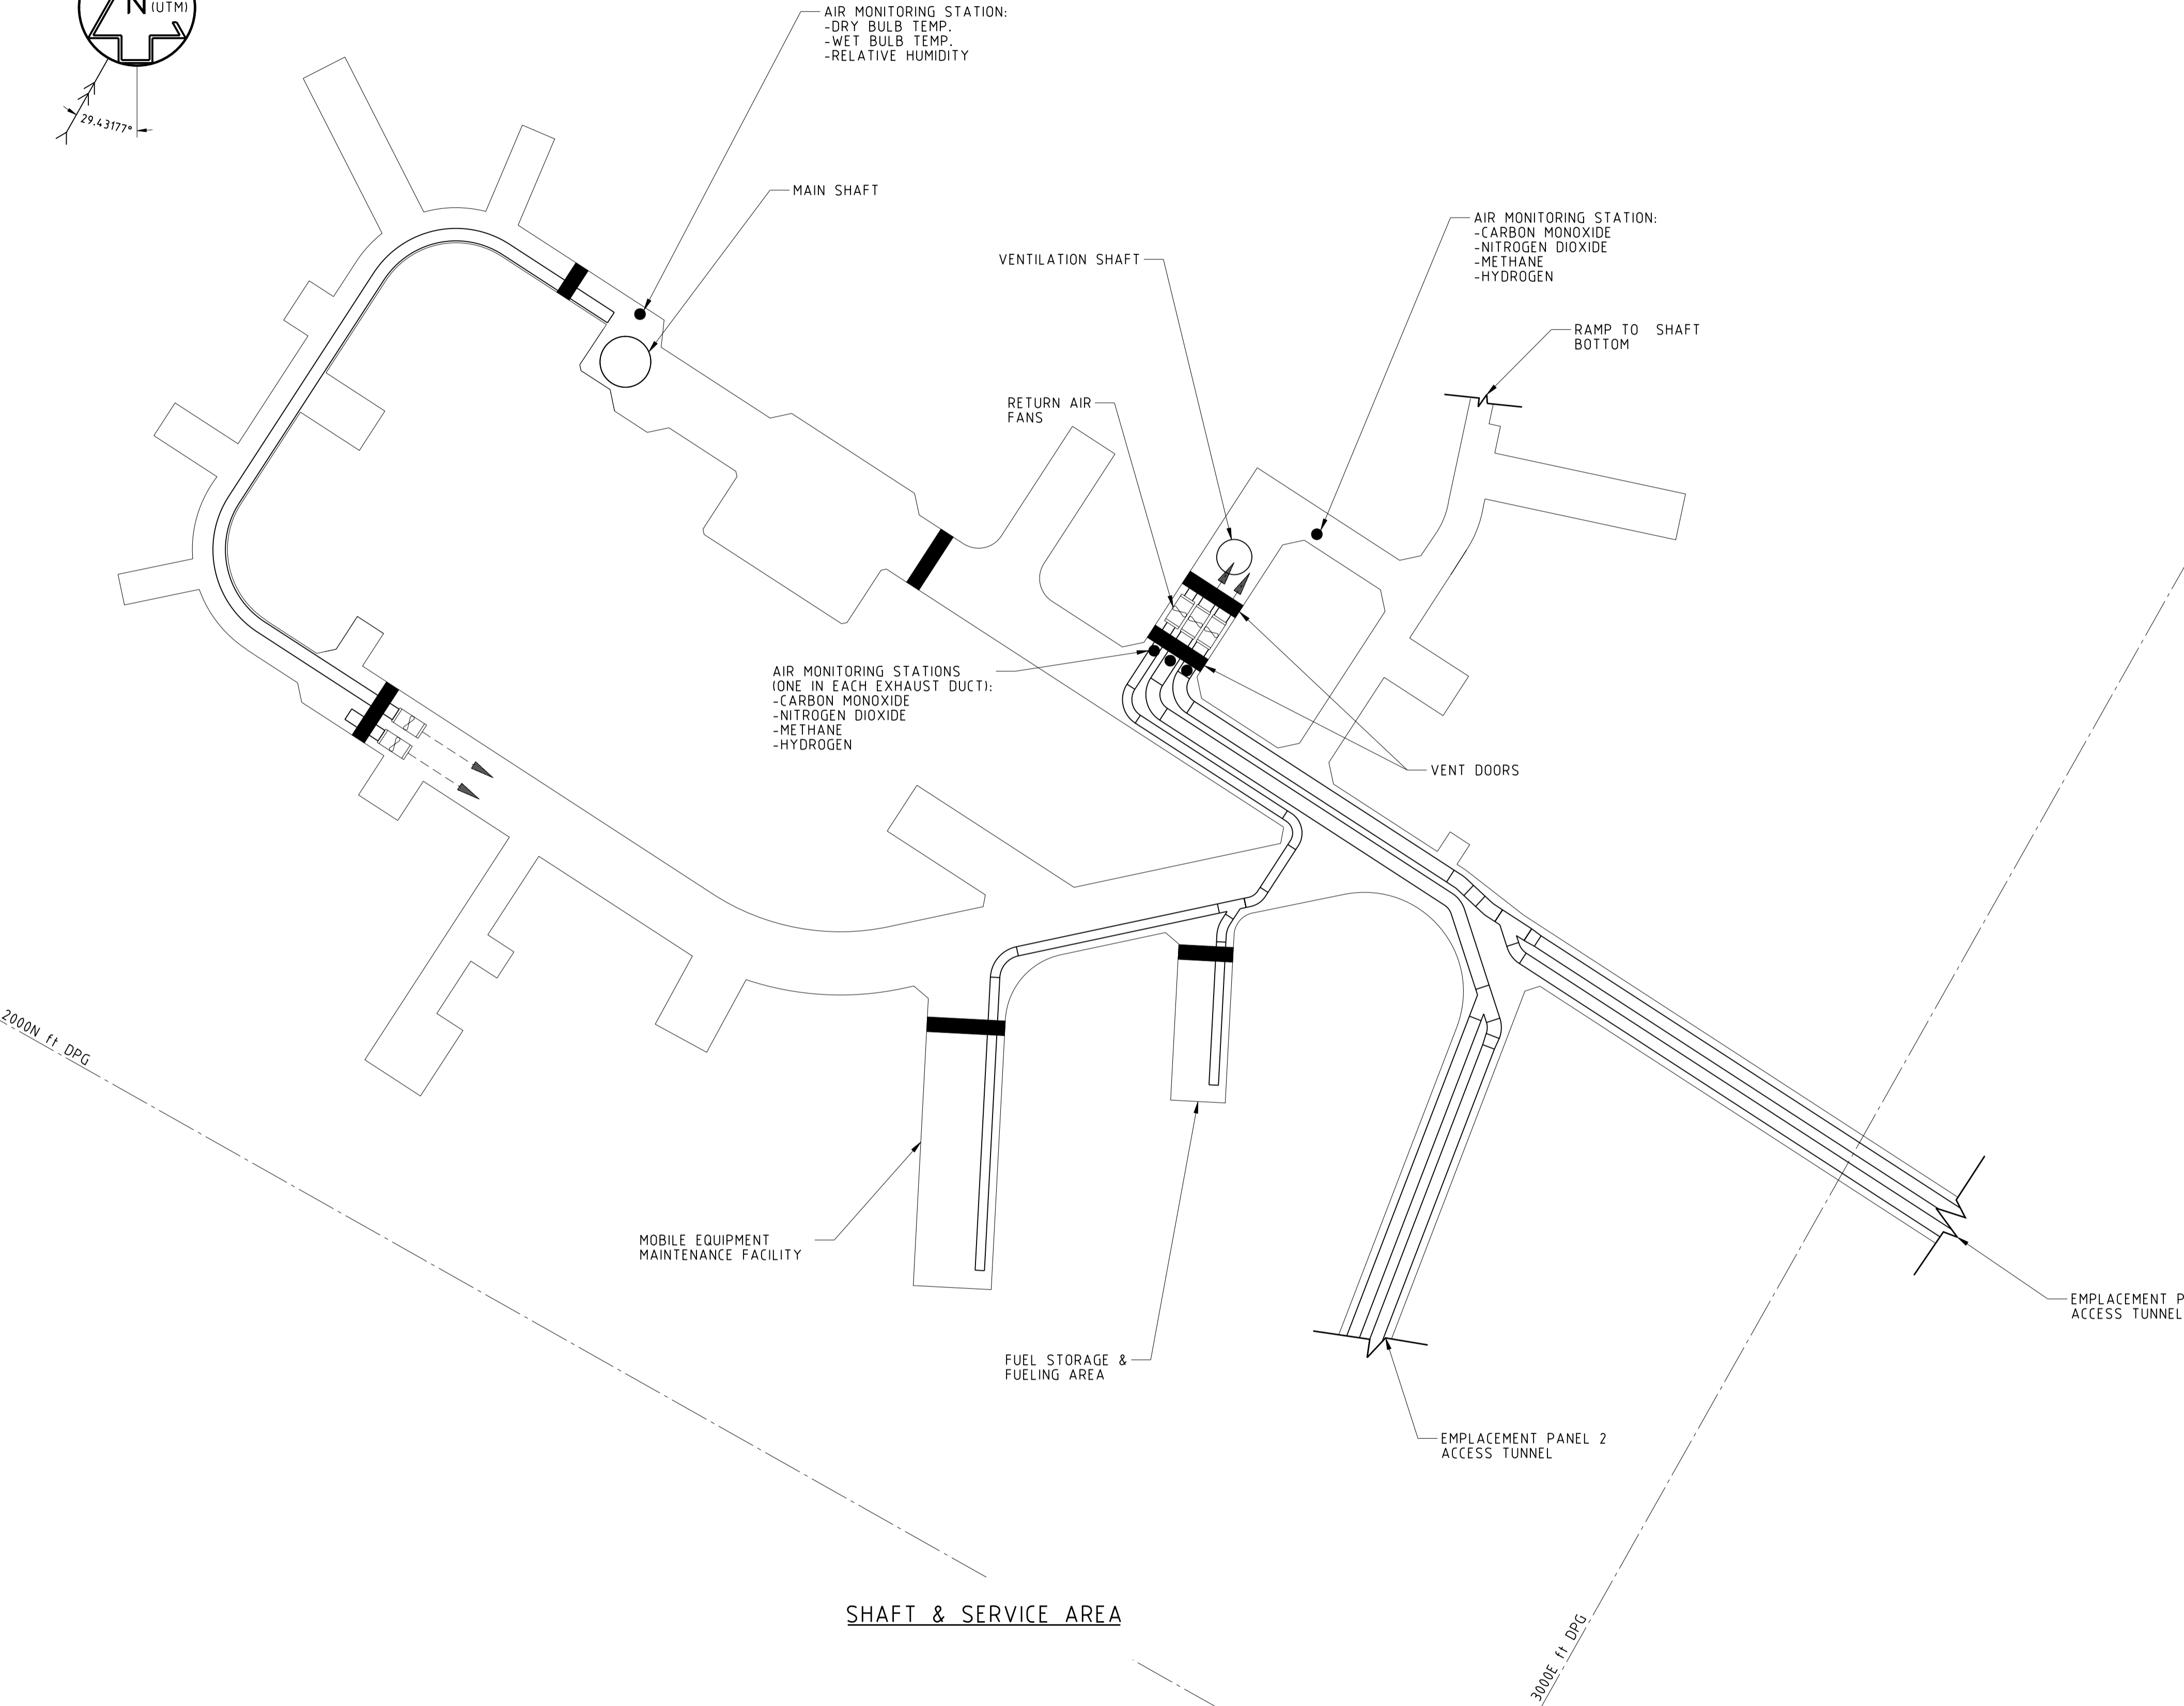

DRAWING NO.	DRAWING TITLE
1	REFERENCE DRAWINGS

NO.	DESCRIPTION	CHK'D	APP'D	DATE
REVISIONS				

NOT FOR CONSTRUCTION
 This drawing has been reviewed for the purposes of DGR Preliminary Engineering only and must not be used for other purposes.
 Work Package Owner
 Area Lead
 G.R. Davidge
 Engineering Manager
 Project Manager
 Accepted by Owner

00 APPROVED FOR USE
 10-01-11
 AB SA

ISSUE AUTHORIZATION

HATCH

DESIGNED BY
 K. HORTIN
 DATE 09-11-26

DRAWN BY
 S. WELLS
 DATE 09-11-26

CHECKED BY
 DISCIPLINE ENGR.

DATE
 PROJ. DES. COORD.

DATE
 PROJ. ENGR.

PROJ. MGR.
 M. DAWBORN
 DATE 2010-01-11

NUCLEAR WASTE MANAGEMENT ORGANIZATION
 DEEP GEOLOGIC REPOSITORY PROJECT

OPERATIONAL SAFETY SYSTEMS


VENTILATION SYSTEM – UNDERGROUND
 AIR QUALITY MONITORING SYSTEM
 GENERAL ARRANGEMENT

SCALE
 1:500
 OR AS NOTED


DWG. NO.
 H333000-WP402-75-042-0001

REV.
 00

H333000-WP403-10-042-0001
ON DWG

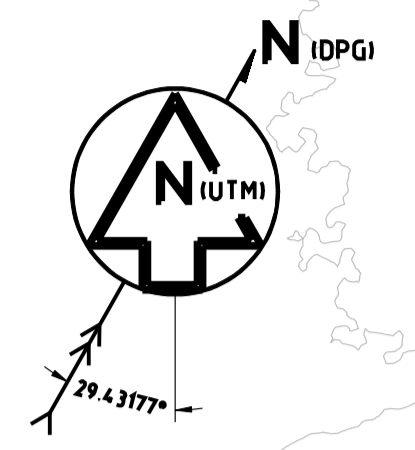

WASTE ROCK
MANAGEMENT AREA
EL. 219.00

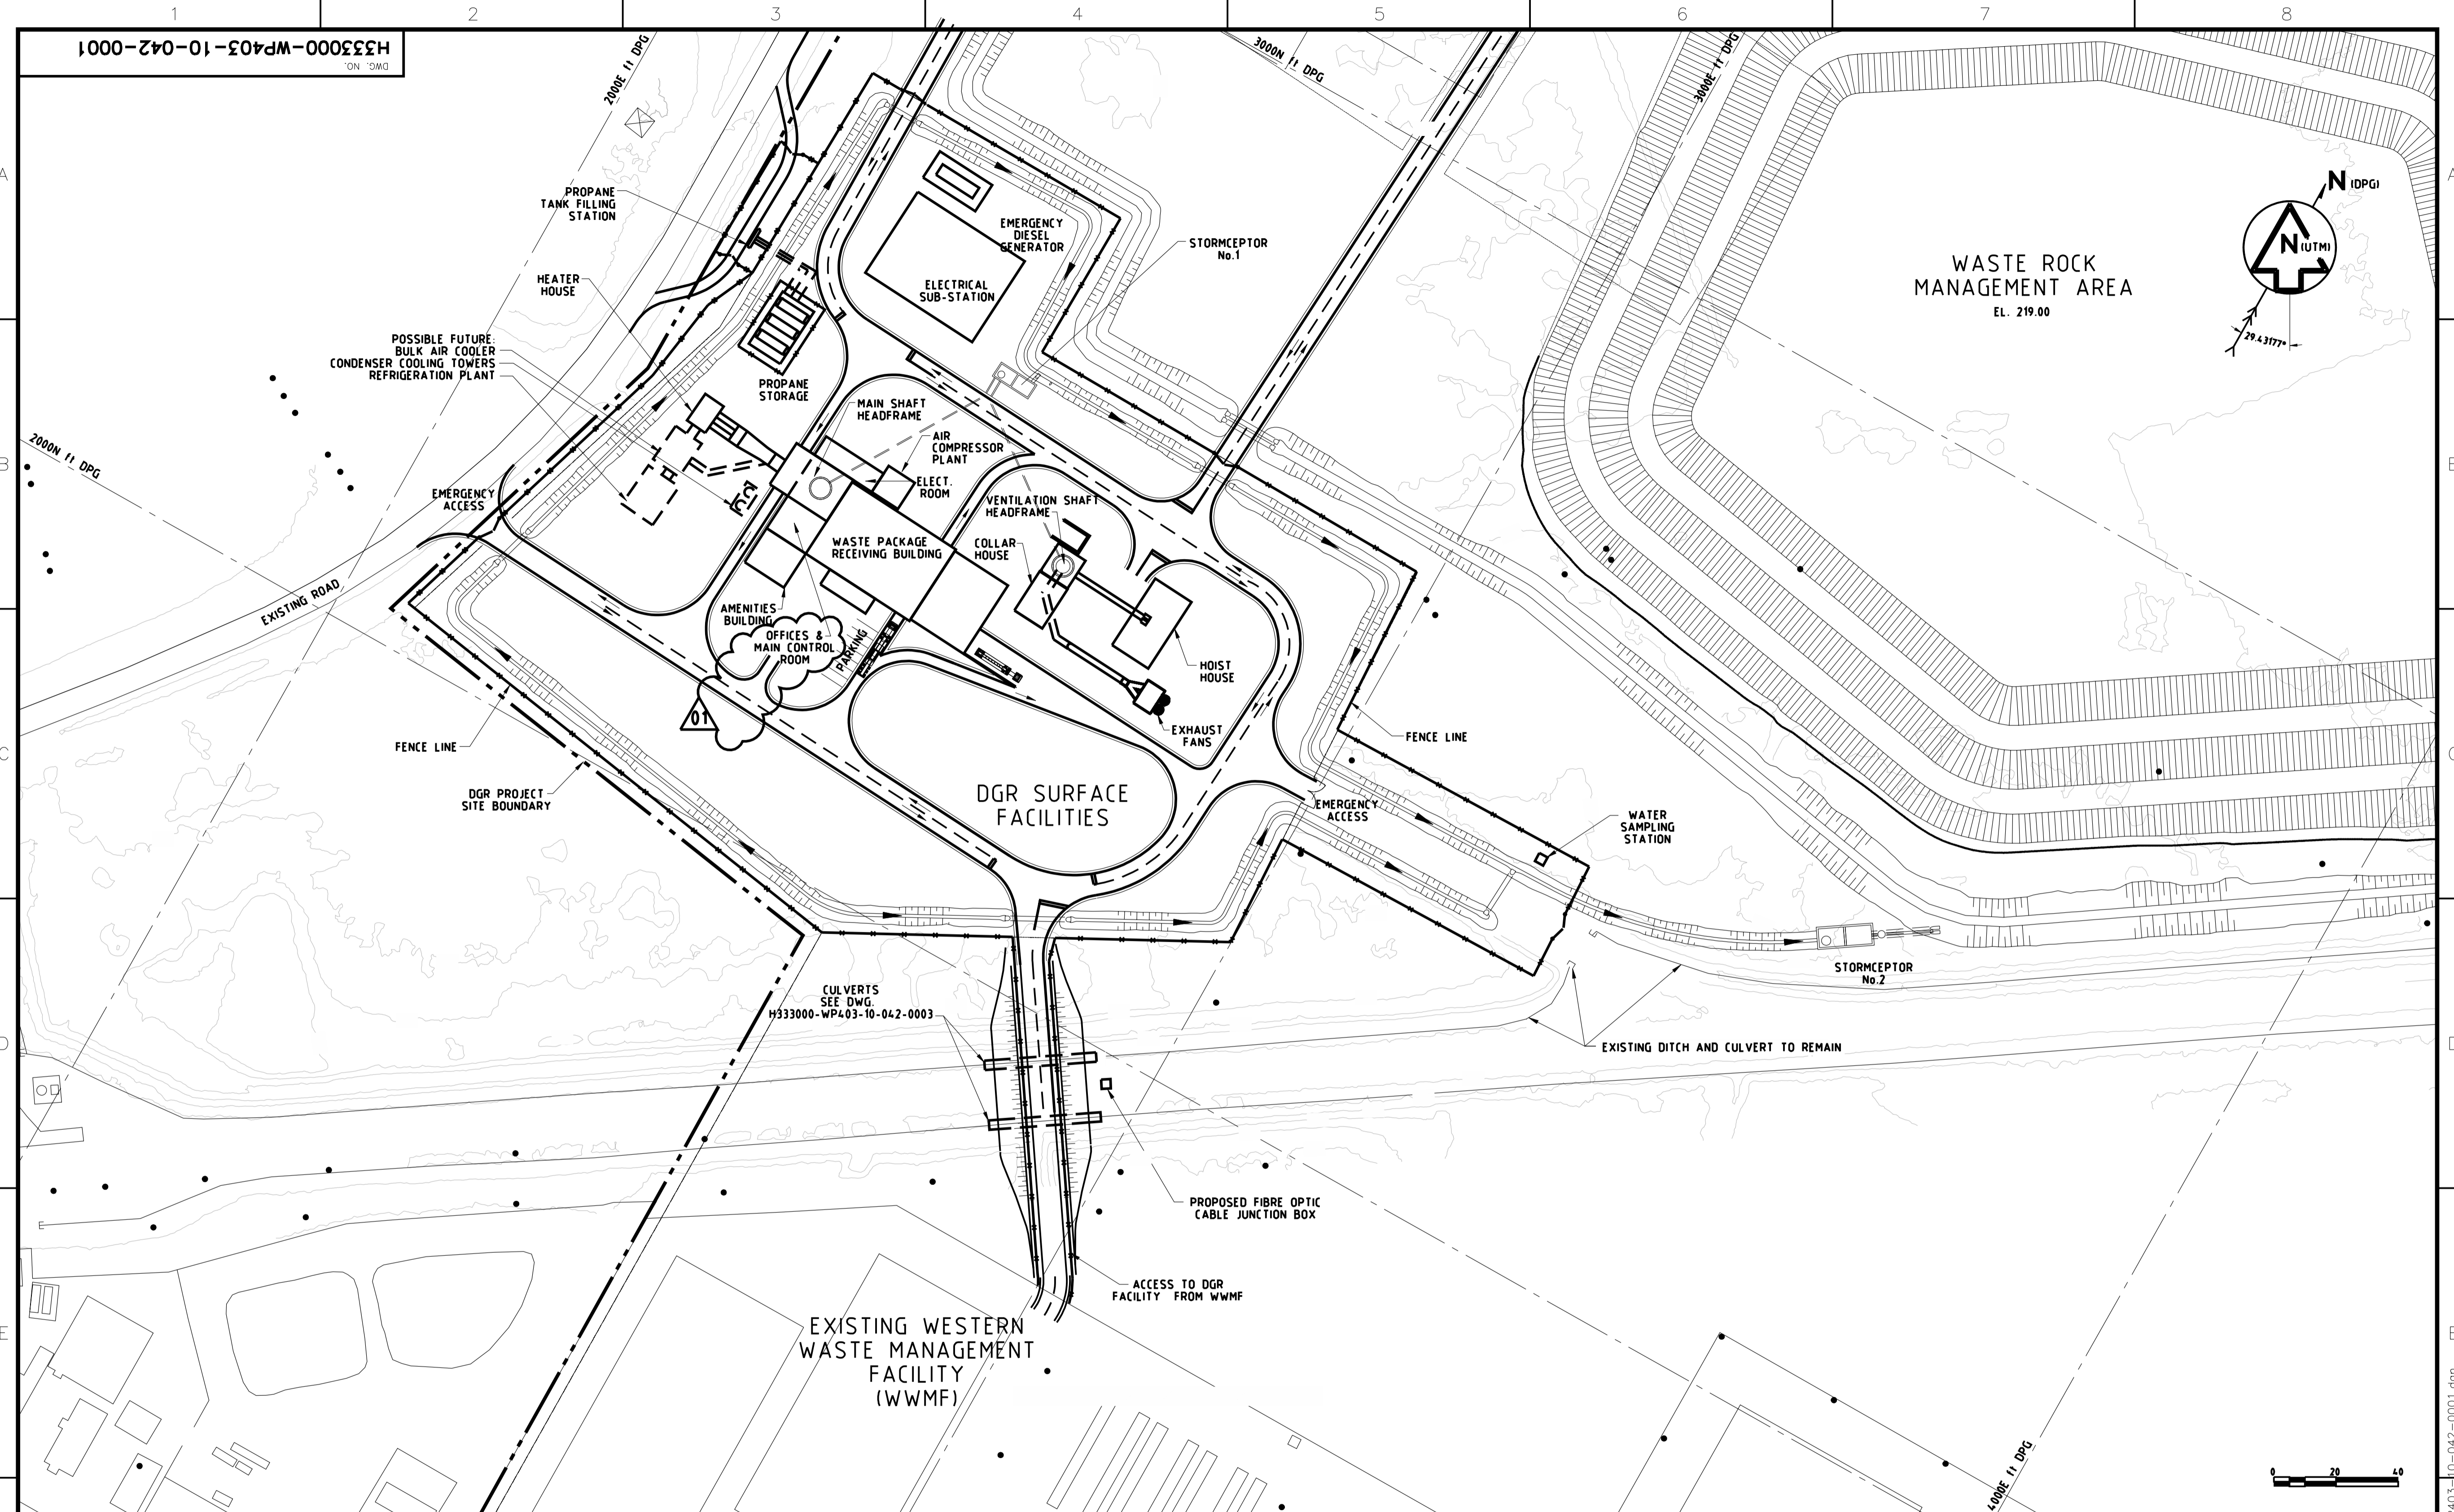

CULVERTS
SEE DWG.
H333000-WP403-10-042-0003

EXISTING WESTERN
WASTE MANAGEMENT
FACILITY
(WWMF)

DGR SURFACE
FACILITIES



NUCLEAR WASTE MANAGEMENT ORGANIZATION
DEEP GEOLOGIC REPOSITORY PROJECT

SHAFT SERVICE FACILITY AREA (SSFA)

OPERATIONS LAYOUT
GENERAL ARRANGEMENT

DESIGNED BY
M. FARRELL
DATE 2009-10-29

DRAWN BY
L. SHIELDS
DATE 2009-10-29

CHECKED BY
M. FARRELL
DATE 2009-12-16

PROJ. DES. COORD.
G. KRAMER
DATE 2009-12-16

PROJ. ENGR.
M. DAWBORN
DATE 2009-11-25

NOT FOR CONSTRUCTION
This drawing has been reviewed for the purposes of DGR Preliminary Engineering only and must not be used for other purposes.
Work Package Owner
Sherwin Adams
2010.04.28 13:55:38 -0400

Area Lead
Engineering Manager
Sherwin Adams
2010.04.28 13:55:46 -0400

Project Manager
Digitally signed by Sherwin Adams
Date: 2010.04.28 14:03:51 -0400

Accepted by Owner
R. J. Haywood
2010.04.27 07:41:10 -0400

NO.	DESCRIPTION	CHK'D	APP'D	DATE
01	WAS OFFICES & CONTROL ROOM	G.K.	S.A.	10-04-29

REV.	ISSUE FOR	AUTH.	BY	DATE
01	APPROVED FOR USE	G.K.	S.A.	10-04-29
00	APPROVED FOR USE	G.K.	S.A.	10-01-11

DRAWING NO.	DRAWING TITLE

REFERENCE DRAWINGS

REVISIONS

ISSUE AUTHORIZATION

SCALE
1:1000
OR AS NOTED

DWG. NO.
H333000-WP403-10-042-0001

REV.
01

P:\NUCLEAR\333000\CAD\C\H333000-WP403-10-042-0001.dwg
4/26/2010 12:26:08 PM
SHIES478



NOTES:

- BUILDING - PRESENT DURING SHAFT SINKING AND/OR LATERAL DEVELOPMENT *
 - BUILDING - PRESENT DURING OPERATIONS ONLY
- * FOR ALL BUILDINGS PRESENT DURING OPERATIONS REFER TO DRAWING H/333000-WP403-10-042-0001
- CONSTRUCTION FENCING:
 - SSFA TO BE ENCLOSED BY CHAIN LINK FENCE;
 - WRMA AND CONSTRUCTION AREA TO BE ENCLOSED BY SNOW FENCE
 FENCE LINE OMITTED FROM DRAWING FOR CLARITY



DRAWING NO.	H333000-WP403-10-042-0002
DRAWING TITLE	SHAFT SERVICE FACILITY AREA (SSFA) CONSTRUCTION LAYOUT GENERAL ARRANGEMENT
REFERENCE DRAWINGS	

NO.	DESCRIPTION	CHK'D	APP'D	DATE
01	FACILITY NAME CHANGES	G.K.	S.A.	10-04-25

NOT FOR CONSTRUCTION
 This drawing has been reviewed for the purposes of DGR Preliminary Engineering only and must not be used for other purposes.
 Work Package Owner: Shawn Avrons 2010/04/27 17:02:42 -0400

Area Lead: Shawn Avrons 2010/04/27 17:02:42 -0400

Engineering Manager: Shawn Avrons 2010/04/27 17:02:42 -0400

Project Manager: R.J. Haynes 2010/04/28 11:36:01 -0400

Accepted by Owner:

01	APPROVED FOR USE	G.K.	S.A.	10-04-25
00	APPROVED FOR USE	G.K.	S.A.	10-01-11

HATCH

DESIGNED BY M. FARRELL DATE 2009-11-16	DRAWN BY L. SHIELDS DATE 2009-11-16
CHECKED BY M. FARRELL DATE 2009-12-16	DISCIP. ENGR. G. KRAMER DATE 2009-12-16
PROJ. DES. COORD.	PROJ. ENGR.

PROJ. MGR.
M. DAWBORN
DATE 2009-11-25

NUCLEAR WASTE MANAGEMENT ORGANIZATION
 DEEP GEOLOGIC REPOSITORY PROJECT

SHAFT SERVICE FACILITY AREA (SSFA)


CONSTRUCTION LAYOUT
 GENERAL ARRANGEMENT

SCALE
 1:2000
 OR AS NOTED


DWG. NO.
 H333000-WP403-10-042-0002

REV.
 01


P:\Nuclear\333000\CAD\N\H333000-WP403-10-042-0002.dgn
 4/27/2010 4:15:20 PM
 SHIE478

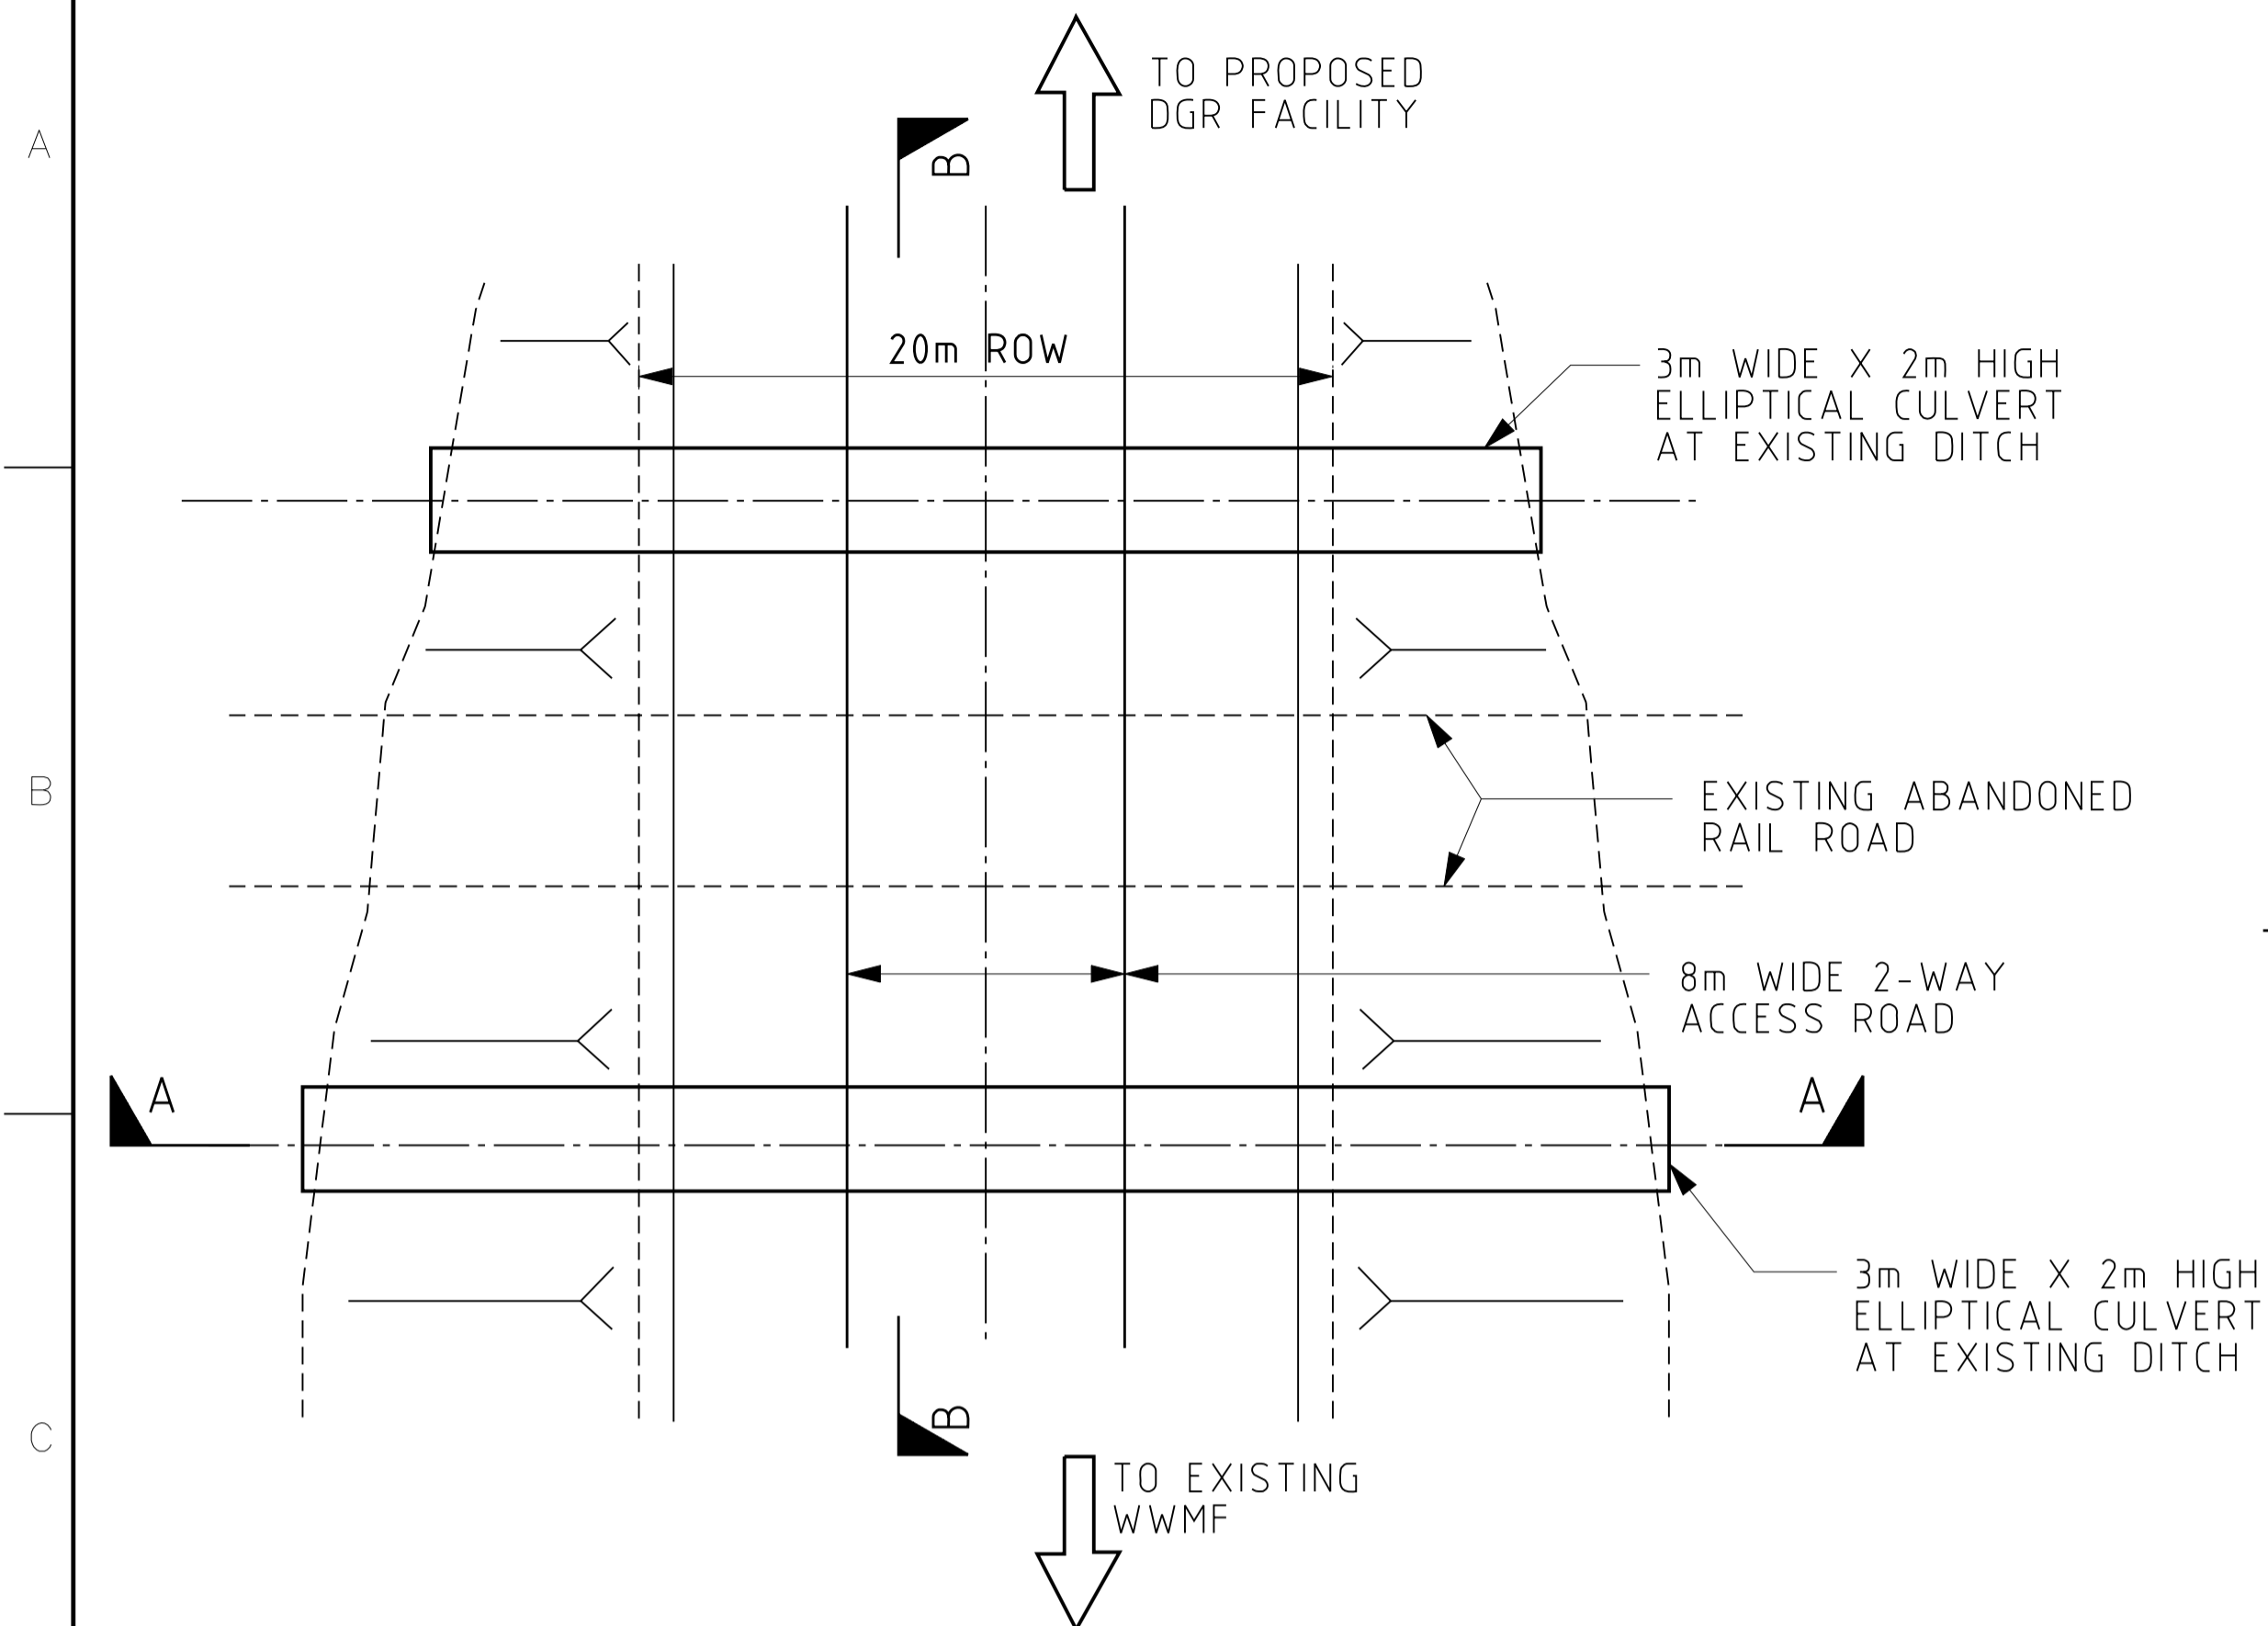

PLAN - ACCESS ROAD TO WWMF
NOT TO SCALE

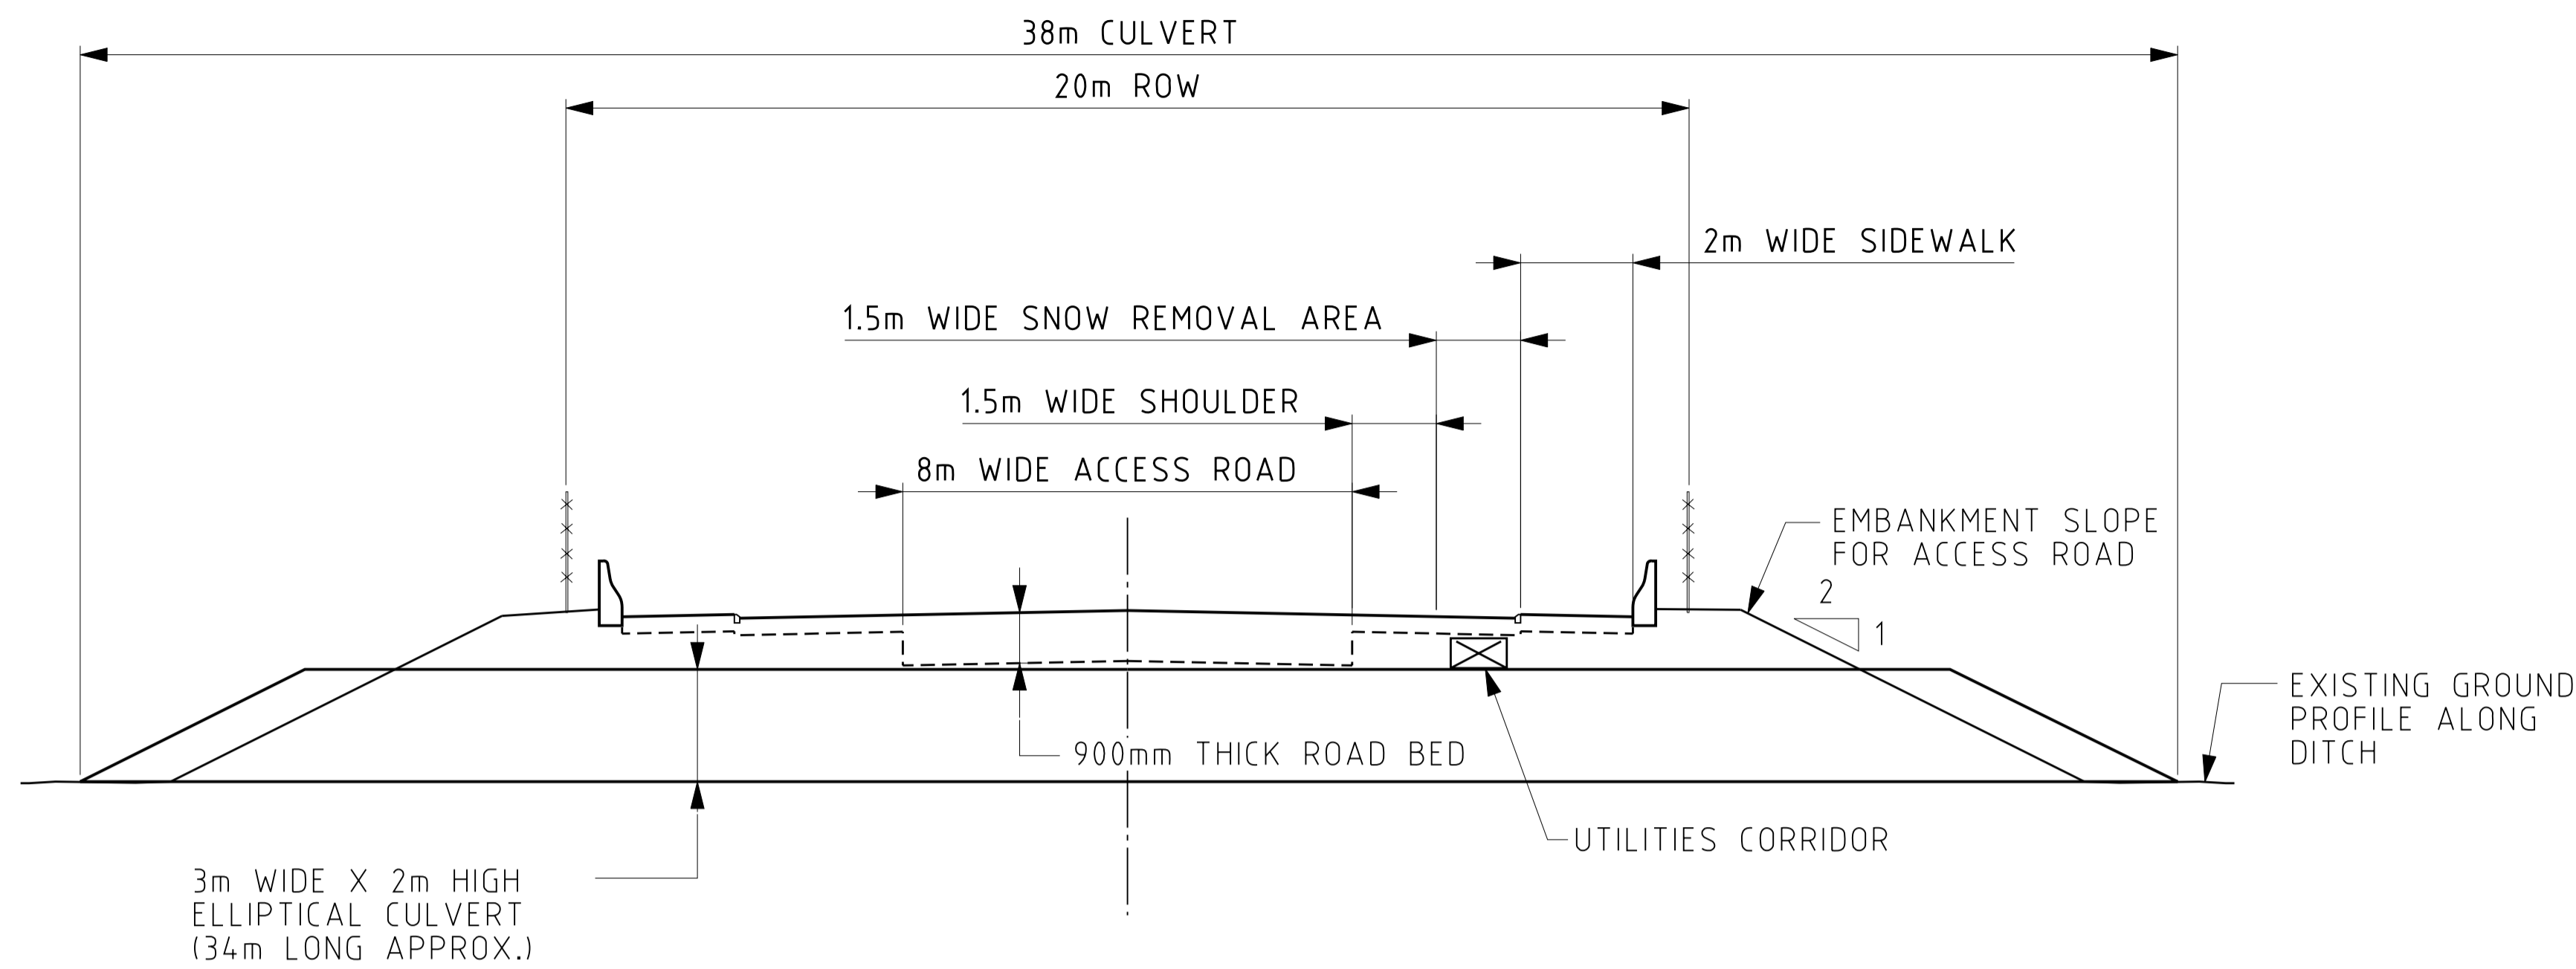


CROSS SECTION OF ACCESS ROAD TO FACILITY (SECTION A-A)
SCALE 1:100

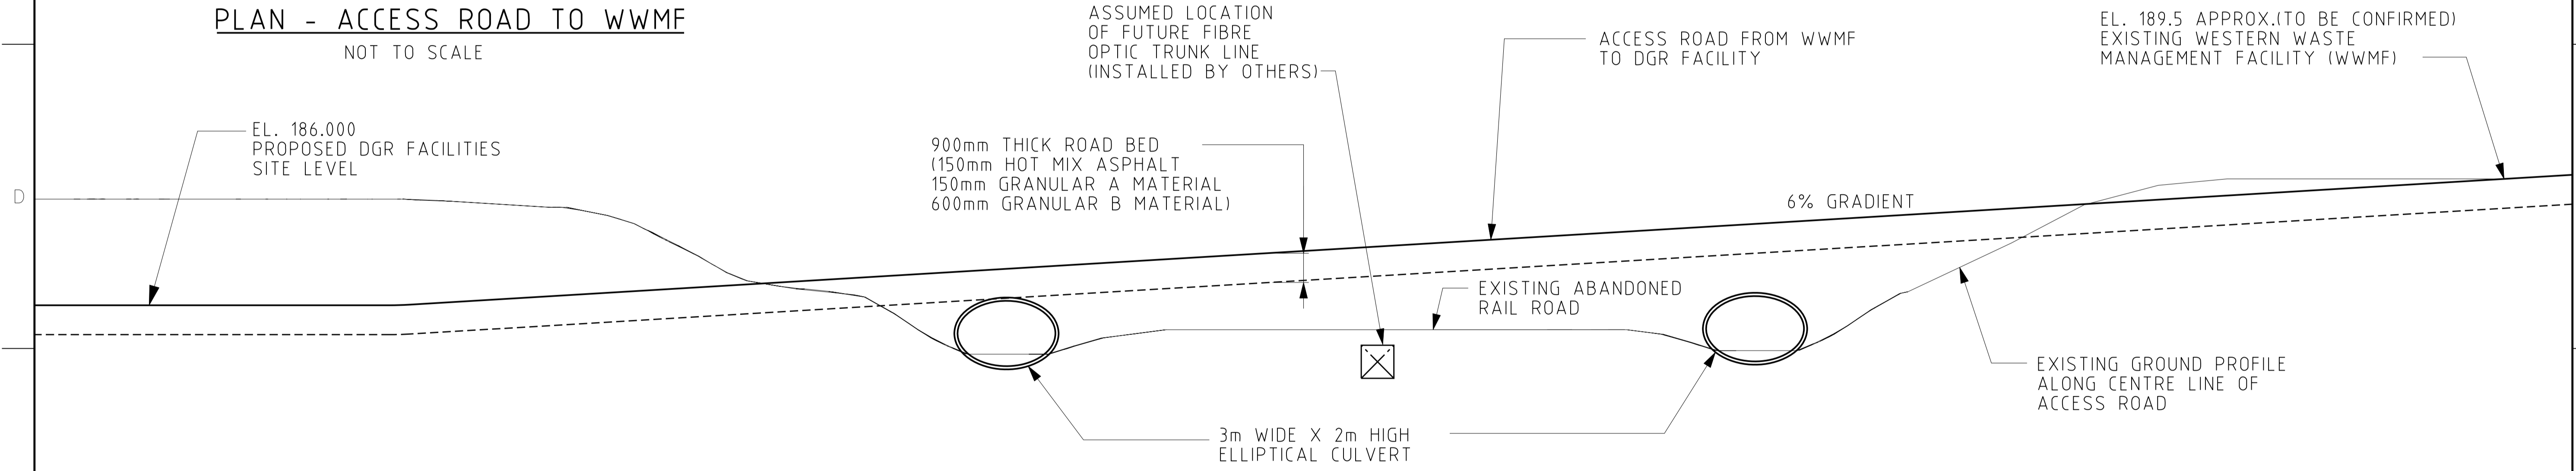

LONGITUDINAL SECTION ALONG CENTRE LINE OF ACCESS ROAD TO FACILITY (SECTION B-B)
SCALE 1:100




NOT FOR CONSTRUCTION This drawing has been reviewed for the purposes of DGR Preliminary Engineering only and must not be used for other purposes. Work Package Owner Area Lead Engineering Manager Project Manager Accepted by Owner		HATCH DESIGNED BY: C. CHAN DATE: 2009-11-27 CHECKED BY: M. FARRELL DATE: 2009-12-16 PROJ. DES. COORD.: G. KRAMER DATE: 2009-12-16 PROJ. ENGR.: G. KRAMER		NUCLEAR WASTE MANAGEMENT ORGANIZATION DEEP GEOLOGIC REPOSITORY PROJECT SHAFT SERVICE FACILITY AREA (SSFA) SURFACE FACILITIES - CROSSING OF RAILWAY & DITCHES TO WWMF	
REFERENCE DRAWINGS 1 2		REVISIONS NO. DESCRIPTION CHK'D APP'D DATE		ISSUE AUTHORIZATION 00 APPROVED FOR USE G.K. S.A. 10-01-11 REV. ISSUE FOR AUTH. BY DATE PROJ. MGR. M. DAWBORN DATE: 2009-11-27	
DRAWING NO.		DRAWING TITLE		SCALE	DWG. NO.
1		2		AS NOTED	H333000-WP403-10-042-0003
				OR AS NOTED	00

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 SHE9478

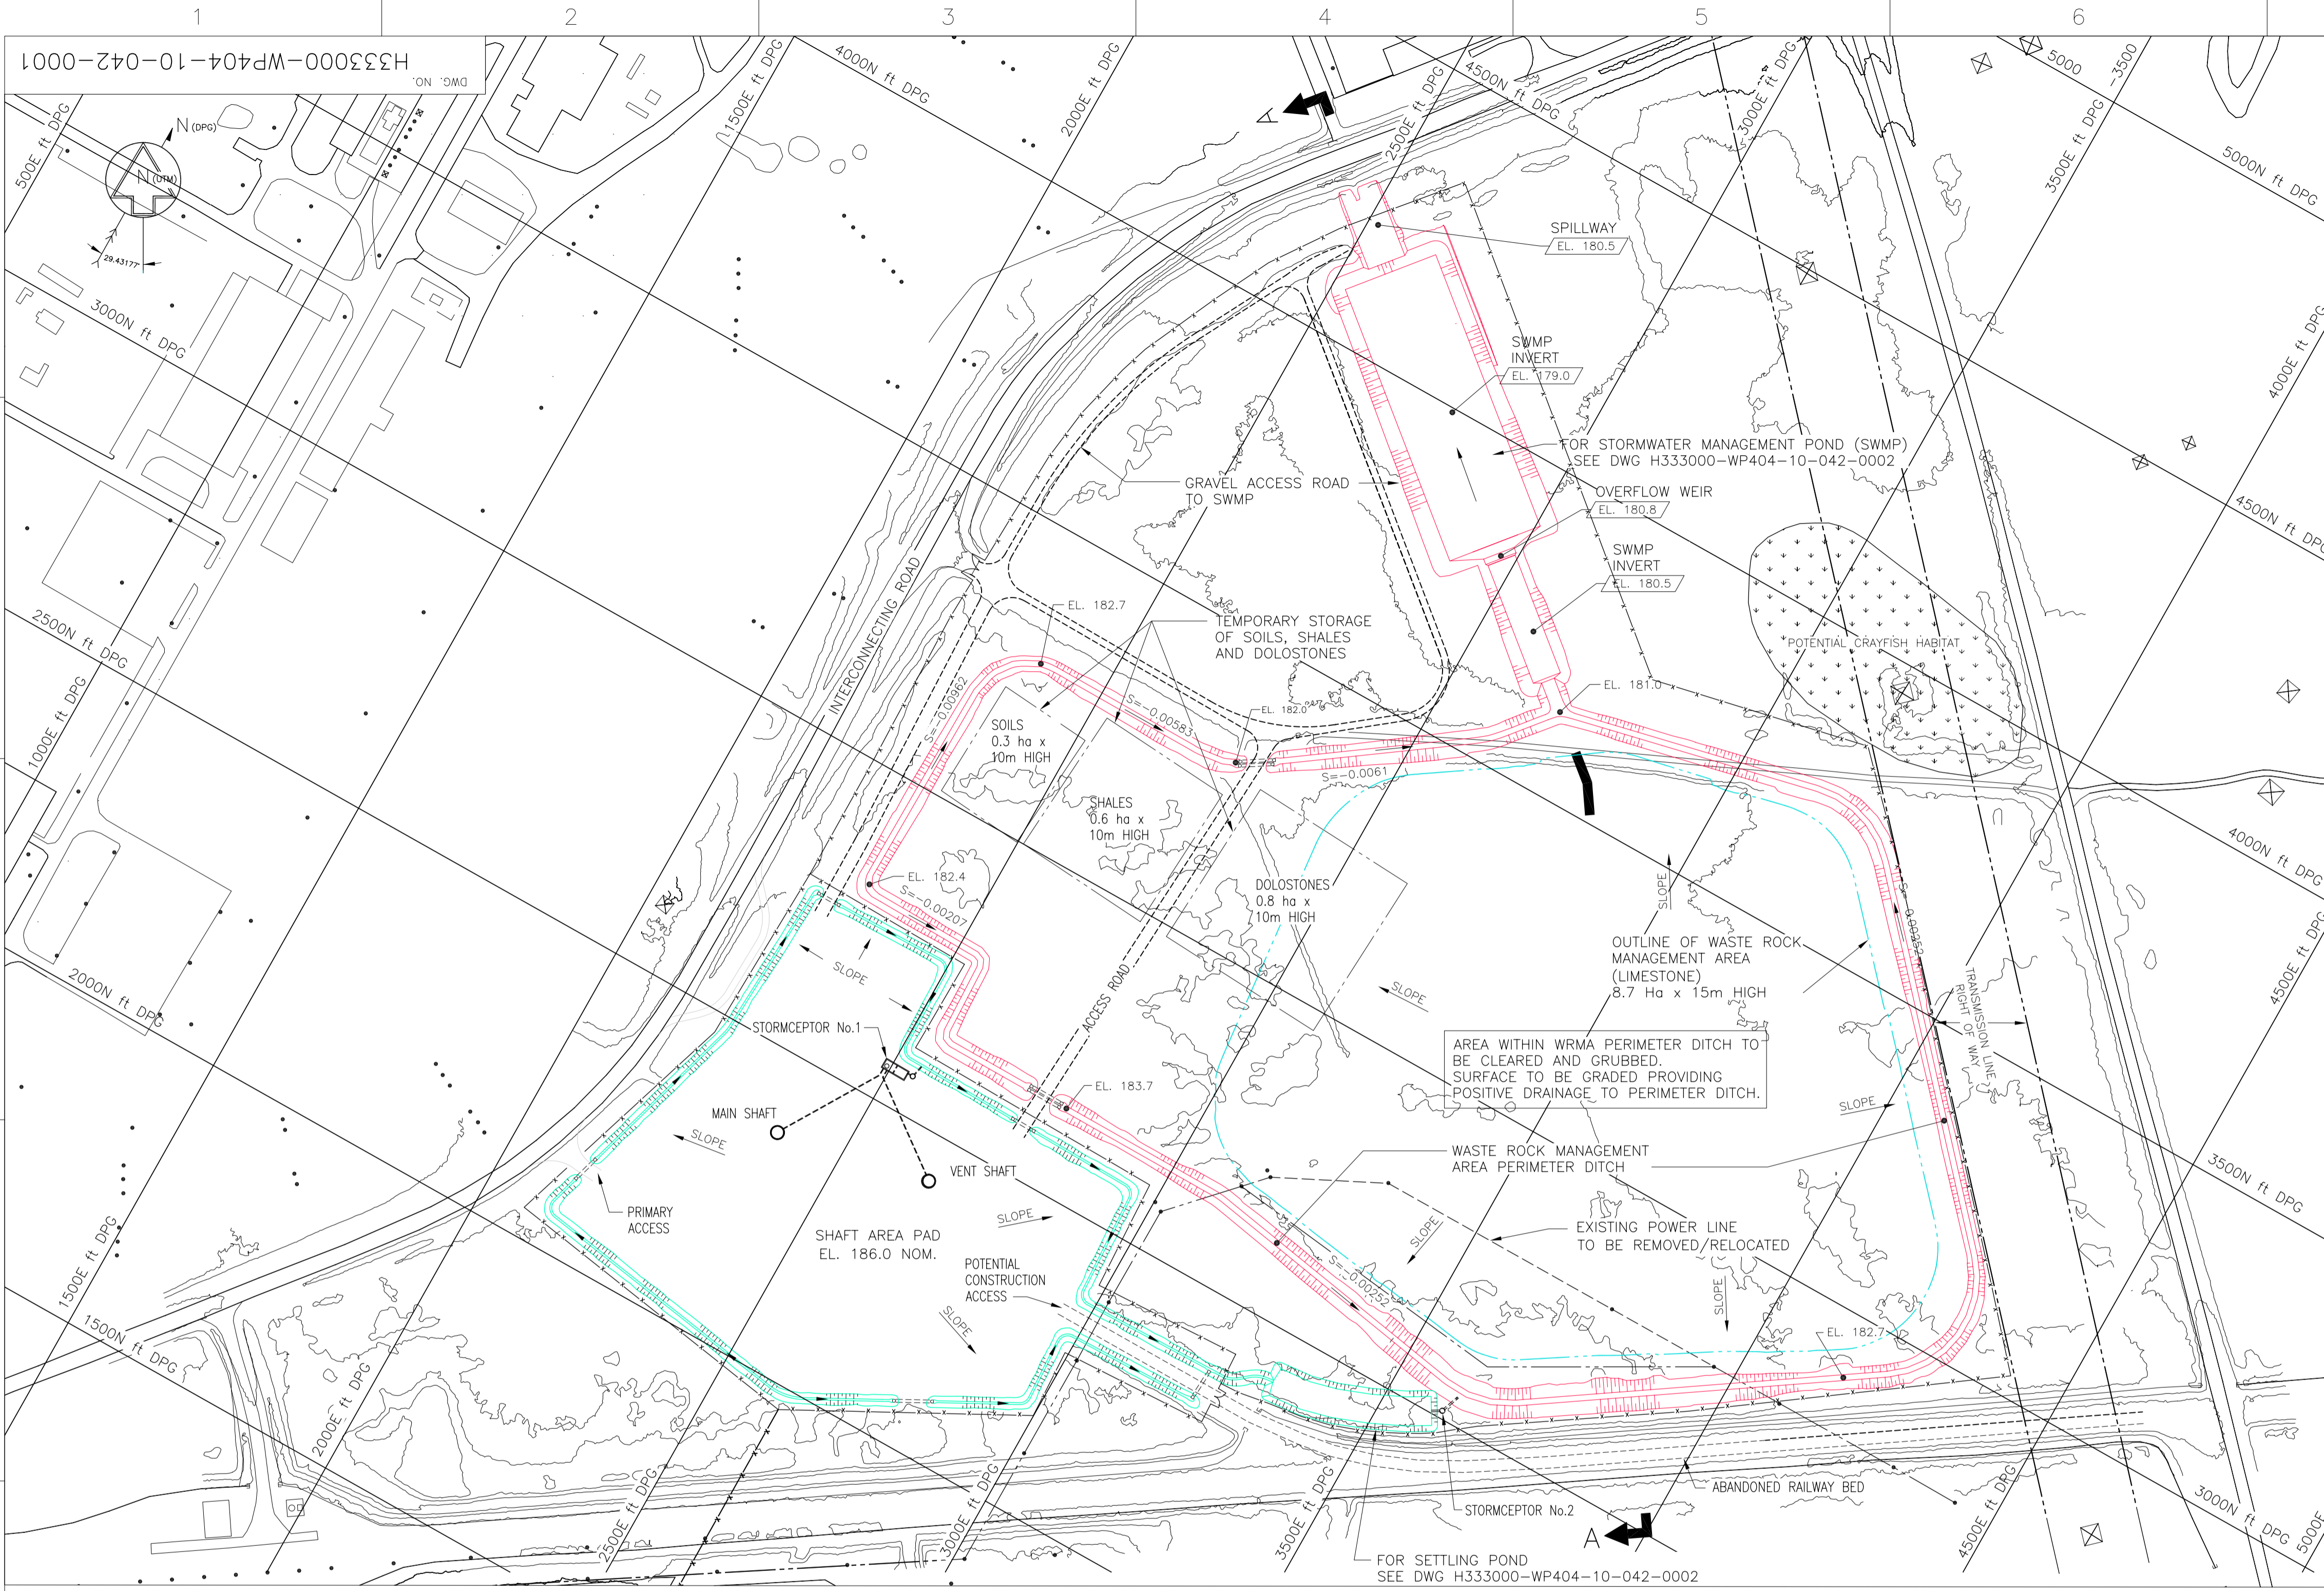


NOTES:

- HORIZONTAL DATUM:** COORDINATE SYSTEM SHOWN IS BASED ON 1959 DOUGLAS POINT GRID (DPG). GRID SHOWN IN FEET AND CAN BE CONVERTED TO METRES BY MULTIPLYING BY 0.3048. COORDINATES CAN BE TRANSFORMED FROM DPG TO UTM NAD83 ZONE 17 (OR REVERSE) USING THE FOLLOWING EQUATIONS:
 $EASTING_{UTM} = 452408.341 + (0.8705935 \times EASTING_{DPG}) + (0.4911905 \times NORTHING_{DPG})$
 $NORTHING_{UTM} = 4907963.328 + (0.8705935 \times NORTHING_{DPG}) - (0.4911905 \times EASTING_{DPG})$
 DPG COORDINATES MUST BE CONVERTED TO METRES BEFORE USING THIS TRANSFORMATION.
 EQUATIONS PROVIDED BY 4DM INC. IN "DGR PROJECT COORDINATE TRANSFORMATION FROM DPG TO UTM WPD-SC34 WORK REQUEST 3", FEBRUARY 5, 2008.
- VERTICAL DATUM:** STATION 0011972U188
 ELEVATION 183.330 (CGVD28).
 LOCATION: BRUCE NUCLEAR POWER DEVELOPMENT (AUXILIARY STEAM PLANT) CONCRETE CHIMNEY, TABLET IN EAST FACE OF CHIMNEY, 6.7m CLOCKWISE OF A STEEL DOOR, 4.5m COUNTER-CLOCKWISE OF A STEEL LADDER AND 30cm ABOVE CONCRETE BASE.
- CONTOURS** PRODUCED BY HATCH LTD. FROM A DIGITAL ELEVATION MODEL (DEM). THE DEM WAS PROVIDED AND PREPARED BY 4DM INC. BASED ON A LIDAR SURVEY FLOWN BY TERRAPOINT CANADA, JULY 19, 2007.

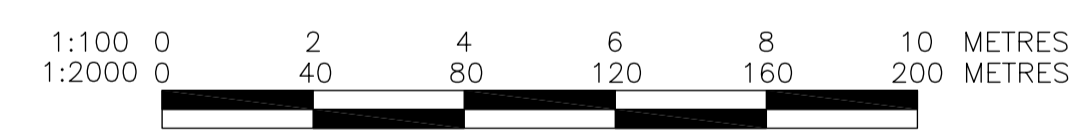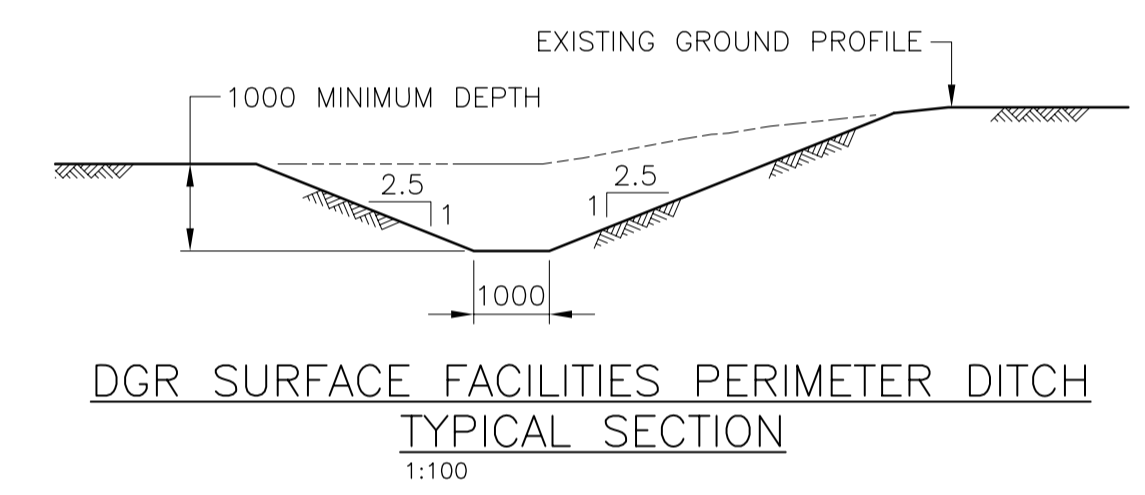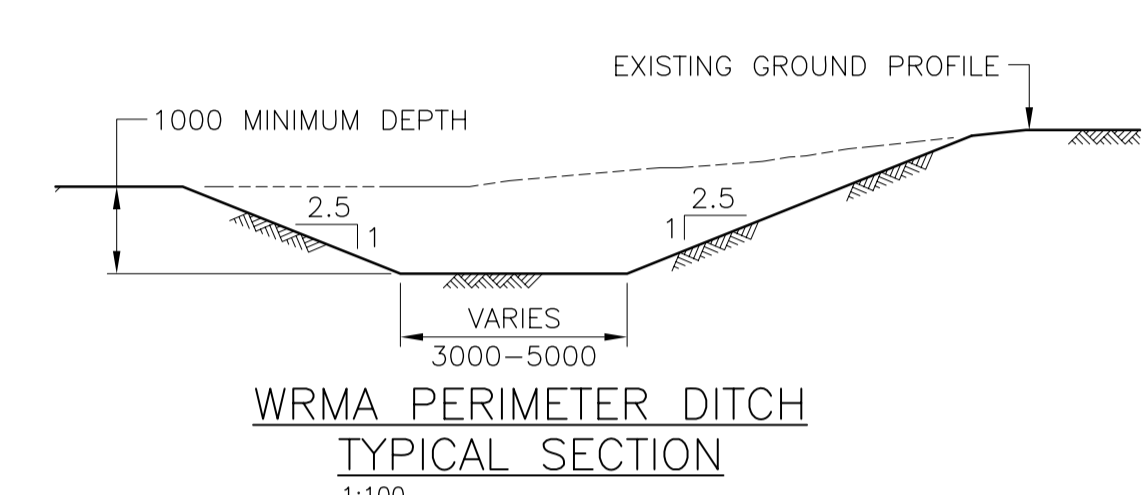

GENERAL ARRANGEMENT
1:2000

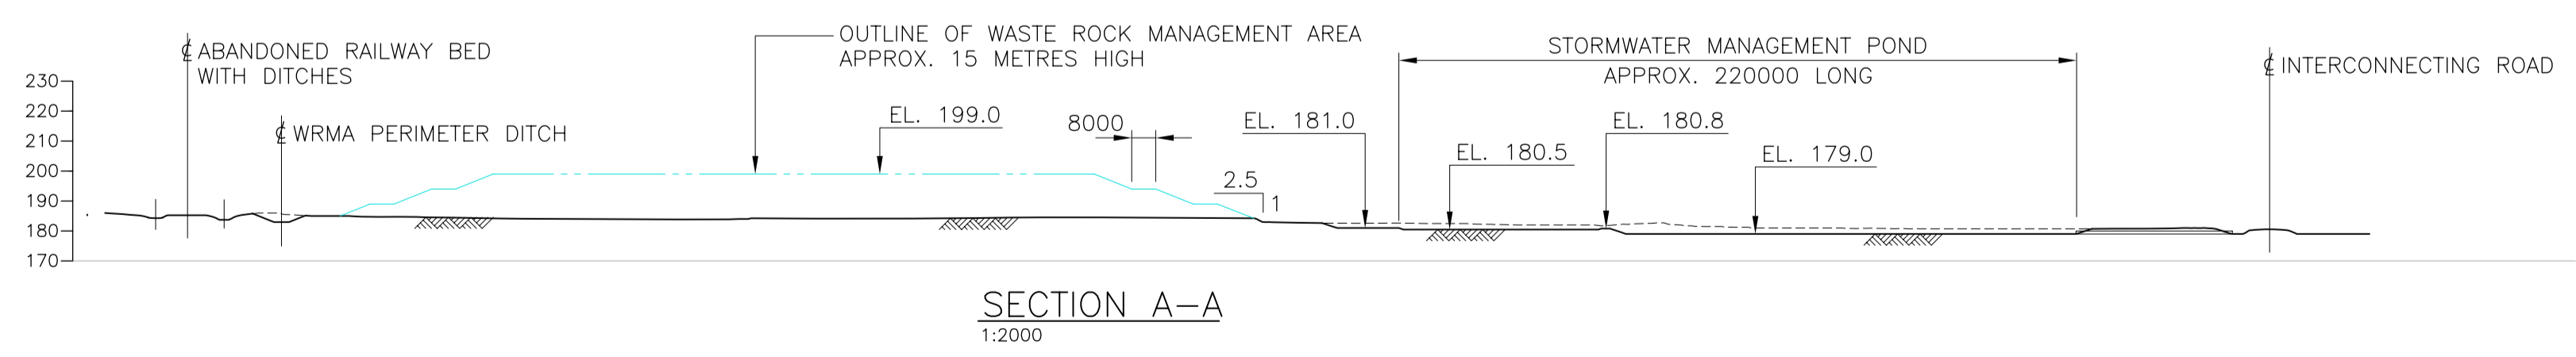

SECTION A-A
1:2000

DRAWING NO.	DRAWING TITLE
1	REFERENCE DRAWINGS
2	
3	
4	
5	
6	
7	
8	








NO.	DESCRIPTION	CHK'D	APP'D	DATE
REVISIONS				

NOT FOR CONSTRUCTION This drawing has been reviewed for the purpose of DGR Preliminary Engineering only and must not be used for other purposes. Work Package Owner: [Signature]			
Area Lead [Signature]			
Engineering Manager Sherwin Aarons 2010.01.12 10:26:47 - 0200			
Project Manager Sherwin Aarons 2010.01.12 10:26:54 - 0200			
Accepted by Owner R.J. Heysse 2010.01.18 10:36:32 - 0500			
APPROVED FOR USE REV. ISSUE FOR		GJEK SAA AUTH. BY DATE	
00		2010-01-05	
ISSUE AUTHORIZATION			

HATCH	
DESIGNED BY R. ZHOU	DRAWN BY D. PARKES
CHECKED BY	DATE
DATE	DATE
PROJ. DES. COORD.	PROJ. ENGR.
DATE	DATE
M.R. DAWBORN DATE 2010-01-05	

NUCLEAR WASTE MANAGEMENT ORGANIZATION DEEP GEOLOGIC REPOSITORY PROJECT		
WASTE ROCK MANAGEMENT AREA		
SITE GRADING AND DRAINAGE		
SCALE OR AS NOTED	DWG. NO. H333000-WP404-10-042-0001	REV. 00

Jan 08 2010 11:25am Login Name: larc508001
 Drawing Name: P:\NUCLEAR\333000(CAD)\WF\H333000-WP404-10-042-0001.dwg

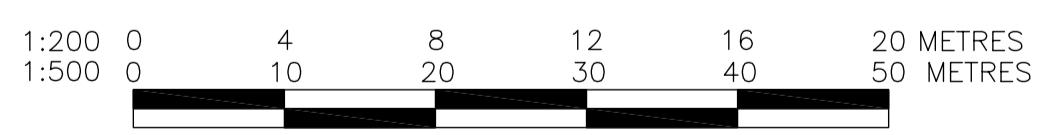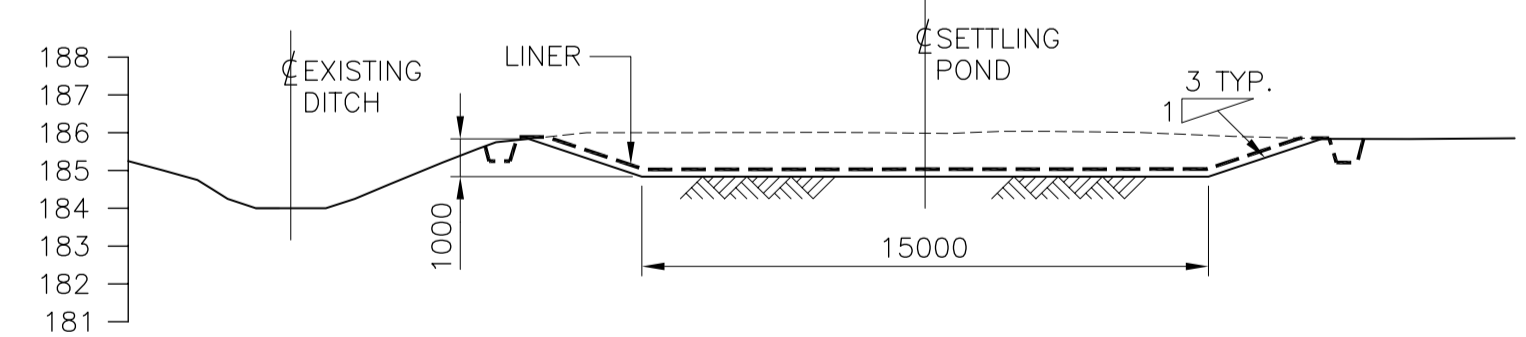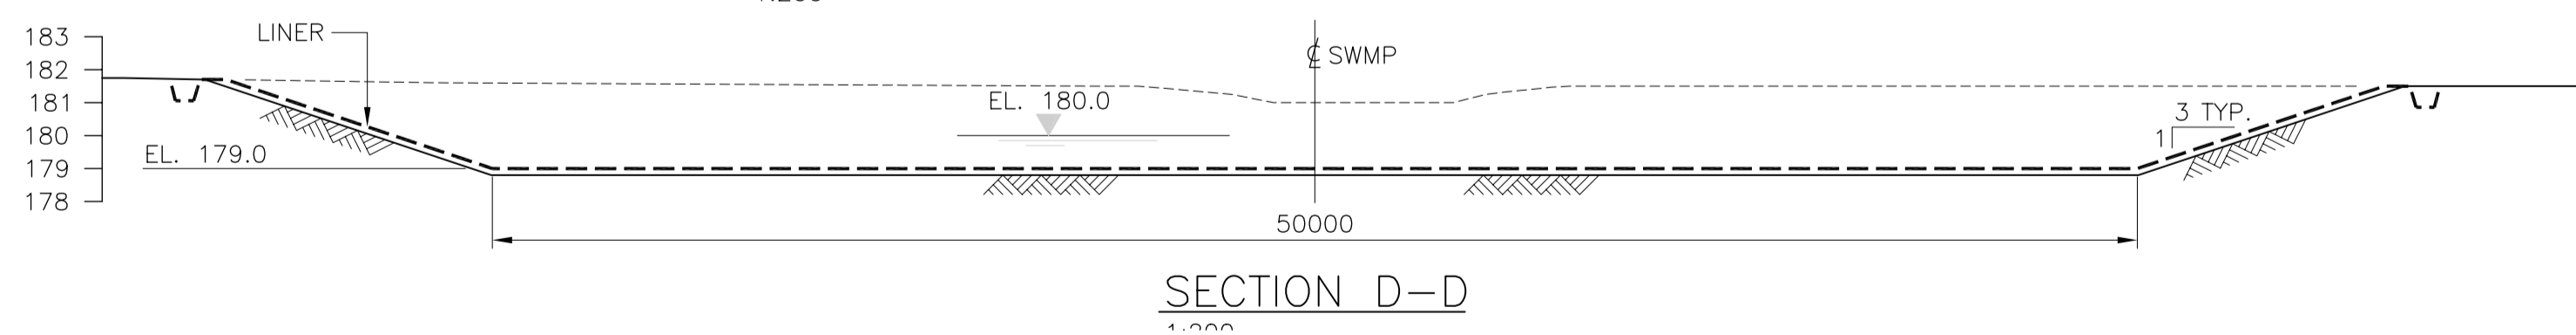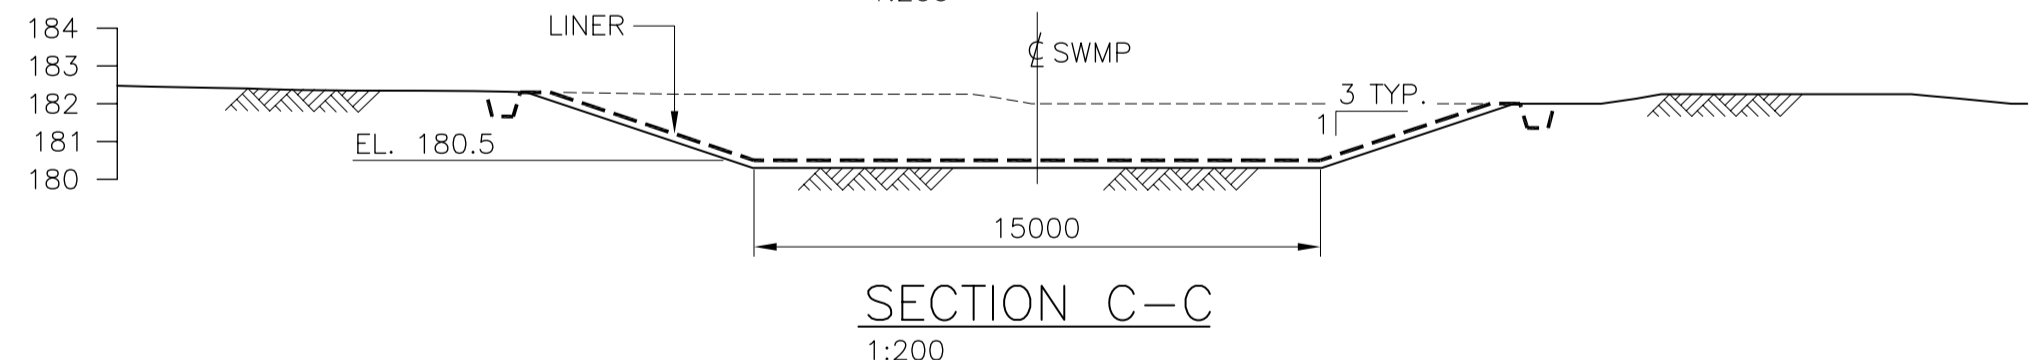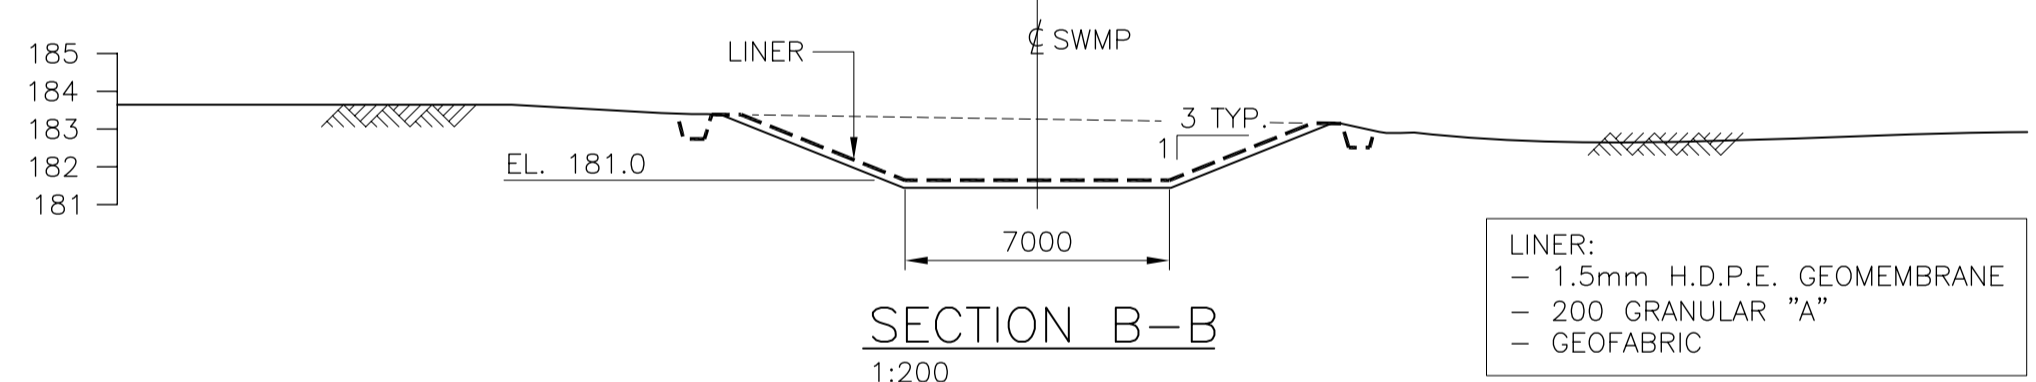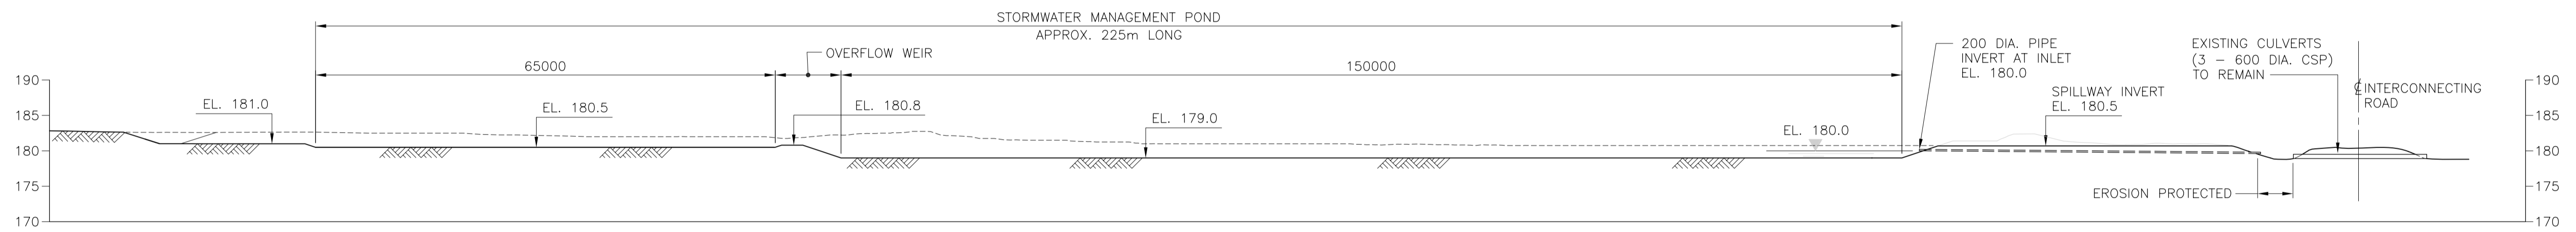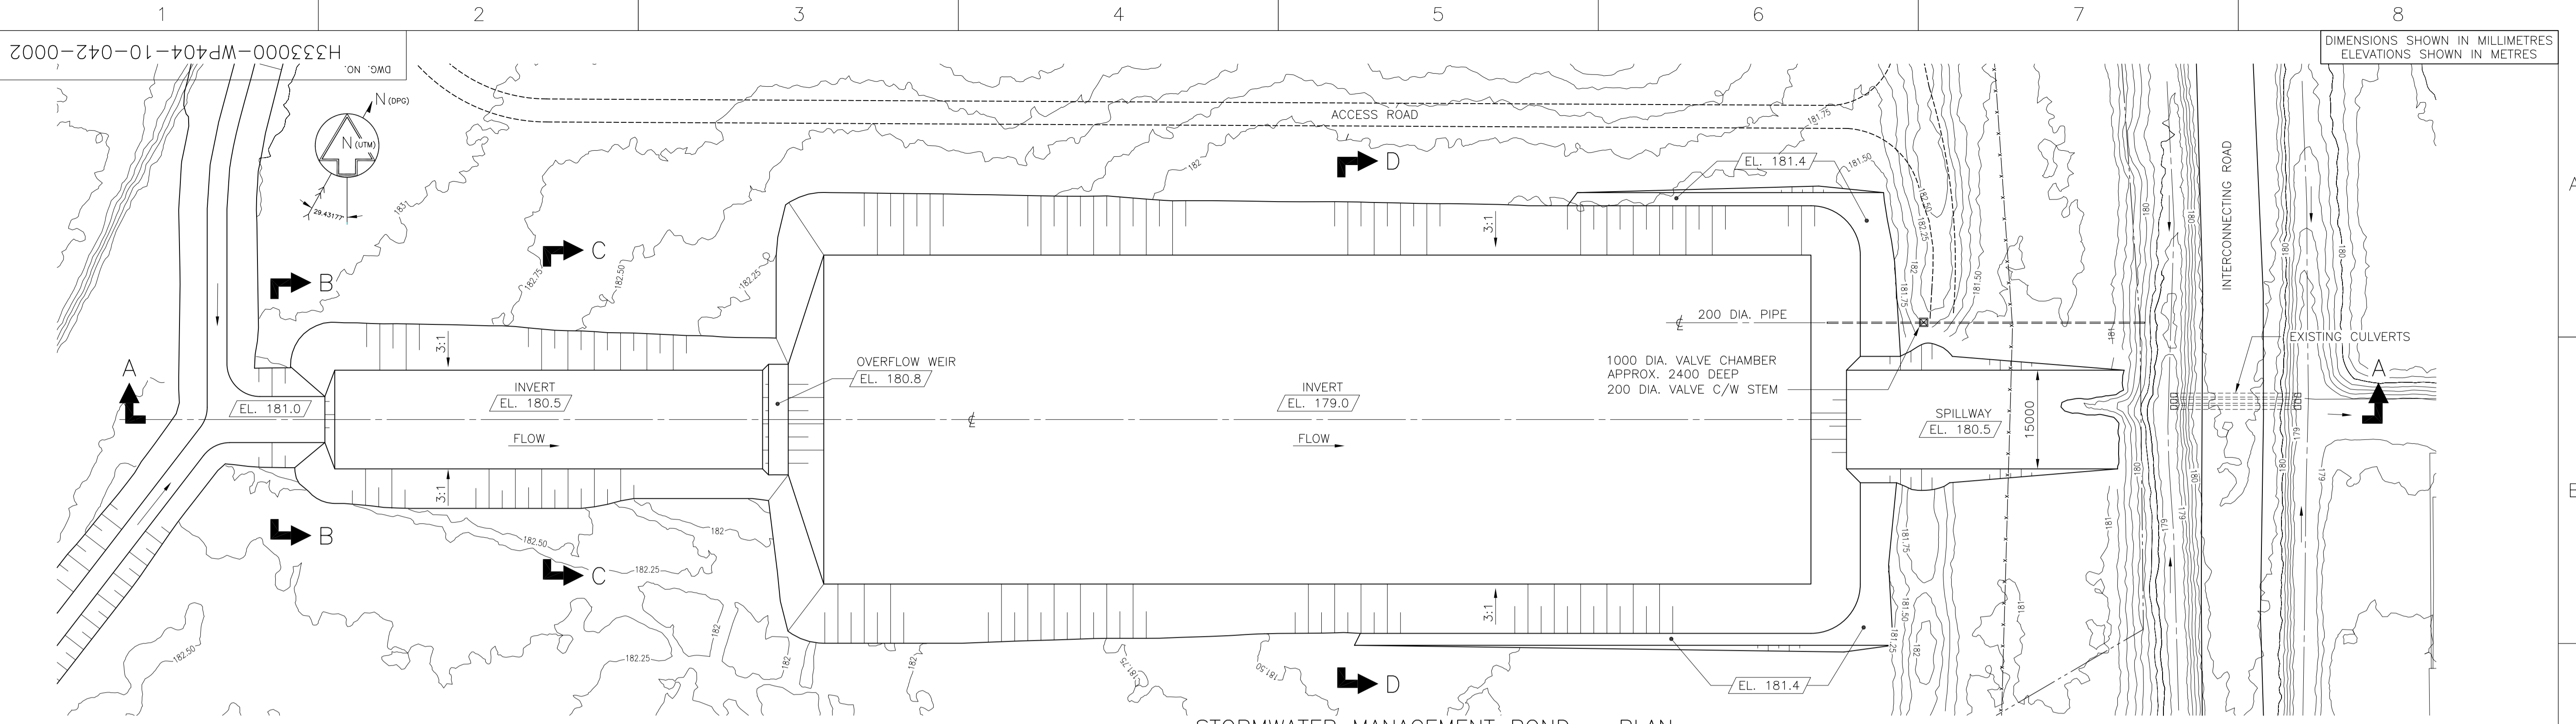

DRAWING NO.	DRAWING TITLE
1	REFERENCE DRAWINGS
2	

NO.	DESCRIPTION	CHK'D	APP'D	DATE
REVISIONS				


NOT FOR CONSTRUCTION
 This drawing has been reviewed for the purposes of DGR Preliminary Engineering only and must not be used for other purposes.
 Work Package Owner
 Area Lead
 Engineering Manager
 Project Manager
 Accepted by Owner

REV.	ISSUE FOR	GJEK	SAA	2010-01-05	DATE
00	APPROVED FOR USE				


HATCH
 DESIGNED BY R. ZHOU
 DRAWN BY D. PARKES
 CHECKED BY
 DATE
 PROJ. DES. COORD.
 DATE
 PROJ. ENGR.
 DATE

**NUCLEAR WASTE MANAGEMENT ORGANIZATION
 DEEP GEOLOGIC REPOSITORY PROJECT**
WASTE ROCK MANAGEMENT AREA
**STORMWATER MANAGEMENT POND
 AND SETTLING POND**
 SCALE OR AS NOTED
 DWG. NO. H333000-WP404-10-042-0002
 REV. 00


Jan 08 2010 11:25am Login name: larc50801
 Drawing Name: P:\NUCLEAR\333000(CAD)\WP404-10-042-0002.dwg

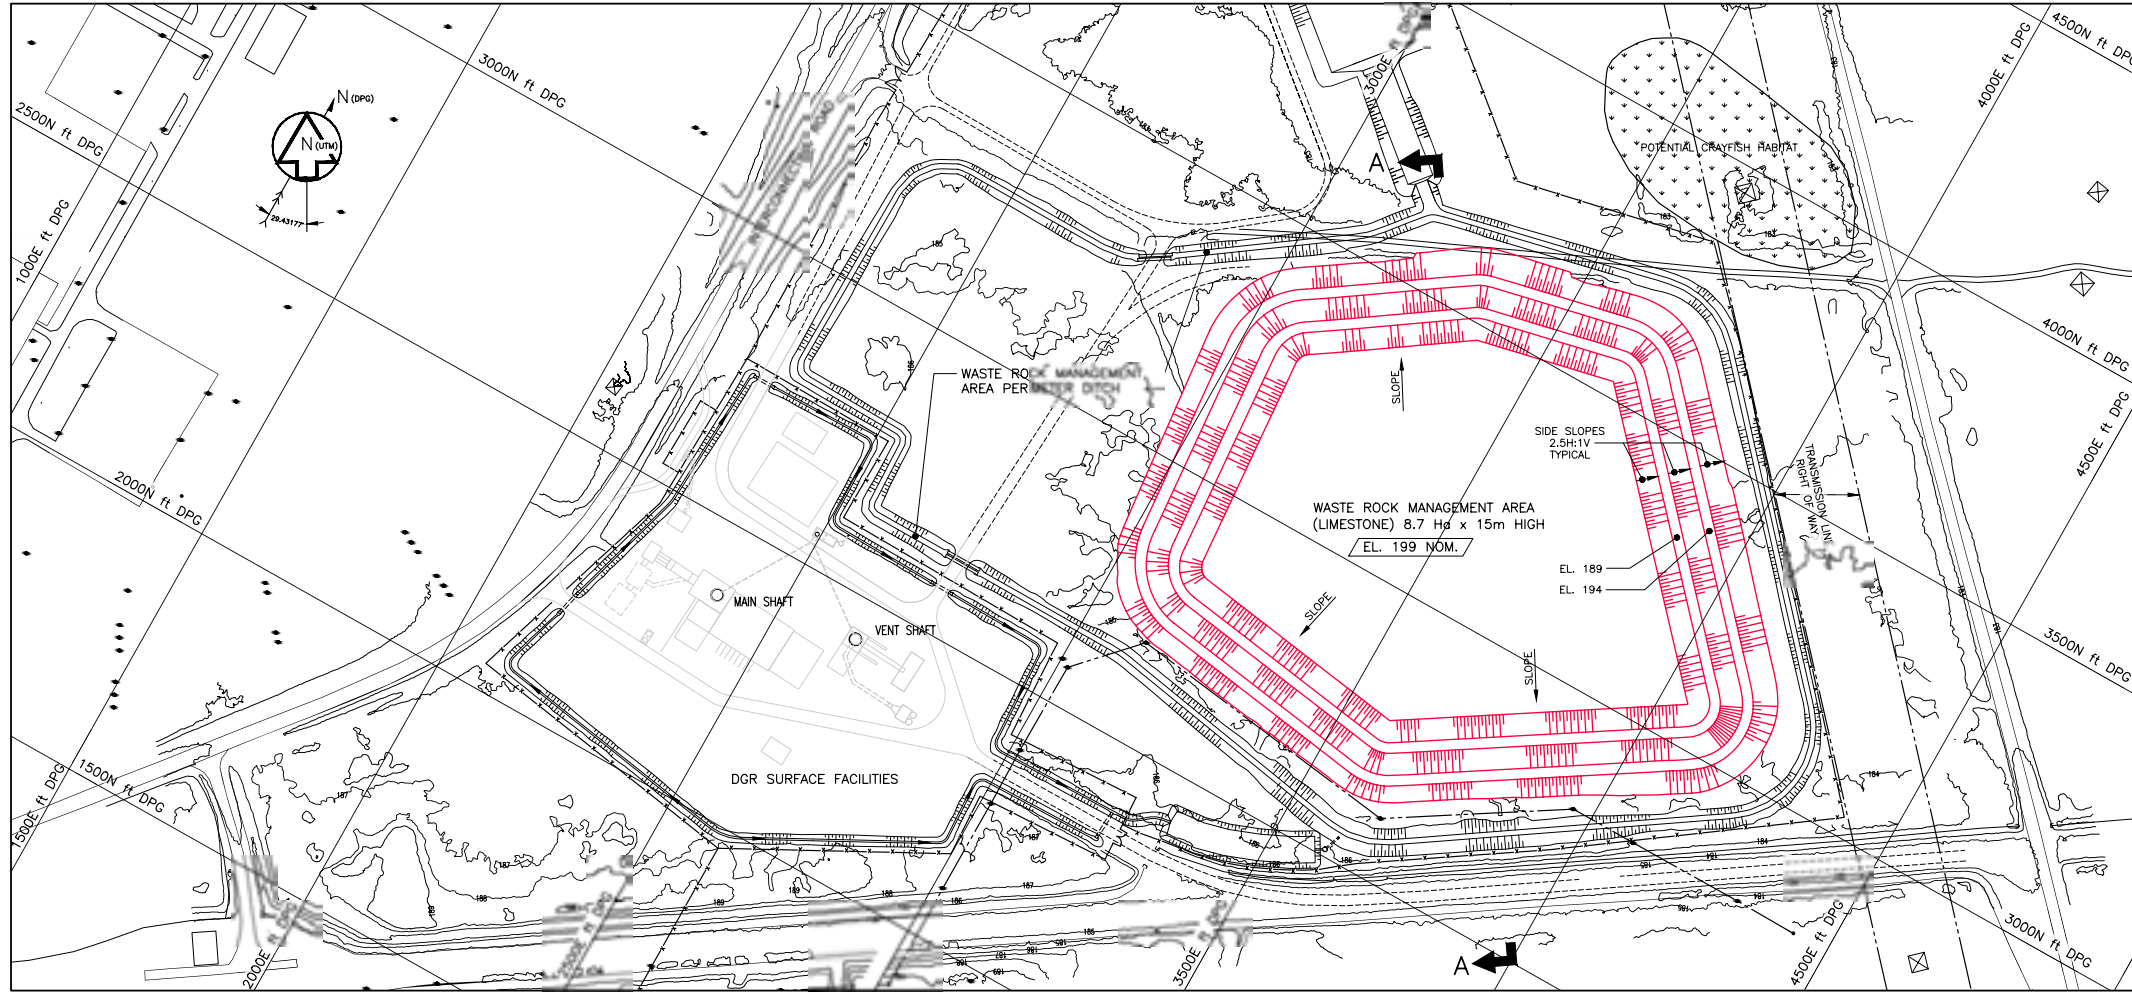

GENERAL ARRANGEMENT
1:2000

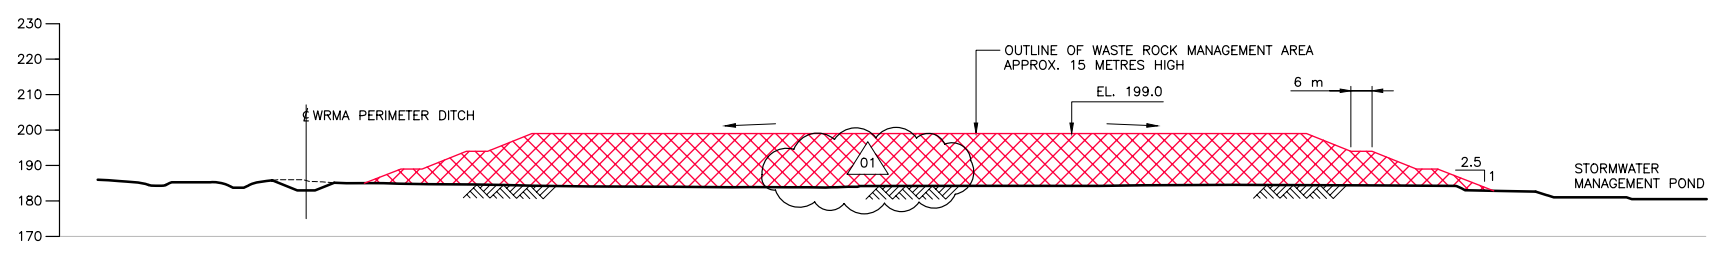


SECTION A-A
1:2000

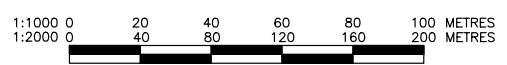


- NOTE:**
- HORIZONTAL DATUM: COORDINATE SYSTEM SHOWN IS BASED ON 1959 DOUGLAS POINT GRID (DPG). GRID SHOWN IN FEET AND CAN BE CONVERTED TO METRES BY MULTIPLYING BY 0.3048.
 - VERTICAL DATUM: STATION 0011972U188 ELEVATION 183.330 (CGVD28). LOCATION: BRUCE NUCLEAR POWER DEVELOPMENT (AUXILIARY STEAM PLANT) CONCRETE CHIMNEY, TABLET IN EAST FACE OF CHIMNEY, 6.7m CLOCKWISE OF A STEEL DOOR, 4.5m COUNTER-CLOCKWISE OF A STEEL LADDER AND 30cm ABOVE CONCRETE BASE.
 - CONTOURS PRODUCED BY HATCH LTD. FROM A DIGITAL ELEVATION MODEL (DEM). THE DEM WAS PROVIDED AND PREPARED BY 4DM INC. BASED ON A LIDAR SURVEY FLOWN BY TERRAPOINT CANADA, JULY 19, 2007.
 - FOR WASTE ROCK VOLUMES AND BULKING FACTOR SEE WP4-4 FUNCTIONAL DESCRIPTION (REFERENCE NUMBER H333000-WP404-10-109-0001).

May 10, 2010 3:45pm Login name: Park110733 Layout: Layout1
 Drawing Name: P:\NUCLEAR\333000\CAD\WP404-10-042-0003.dwg


DRAWING NO.		DRAWING TITLE		NOT FOR CONSTRUCTION This drawing has been reviewed for the purposes of DGR Preliminary Engineering only and must not be used for other purposes. Work Package Owner: [Signature] Design Manager: [Signature] Project Manager: [Signature] Accepted by Owner: [Signature]		HATCH DESIGNED BY R. ZHOU DRAWN BY D. PARKES CHECKED BY [Signature] DATE 2010-01-05 DATE 2010-01-05 DATE 2010-01-05 DATE 2010-01-05		NUCLEAR WASTE MANAGEMENT ORGANIZATION DEEP GEOLOGIC REPOSITORY PROJECT WASTE ROCK MANAGEMENT AREA BASE CASE	
REFERENCE DRAWINGS 1 2		REVISIONS 01 VOLUME LABEL REMOVED, NOTE 4 ADDED GJEK SAA 2010-05-10 NO. DESCRIPTION CHK'D APP'D DATE		ISSUE AUTHORIZATION 00 APPROVED FOR USE GJEK SAA 2010-05-10 REV. ISSUE FOR AUTH. BY DATE M.R. DAWBORN DATE 2010-01-05		SCALE OR AS NOTED DWG. NO. H333000-WP404-10-042-0003 REV. 01			

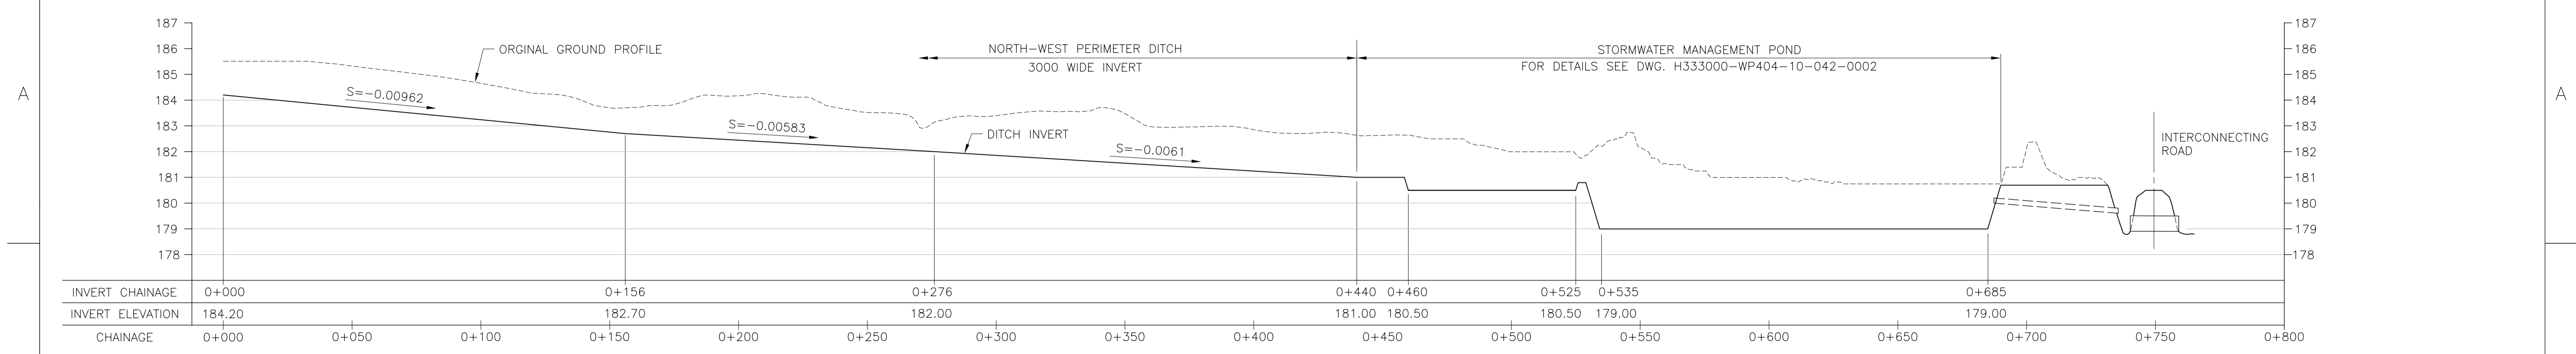


PROFILE ALONG NORTH-WEST PERIMETER DITCH AND STORMWATER MANAGEMENT POND
 1:1250

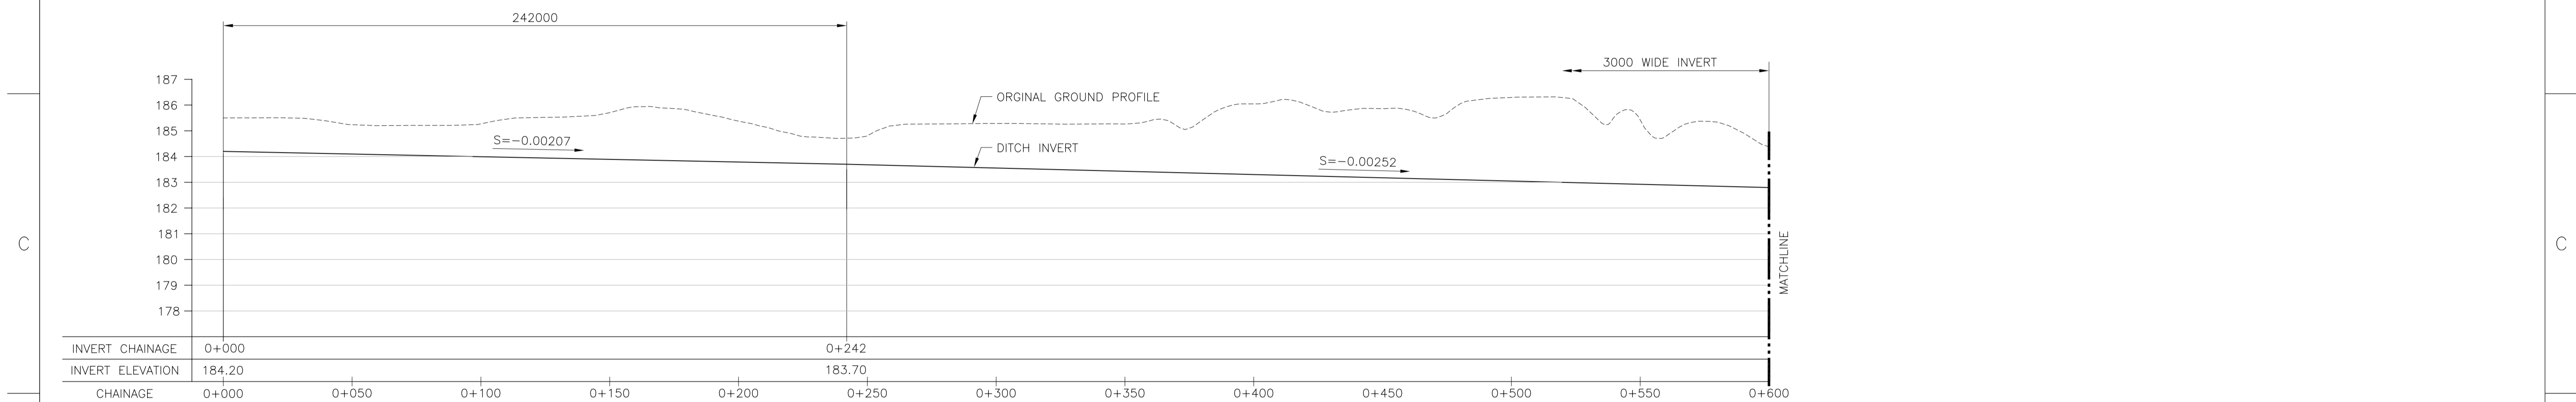

PROFILE ALONG SOUTH-EAST PERIMETER DITCH
 1:1250


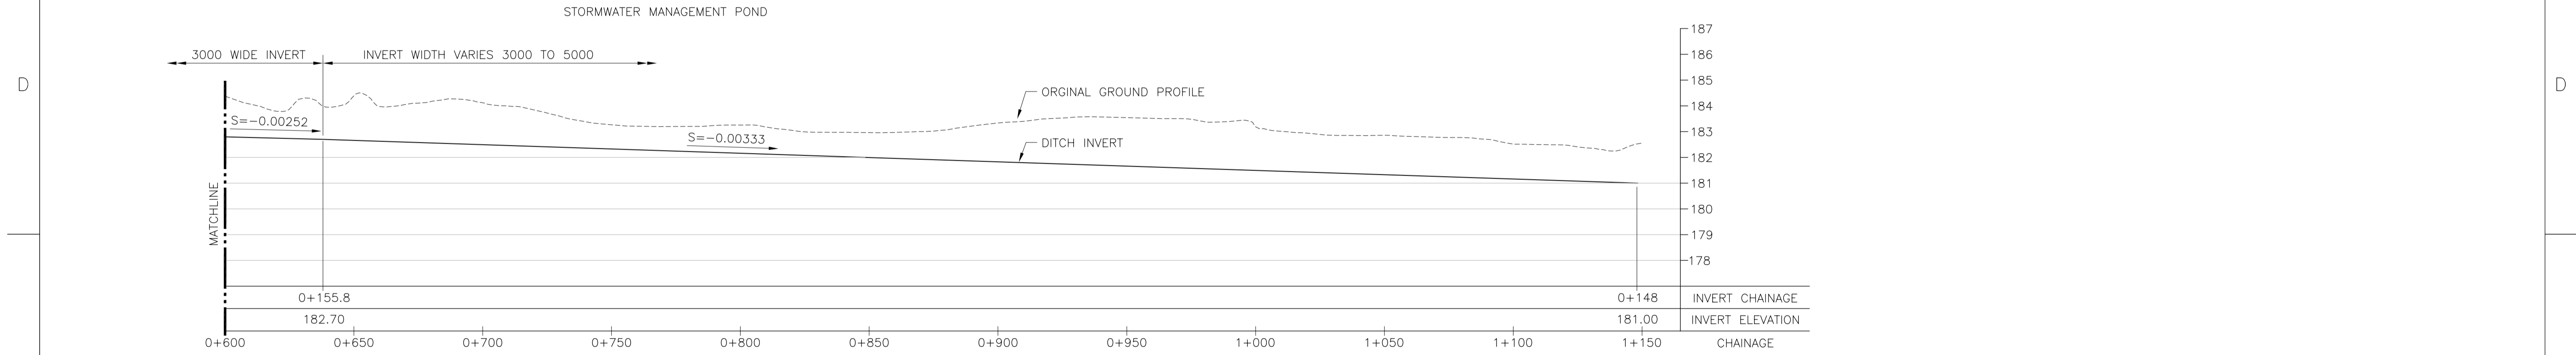


PROFILE ALONG SOUTH-EAST PERIMETER DITCH (CONT.)
 1:1250

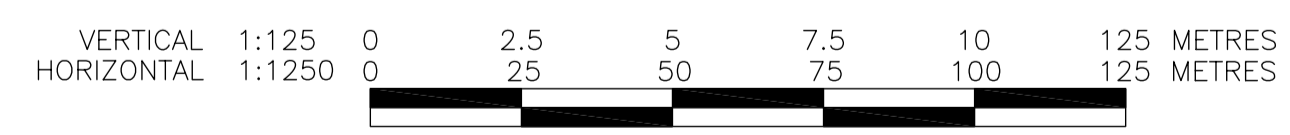


Jan 08 2010 11:26am Login name: larc50801 Layout: Layout1
 Drawing Name: P:\NUCLEAR\333000\CA0\WP404-10-042-0005.dwg


DRAWING NO.		DRAWING TITLE		NO.		DESCRIPTION		CHK'D	APP'D	DATE	NOT FOR CONSTRUCTION This drawing has been reviewed for the purposes of DGR Preliminary Engineering only and must not be used for other purposes. Work Package Owner Area Lead Engineering Manager Project Manager Accepted by Owner		HATCH DESIGNED BY R. ZHOU DRAWN BY D. PARKES CHECKED BY DATE PROJECT MGR. M.R. DAWBORN DATE 2010-01-05		NUCLEAR WASTE MANAGEMENT ORGANIZATION DEEP GEOLOGIC REPOSITORY PROJECT WASTE ROCK MANAGEMENT AREA NORTH-WEST AND SOUTH EAST PERIMETER DITCH - PROFILES		SCALE OR AS NOTED	DWG. NO. H333000-WP404-10-042-0005	REV. 00
REFERENCE DRAWINGS				REVISIONS								ISSUE AUTHORIZATION							

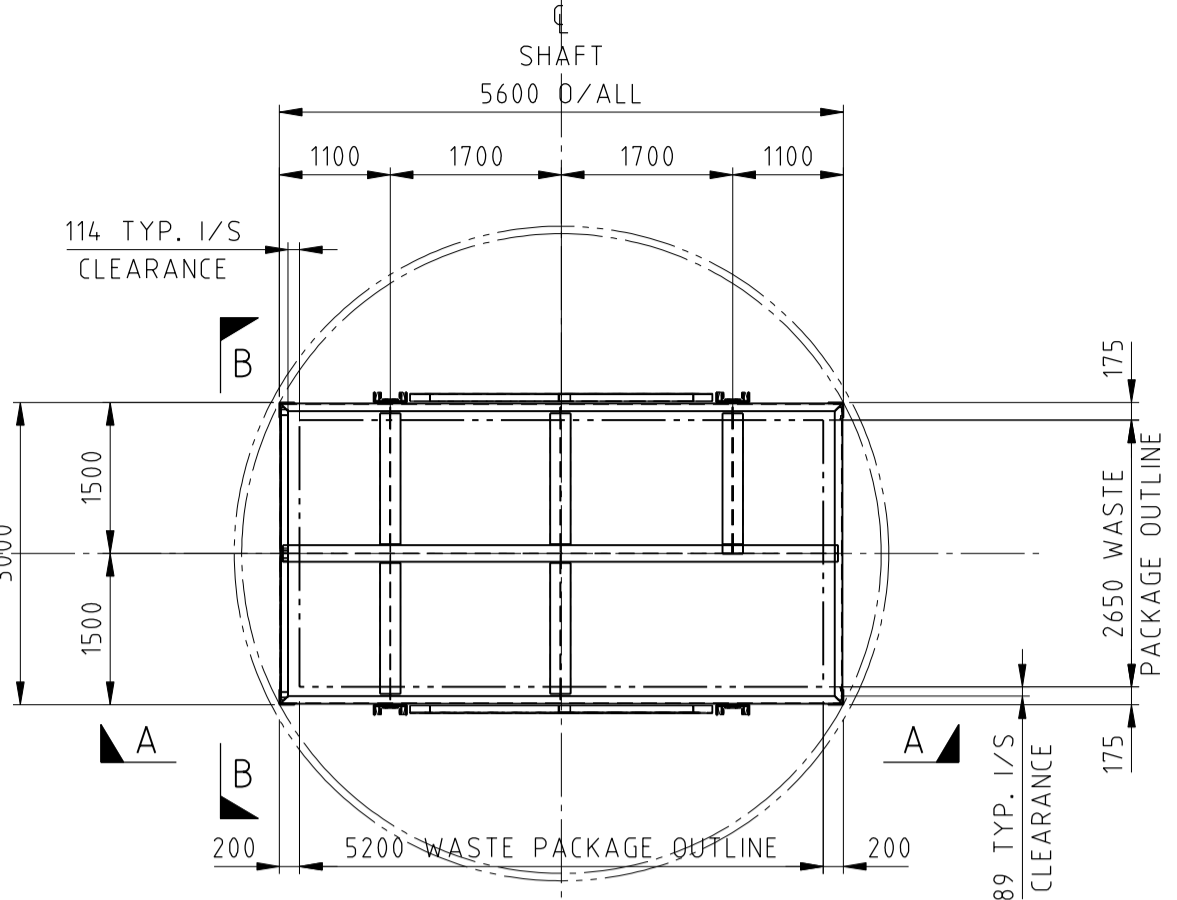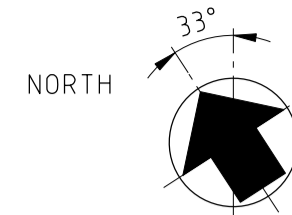


PLAN
 SCALE 1:75

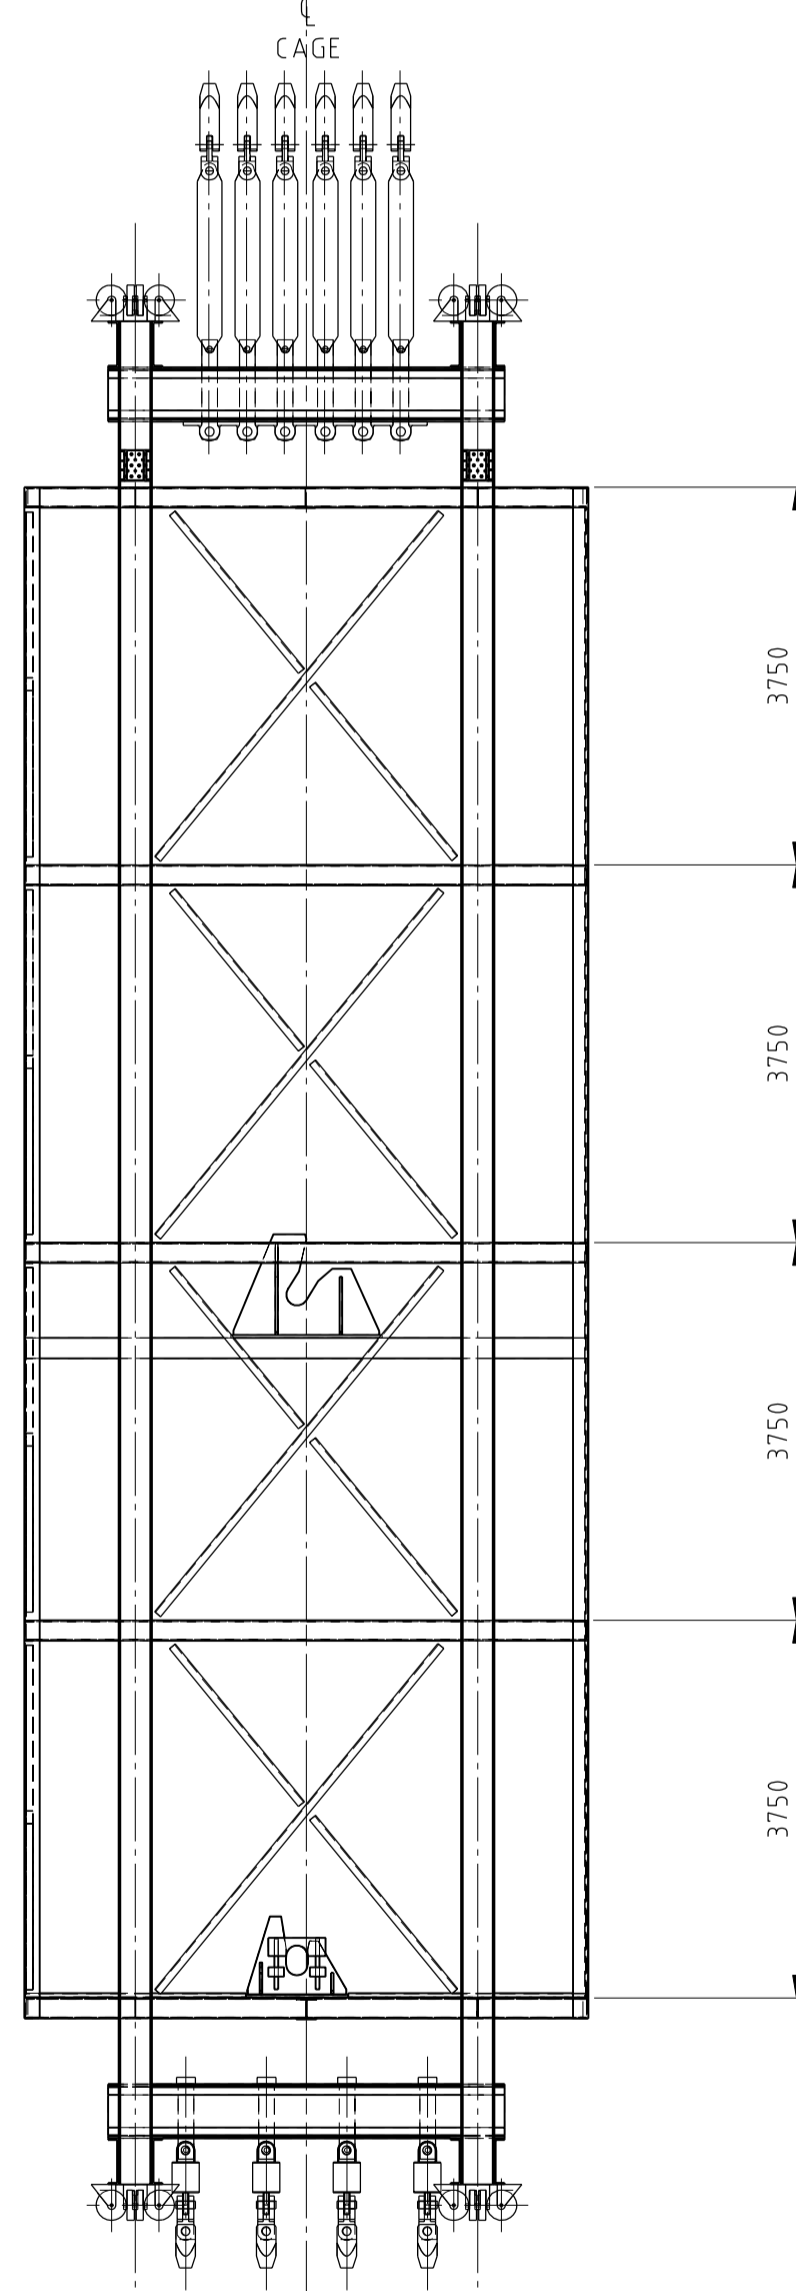


ELEVATION A-A
 SCALE 1:75

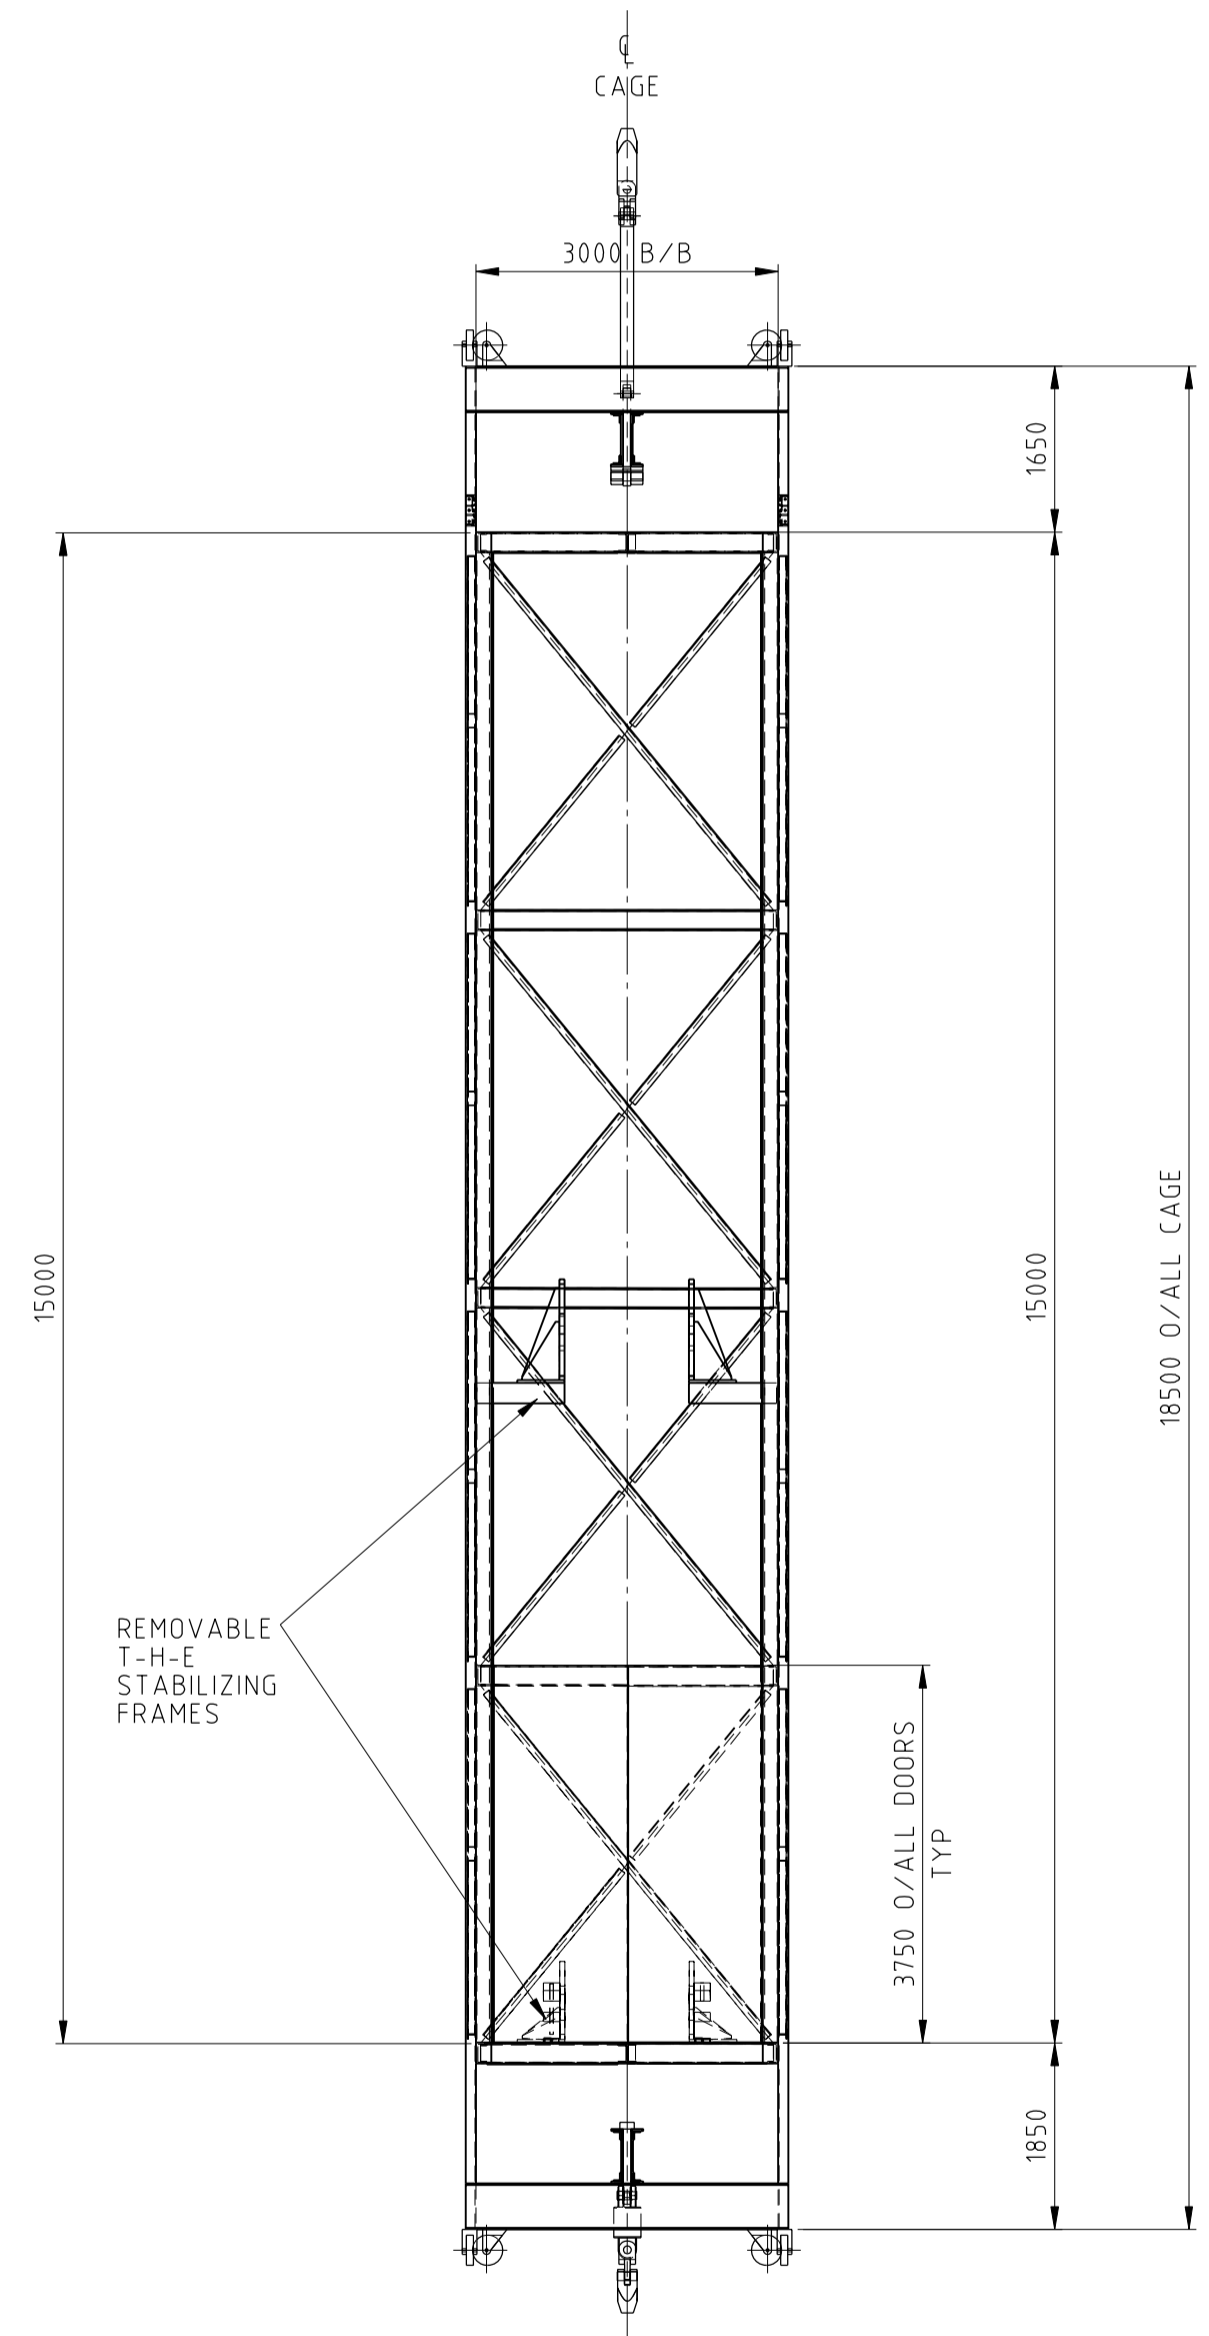


ELEVATION B-B
 SCALE 1:75

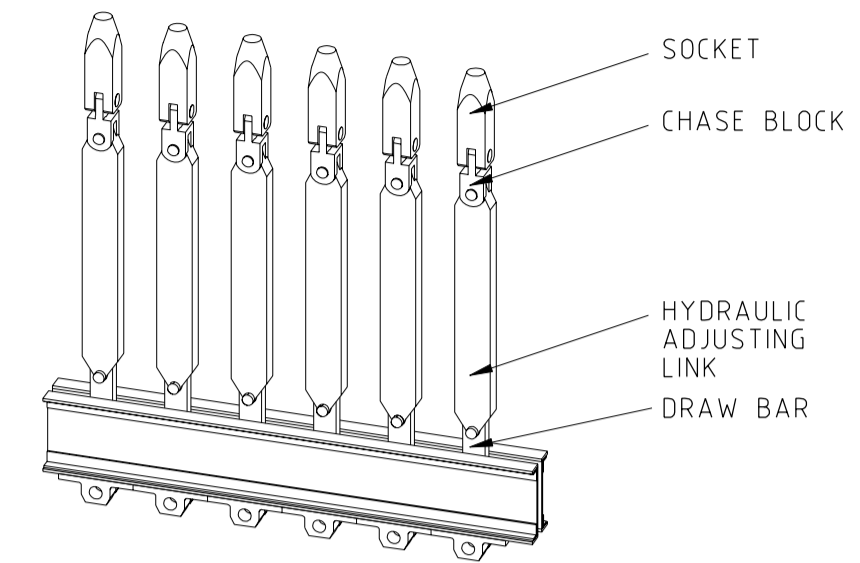

ISOMETRIC VIEW OF HEAD ROPE ATTACHMENT

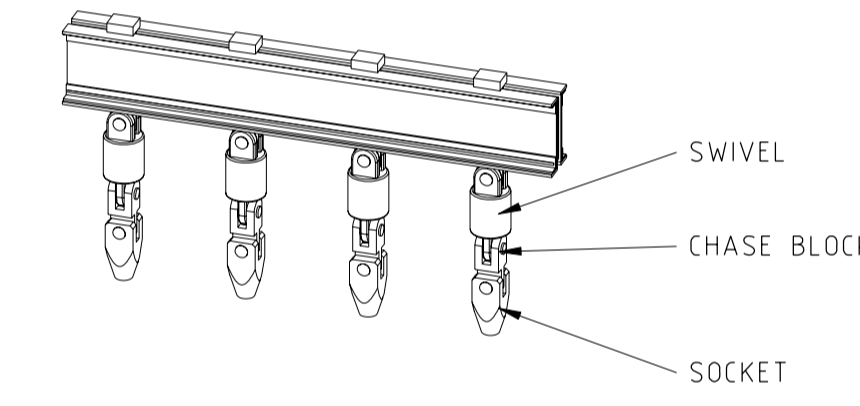

ISOMETRIC VIEW OF TAIL ROPE ATTACHMENT

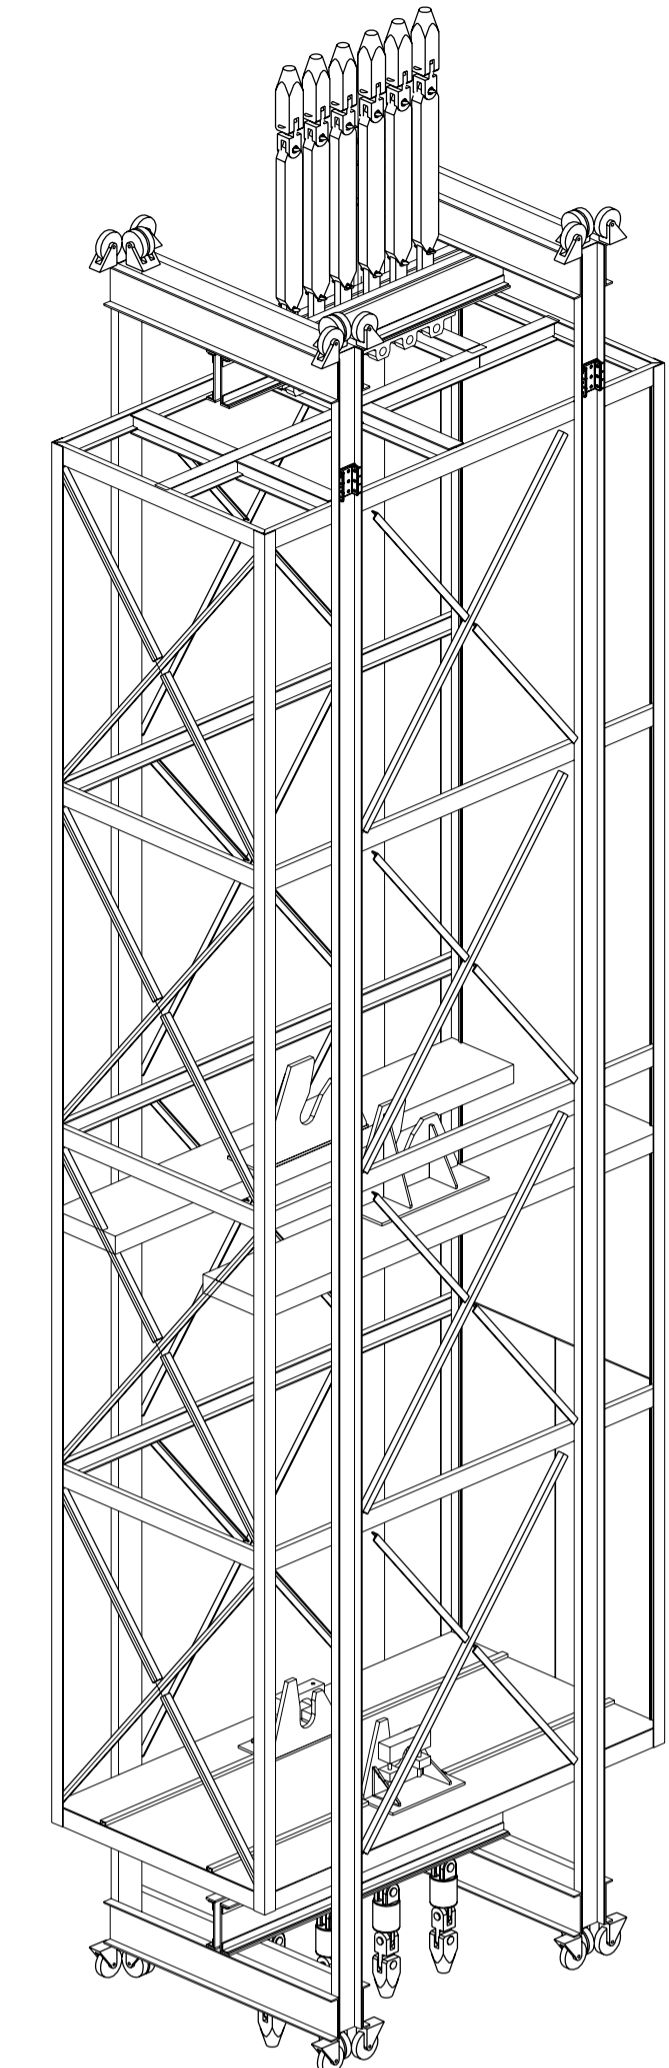

ISOMETRIC VIEW OF CAGE CONVEYANCE

ITEMS	ESTIMATED MASS
1. MAXIMUM PAYLOAD INCL. T-H-E STABILIZING FRAMES	44 000 KG
2. PRIMARY STEEL MEMBERS	22 658 KG
3. ROPE ATTACHMENTS	9 328 KG
4. ALLOWANCE FOR SUNDRIES	5 000 KG
5. TOTAL	80 986 KG

- GENERAL NOTE:-
1. ALL STRUCTURAL STEELWORK TO BE IN ACCORDANCE WITH CAN/CSA-S16-01
 2. ALL STRUCTURAL STEEL TO BE 350W UNLESS OTHERWISE NOTED
 3. DRAWING TO BE USED FOR PRELIMINARY DESIGN ONLY, NOT TO BE USED FOR CONSTRUCTION
 4. SIZE OF CONVEYANCE BASED ON SHAFT SIZE FROM CONCEPTUAL DESIGN REPORT
 5. FOR MORE DETAIL REGARDING ROPE ATTACHMENTS SEE H333000-WP405-35-122-0001

PRELIMINARY

DRAWING NO.	DRAWING TITLE
	REFERENCE DRAWINGS

NO.	DESCRIPTION	CHK'D	APP'D	DATE
	REVISIONS			

NOT FOR CONSTRUCTION
 This drawing has been reviewed for the purposes of DGR Preliminary Engineering only and must not be used for other purposes.

Stephen Keen
Digitally signed by Stephen Keen
 DN: cn=Stephen Keen, o=Hatch, email=s.keen@hatch.com, c=CA
 Date: 2009.11.13 14:13:13 -0500
 Work Package Owner

Area Lead
Digitally signed by G.R. Davidge
 DN: cn=G.R. Davidge, o=Hatch, email=g.r.davidge@hatch.com, c=CA
 Date: 2009.11.13 14:13:13 -0500
 Engineering Manager

Project Manager
Digitally signed by M.R. Dawborn
 DN: cn=M.R. Dawborn, o=Hatch, email=m.r.dawborn@hatch.com, c=CA
 Date: 2009.11.13 15:25:16 -0500
 Project Manager

Accepted by Owner
Digitally signed by Daniel Wilson
 DN: cn=Daniel Wilson, o=Hatch, email=d.wilson@hatch.com, c=CA
 Date: 2009.11.17 15:37:53 -0500

00 APPROVED FOR USE GRD SAA 09/11/11
 REV. ISSUE FOR AUTH. BY DATE
 ISSUE AUTHORIZATION

HATCH

DESIGNED BY: L. CLARK
 DATE: 26/08/09
 CHECKED BY: MC BOTHMA
 DATE: 26/08/09
 DISCIPLINE: ENGR.

DATE: PROJ. DES. COORD.
 DATE: PROJ. ENGR.

PROJ. MGR.: M.R. DAWBORN
 DATE: 2009-11-11

SCALE: 1:75
 OR AS NOTED


DWG. NO.: H333000-WP405-20-042-0003-02

REV. 00


NUCLEAR WASTE MANAGEMENT ORGANIZATION
 DEEP GEOLOGIC REPOSITORY PROJECT

SHAFT HOISTING SYSTEMS


MAIN SHAFT – PERMANENT CONDITION
 SINGLE DECK MAIN CAGE – KOEPE HOIST
 OPTION 2 – GENERAL ARRANGEMENT

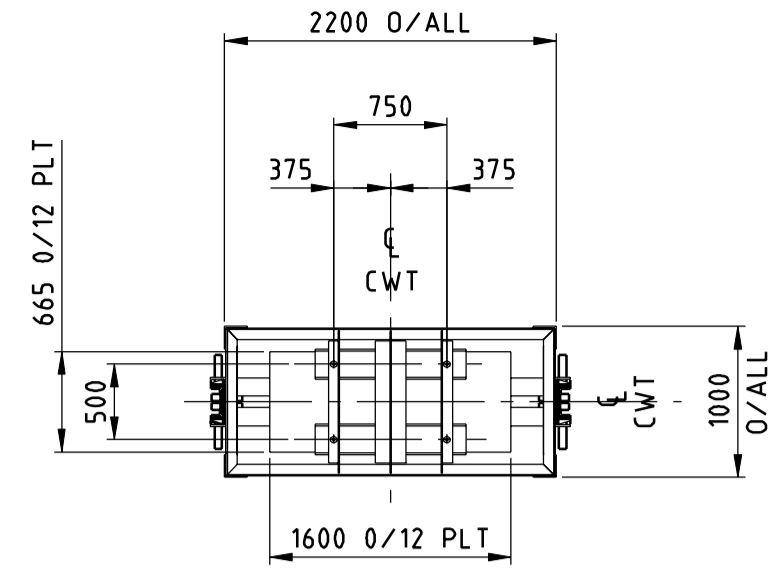


SECTION A-A
SCALE 1:50

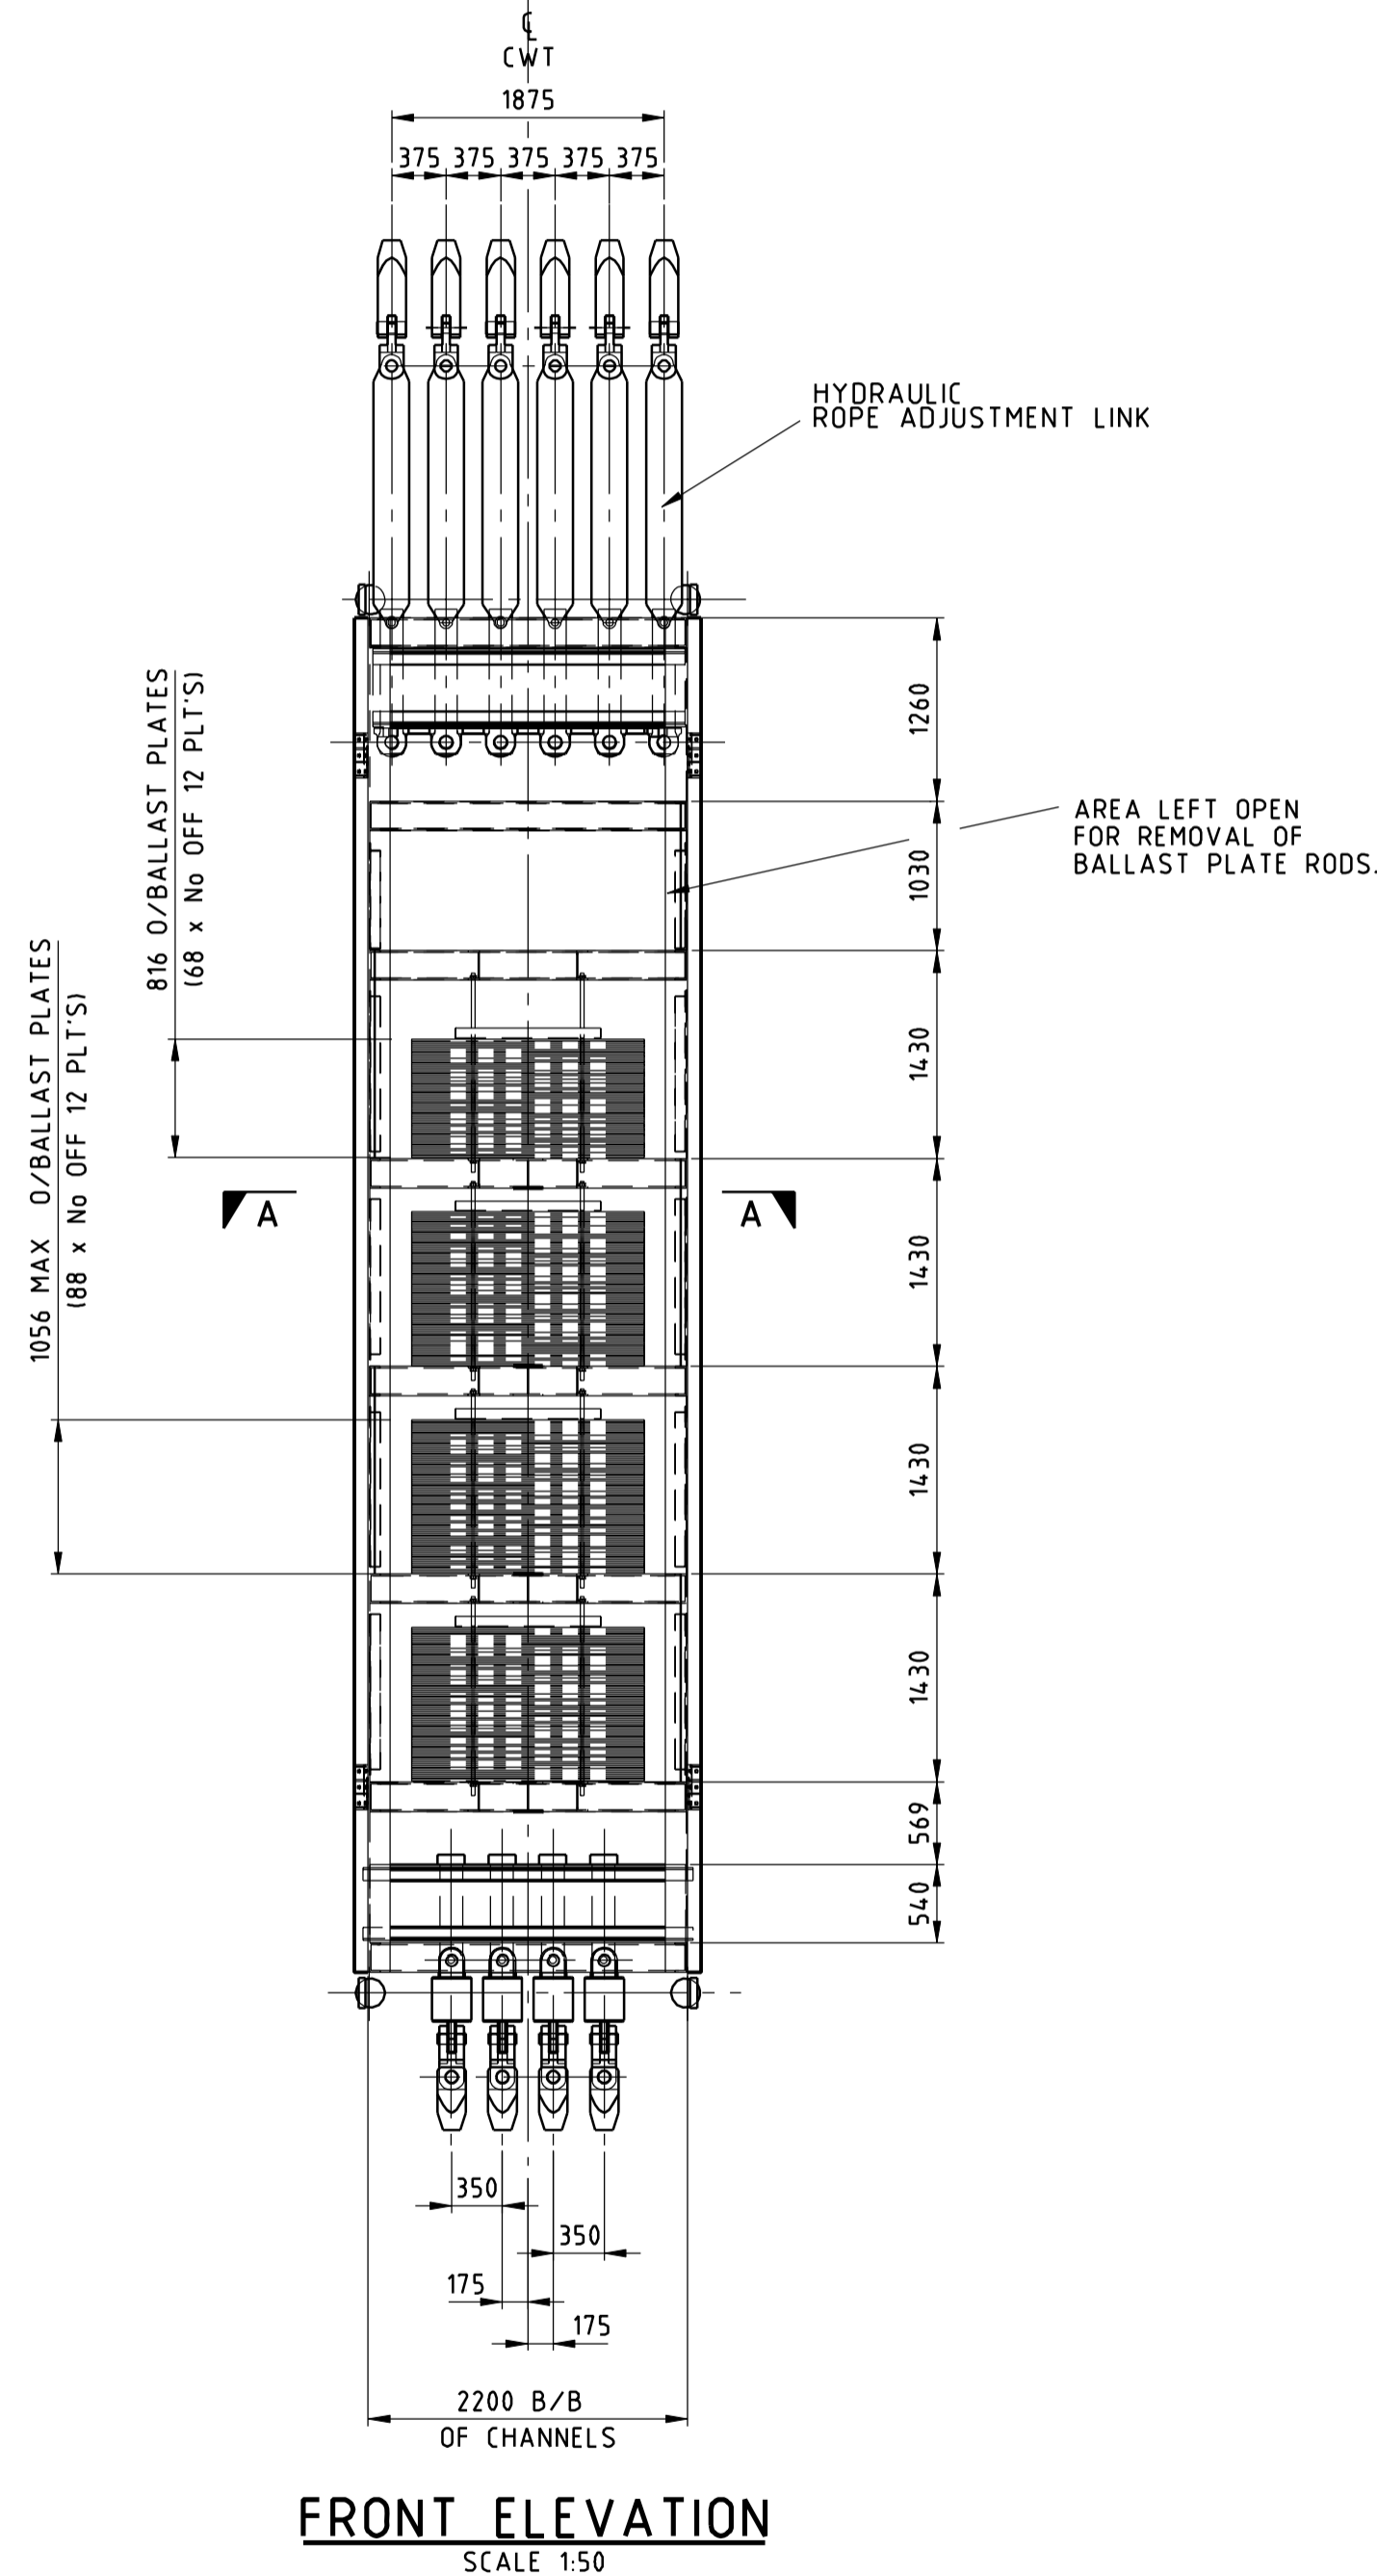

FRONT ELEVATION
SCALE 1:50

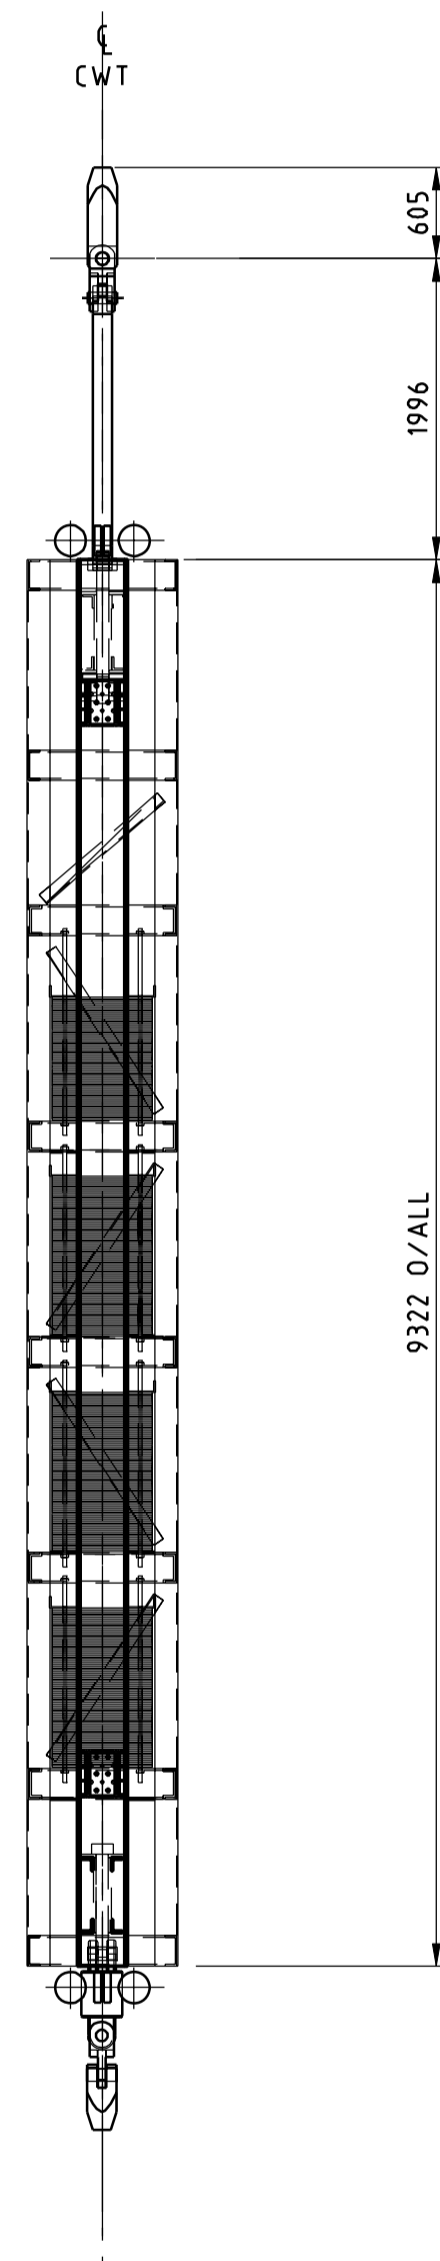

SIDE ELEVATION
SCALE 1:50

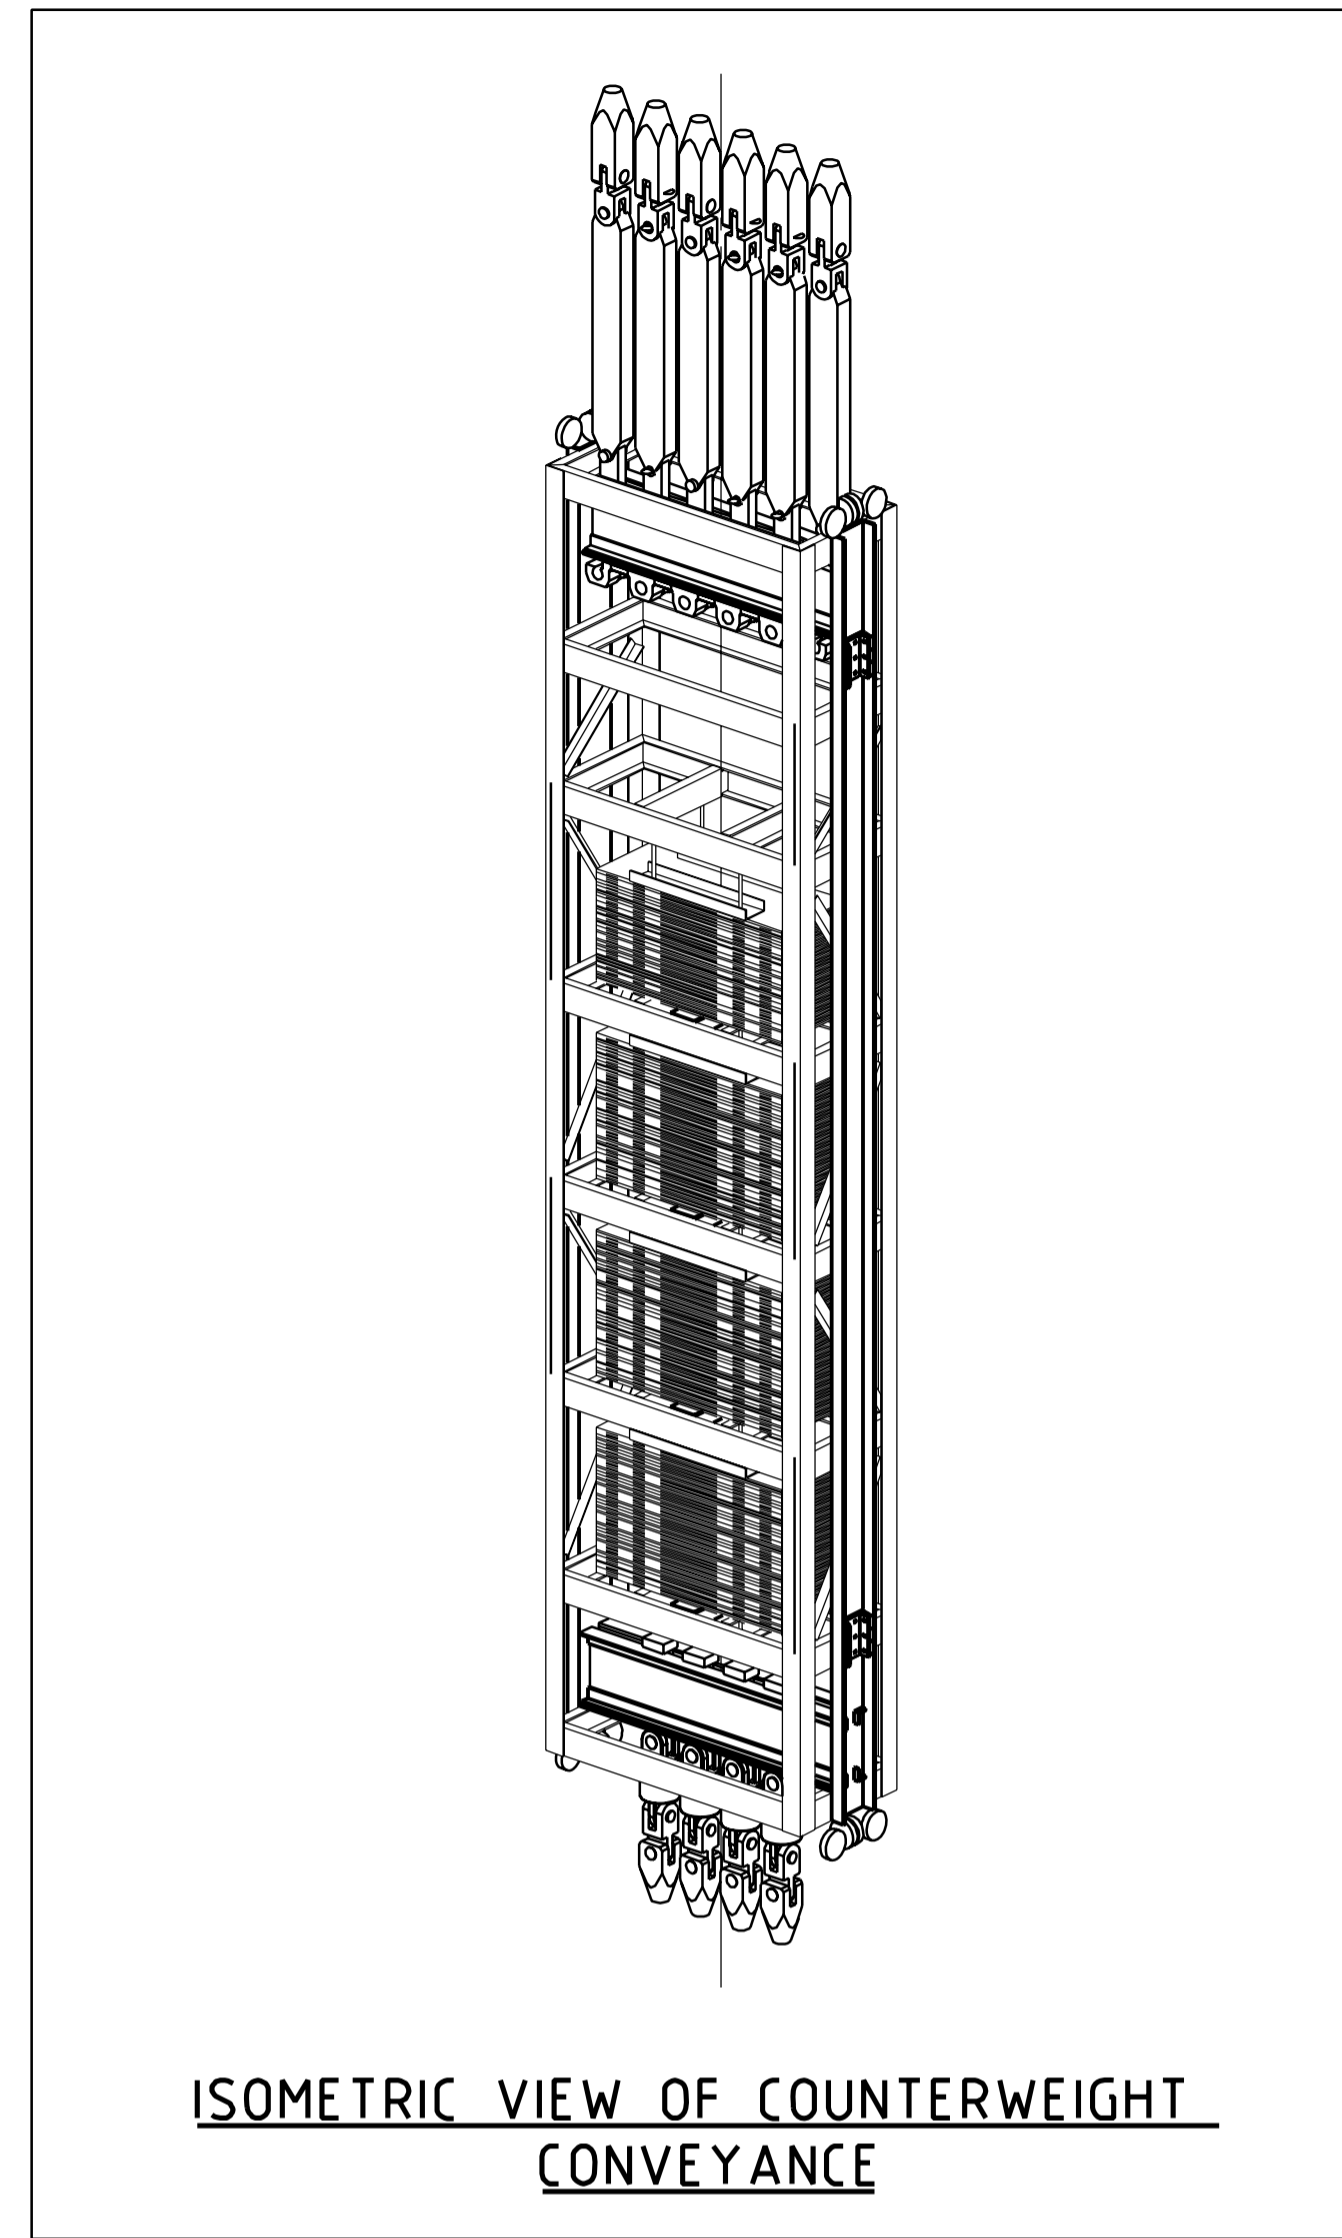

ISOMETRIC VIEW OF COUNTERWEIGHT
CONVEYANCE

ITEMS	ESTIMATED MASS
1. MAXIMUM PAYLOAD	33 273 KG
2. PRIMARY STEEL MEMBERS	16 355 KG
3. ROPE ATTACHMENTS	9 328 KG
4. TOTAL	58 956 KG


PRELIMINARY

BALLAST PLATES
1 x 12 THK PLATE = 100.3 kg
100.3 x 332 = 33 273 kg


GENERAL NOTE:-

- ALL STRUCTURAL STEELWORK TO BE IN ACCORDANCE WITH CAN/CSA-S16-01
- ALL STRUCTURAL STEEL TO BE CSA G40.21 350WT UNLESS OTHERWISE NOTED
- DRAWING TO BE USED FOR PRELIMINARY DESIGN ONLY, NOT TO BE USED FOR CONSTRUCTION
- SIZE OF CONVEYANCE BASED ON SHAFT SIZE FROM CONCEPTUAL DESIGN REPORT
- FOR MORE DETAIL ON RPDE ATTACHMENTS SEE H333000-WP405-042-35-122-0001


DRAWING NO.		DRAWING TITLE		NOT FOR CONSTRUCTION This drawing has been reviewed for the purposes of DGR Preliminary Engineering only and must not be used for other purposes. Work Package Owner Stephen Keen Area Lead G.R. Davidge Engineering Manager Shawn Aarons 201001.14.10.09.18-0900 Project Manager Shawn Aarons 201001.14.10.09.24-0900 Accepted by Owner		DESIGNED BY MC BOTHMA DATE 14/10/09 CHECKED BY S. KEEN DATE 14/10/09 PROJ. DES. COORD. DATE		DRAWN BY MC BOTHMA DATE 14/10/09 DISCIP. ENGR. DATE PROJ. ENGR. DATE		NUCLEAR WASTE MANAGEMENT ORGANIZATION DEEP GEOLOGIC REPOSITORY PROJECT	
REFERENCE DRAWINGS				01 REVISED COUNTERWEIGHT MASS NO. DESCRIPTION CHK'D APP'D DATE		01 APPROVED FOR USE GRD SAA 10/01/14 00 APPROVED FOR USE GRD SAA 09/12/10		PROJ. MGR. M. DAWBORN DATE 14/10/09		SHAFT HOISTING SYSTEMS	
				REVISIONS		ISSUE AUTHORIZATION		SCALE 1:50 OR AS NOTED		DWG. NO. H333000-WP405-20-042-0004	
										REV. 01	

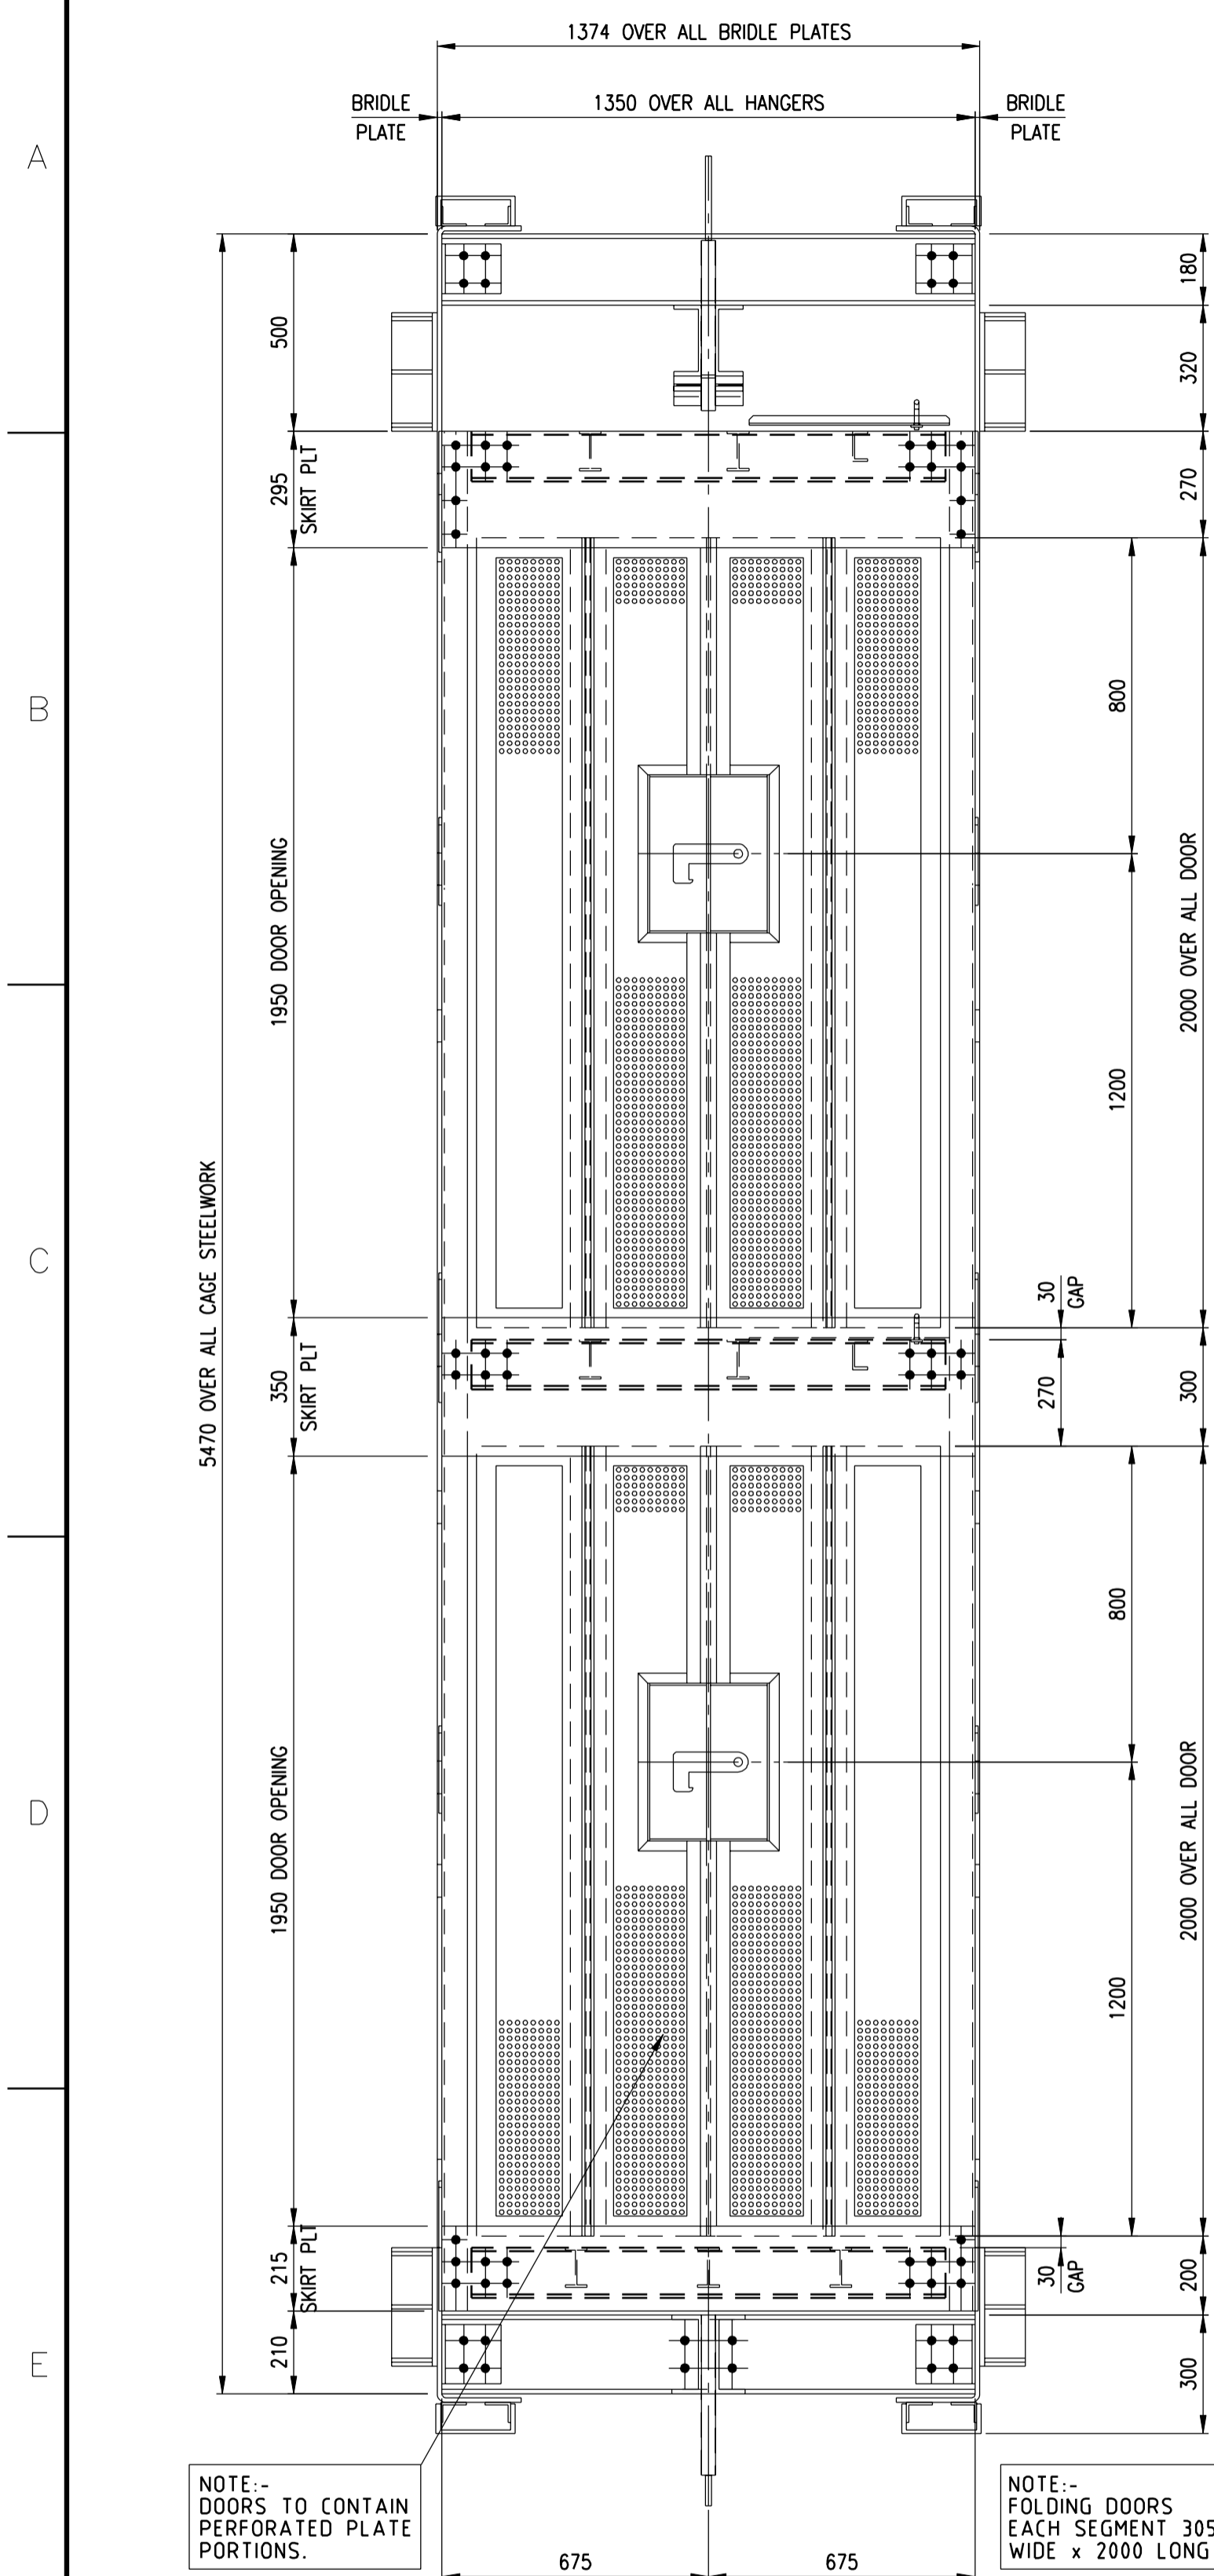


SIDE ELEVATION
SCALE 1:15

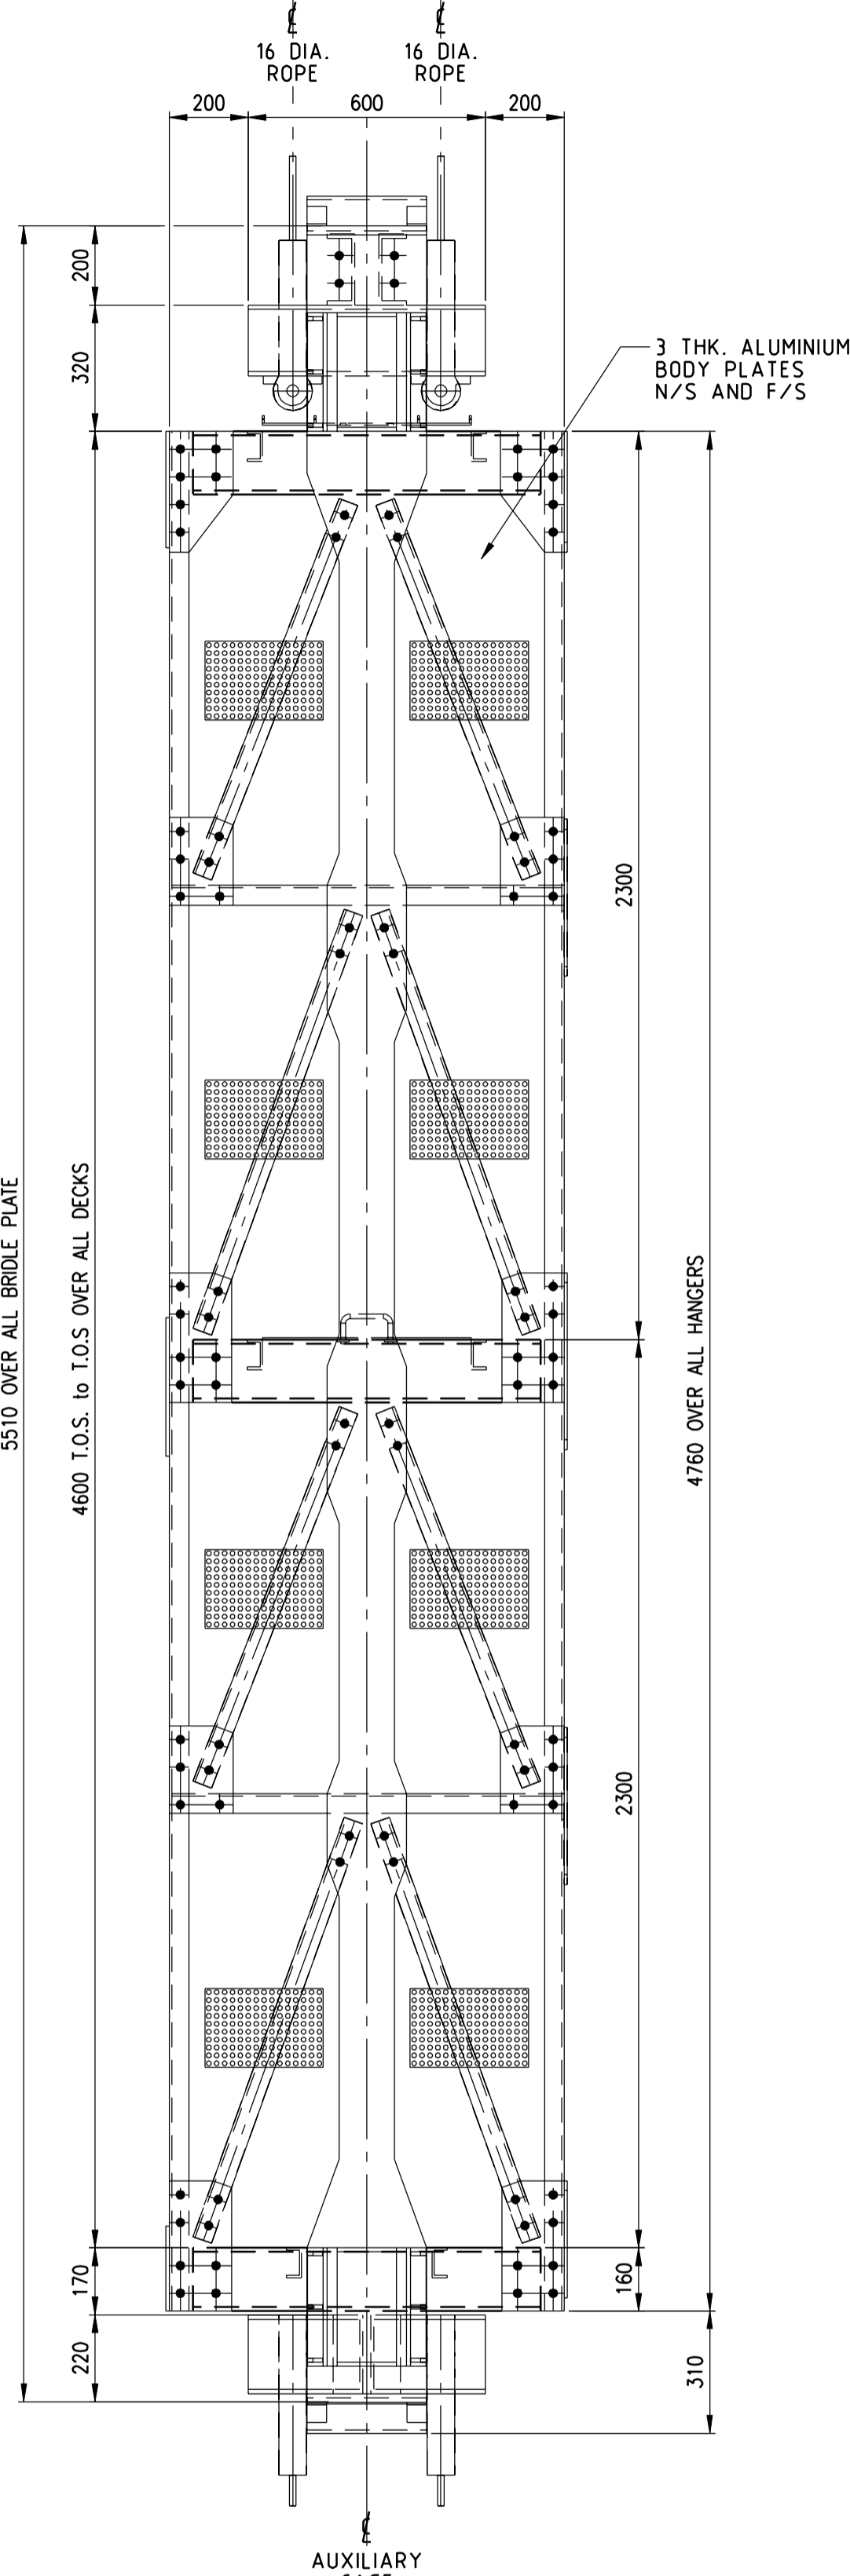


ELEVATION ON AUXILIARY CAGE
SCALE 1:15

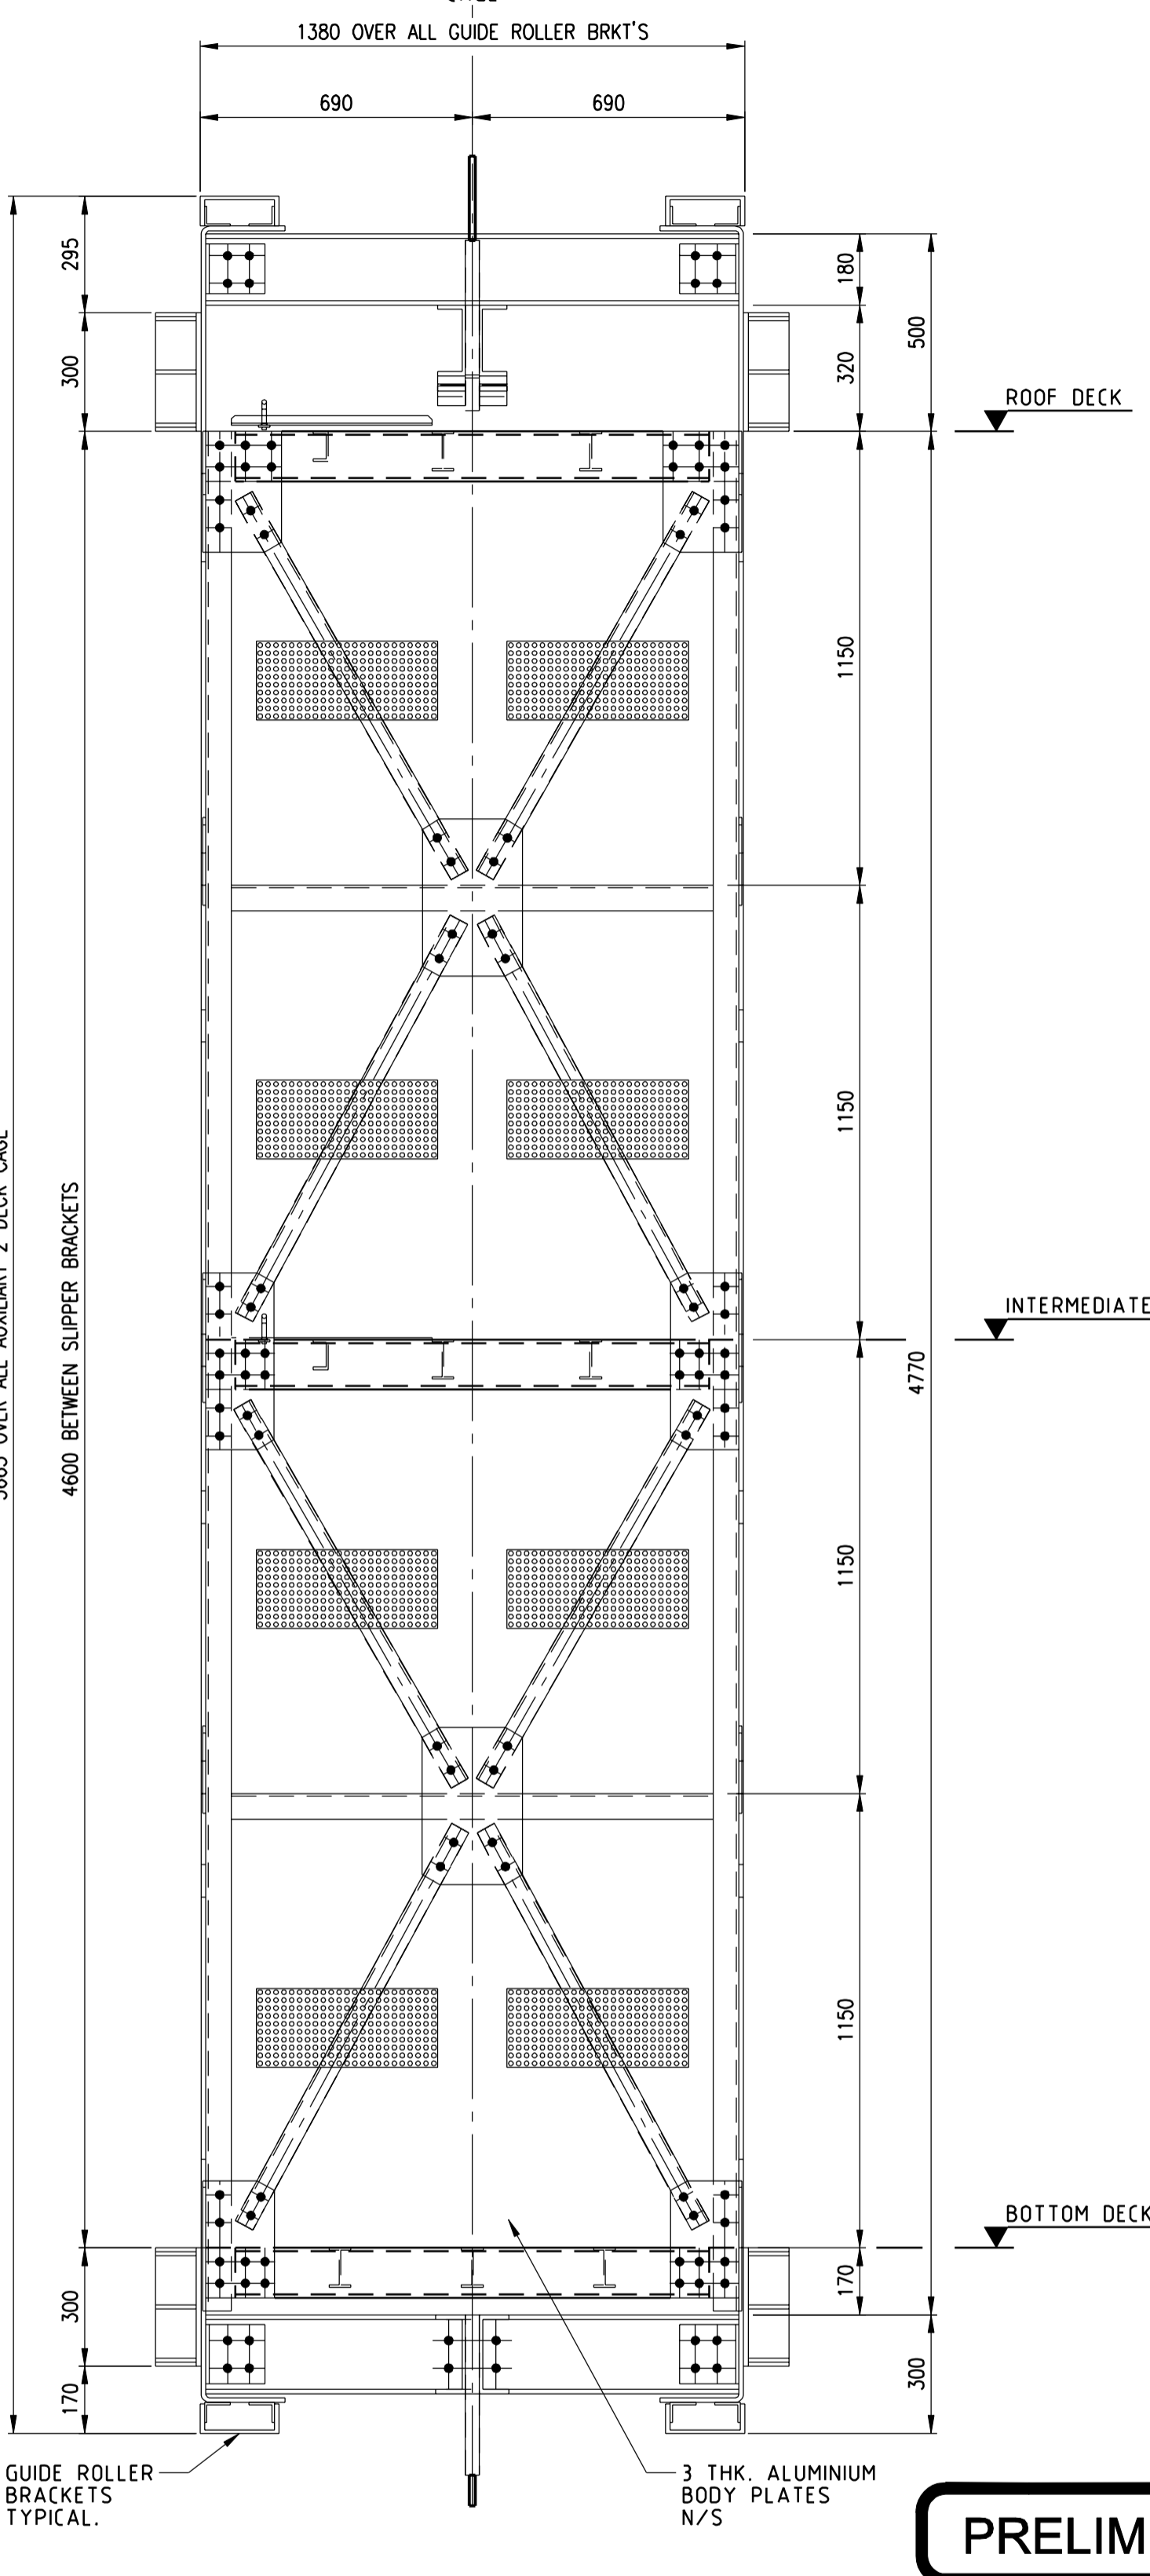


SIDE ELEVATION
SCALE 1:15

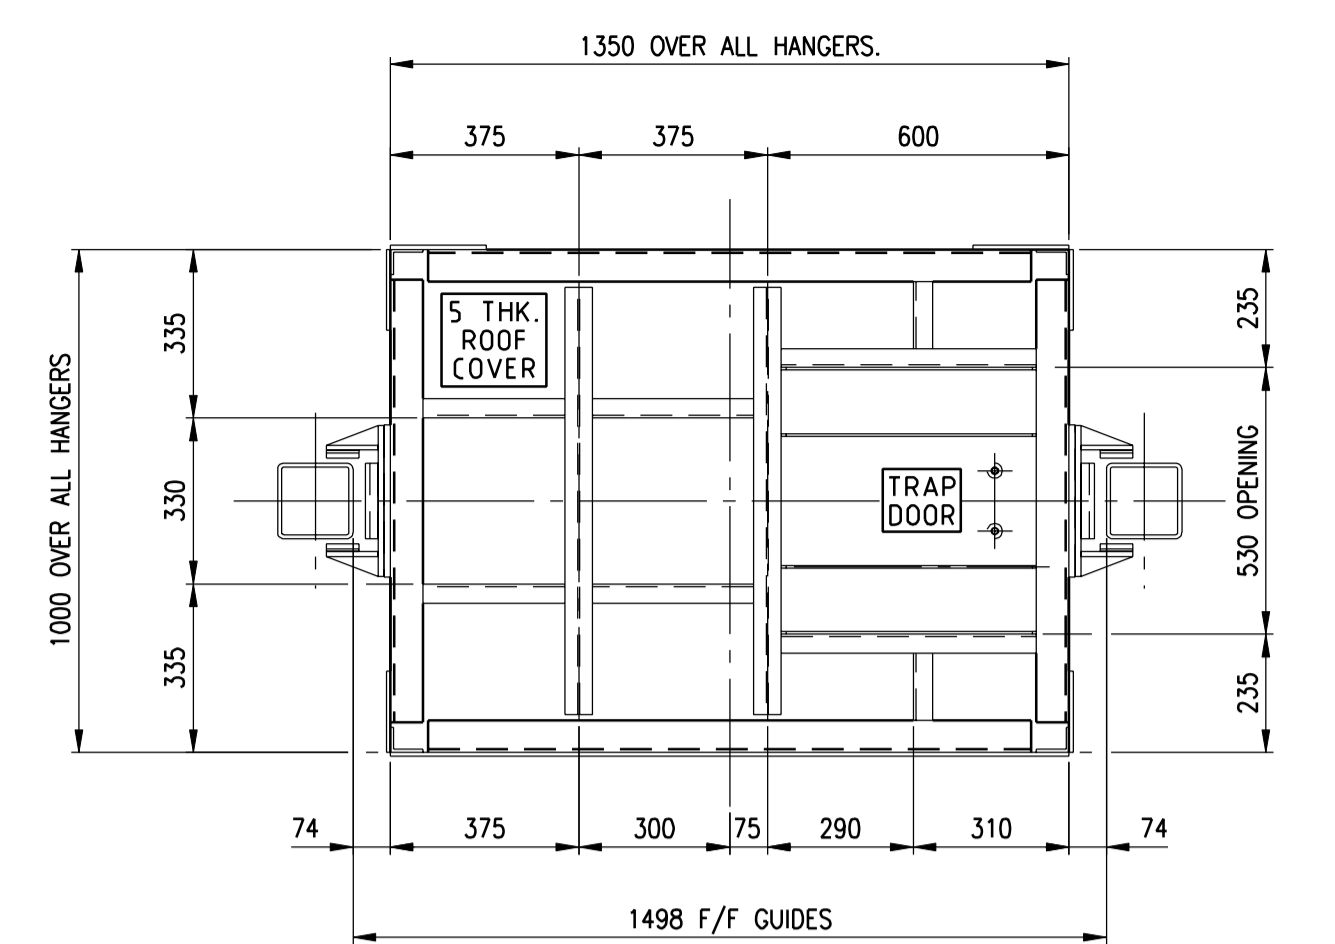

PLAN ON ROOF DECK
SCALE 1:15

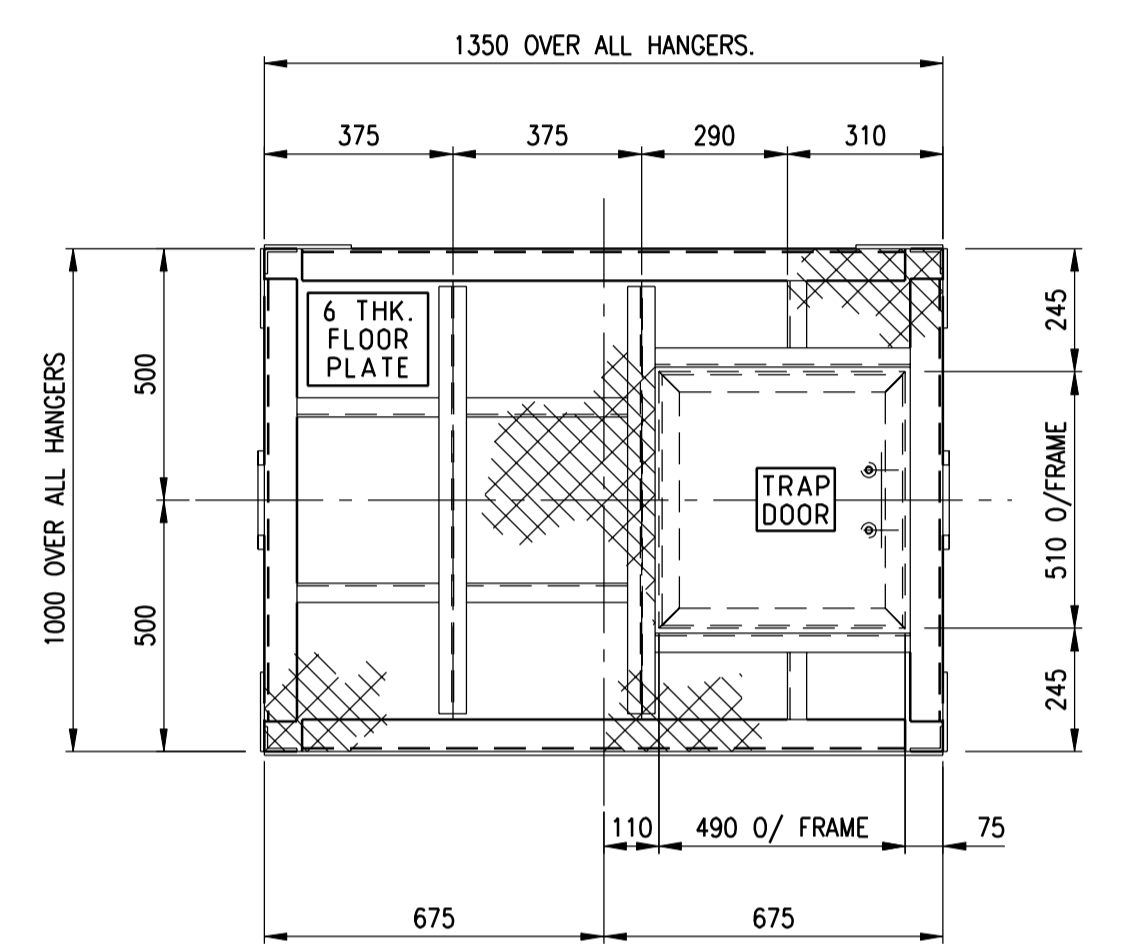

PLAN ON INTERMEDIATE DECK
SCALE 1:15

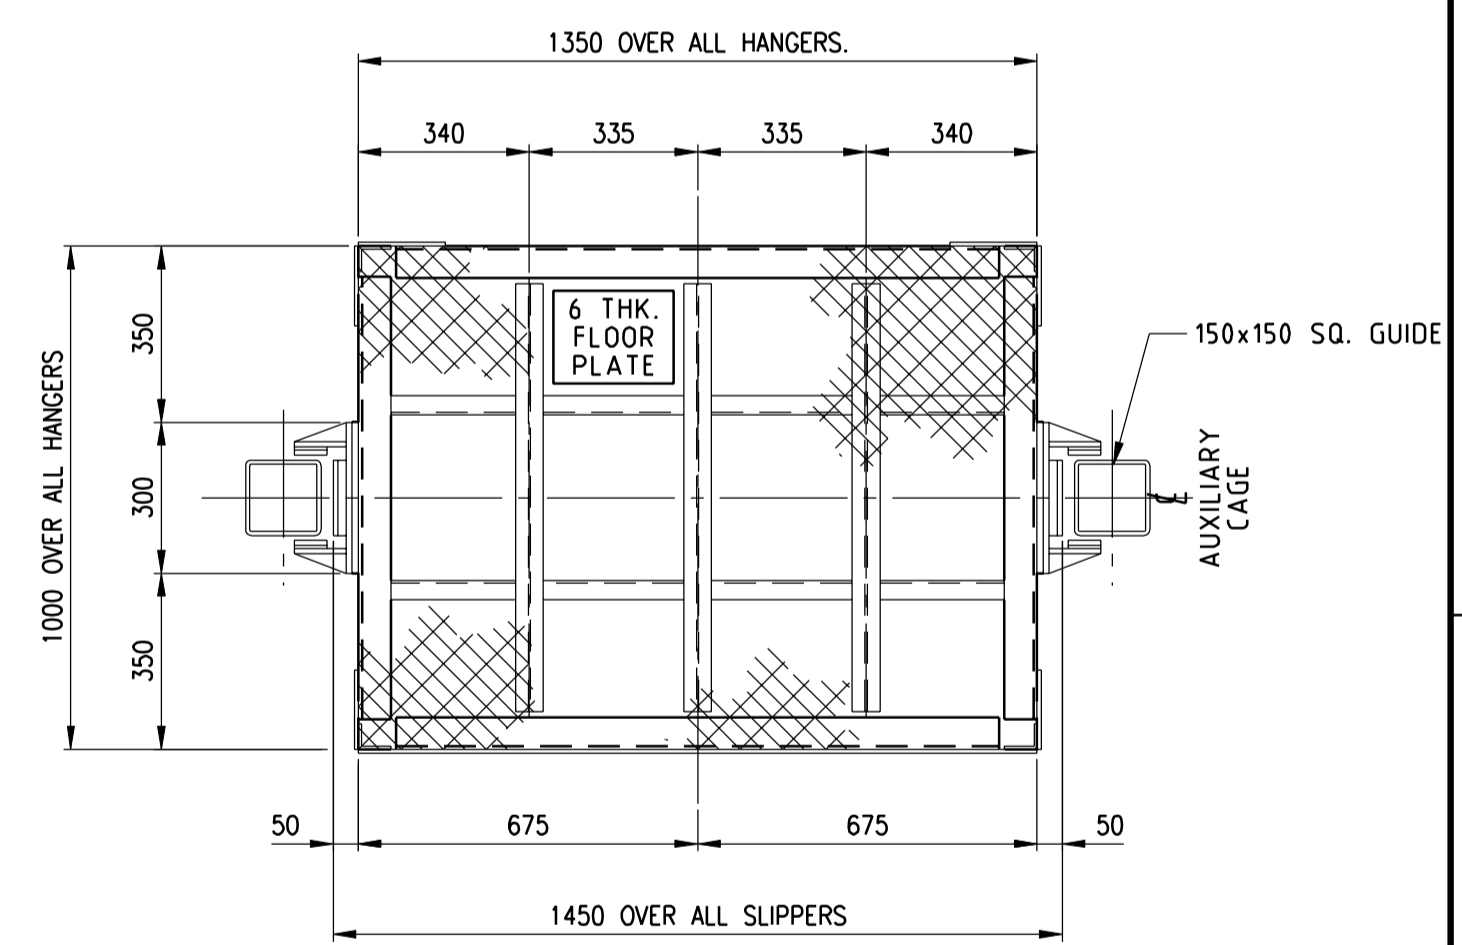

PLAN ON BOTTOM DECK
SCALE 1:15

PRELIMINARY

NOTE - CAGE FLOOR AREA = 1.3m² PER DECK.

ITEM No.	DESCRIPTION	ESTIMATED MASS
1.	MATERIAL TRANSPORT	1 270 Kg
2.	PERSONNEL TRANSPORT	1 080 Kg - 6 PEOPLE @ 90 Kg PER DECK
3.	PRIMARY STEEL MEMBERS	1 650 Kg
4.	ROPE ATTACHMENTS	250 Kg
5.	ALLOWANCE FOR SUNDRIES	250 Kg
6.	TOTAL ESTIMATED MAXIMUM MASS	3 420 Kg.

GENERAL NOTES.
 1. ALL STRUCTURAL STEELWORK TO BE IN ACCORDANCE WITH CAN/CSA-S16-01.
 2. ALL STRUCTURAL STEEL TO BE 350WA UNLESS OTHERWISE NOTED.
 3. THIS DRAWING TO BE USED FOR PRELIMINARY DESIGN ONLY, NOT TO BE USED FOR CONSTRUCTION

NOT FOR CONSTRUCTION
 This drawing has been reviewed for the purposes of DGR Preliminary Engineering only and must not be used for other purposes.
 Work Package Owner
Stephen Keen
 Area Lead
 Digitally signed by G.R. Davidge
 Date: 2009.12.10 15:13:48 +05'00'
 Engineering Manager
 Digitally signed by M. Dawborn
 Date: 2009.12.10 15:21:05 +05'00'
 Project Manager
 Digitally signed by M. Dawborn
 Date: 2009.12.10 15:21:05 +05'00'

HATCH
 DESIGNED BY: M.C.
 DATE: 2009/11/06
 CHECKED BY: S. KEEN
 DATE: 2009/12/06
 PROJECT DES. COORD.: M. DAWBORN
 DATE: 2009/11/06

NUCLEAR WASTE MANAGEMENT ORGANIZATION
 DEEP GEOLOGIC REPOSITORY PROJECT
 SHAFT HOISTING SYSTEMS
 MAIN SHAFT - PERMANENT CONDITION
 AUXILIARY 2 DECK CAGE
 GENERAL ARRANGEMNT


DRAWING NO.	DRAWING TITLE

NO.	DESCRIPTION	CHK'D	APP'D	DATE


REV.	ISSUE FOR	SA	GRD	DATE
00	APPROVED FOR USE			09/12/10

SCALE	DWG. NO.	REV.
1:15 OR AS NOTED	H333000-WP405-20-042-0005	00


H333000-WP405-20-042-0010
ON DWG

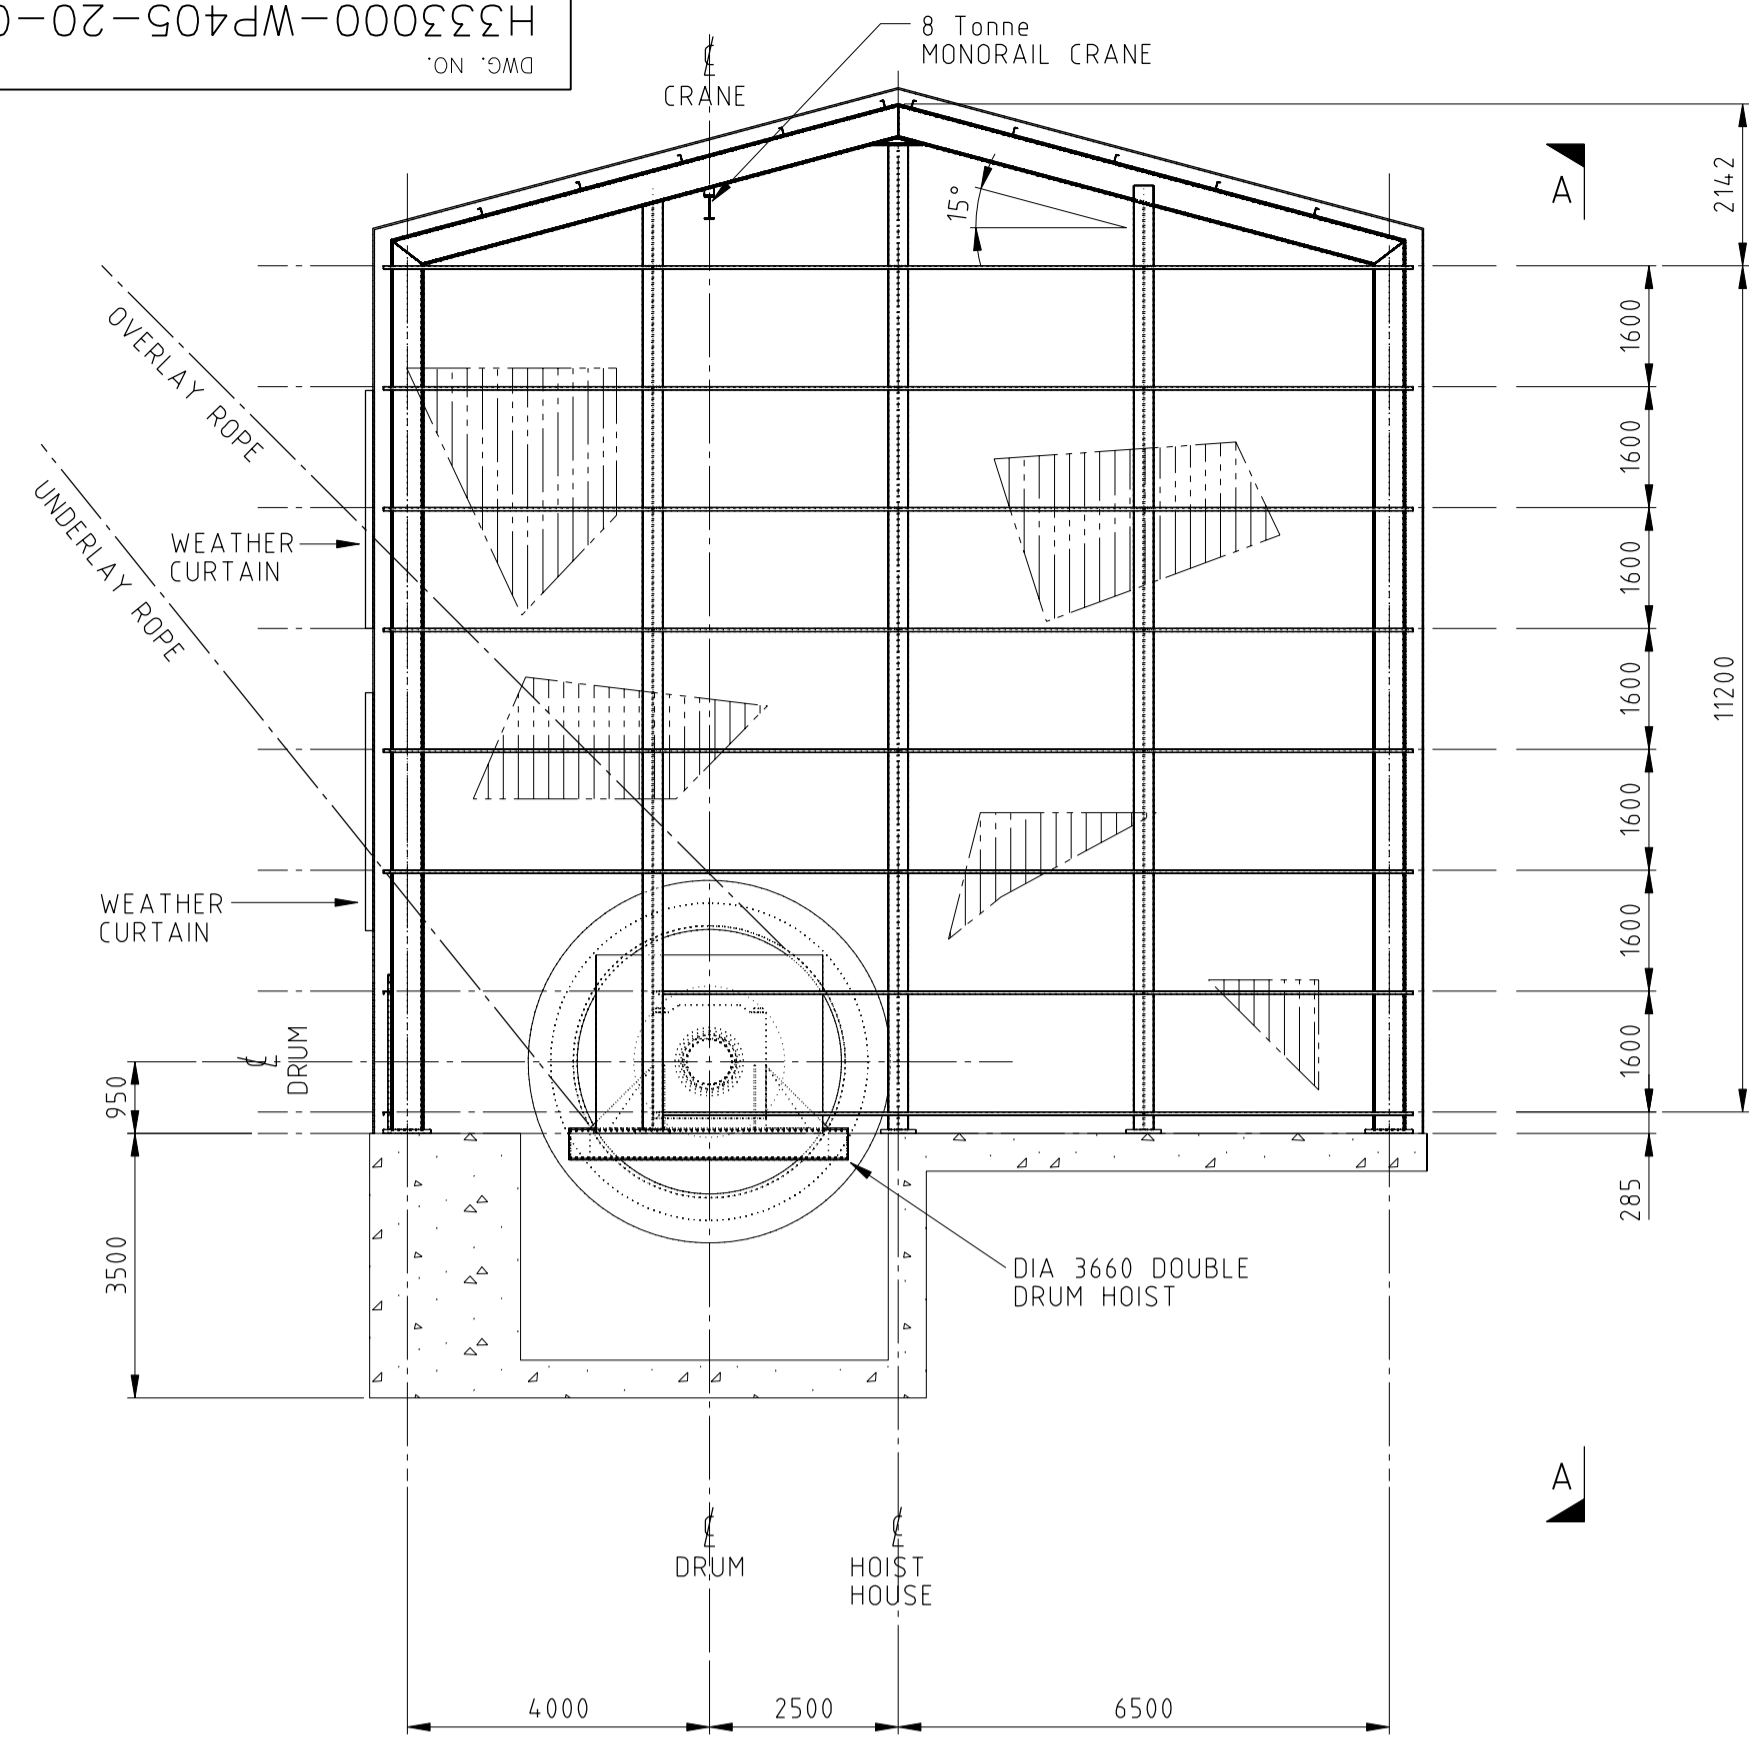


FRONT VIEW
SCALE 1:100

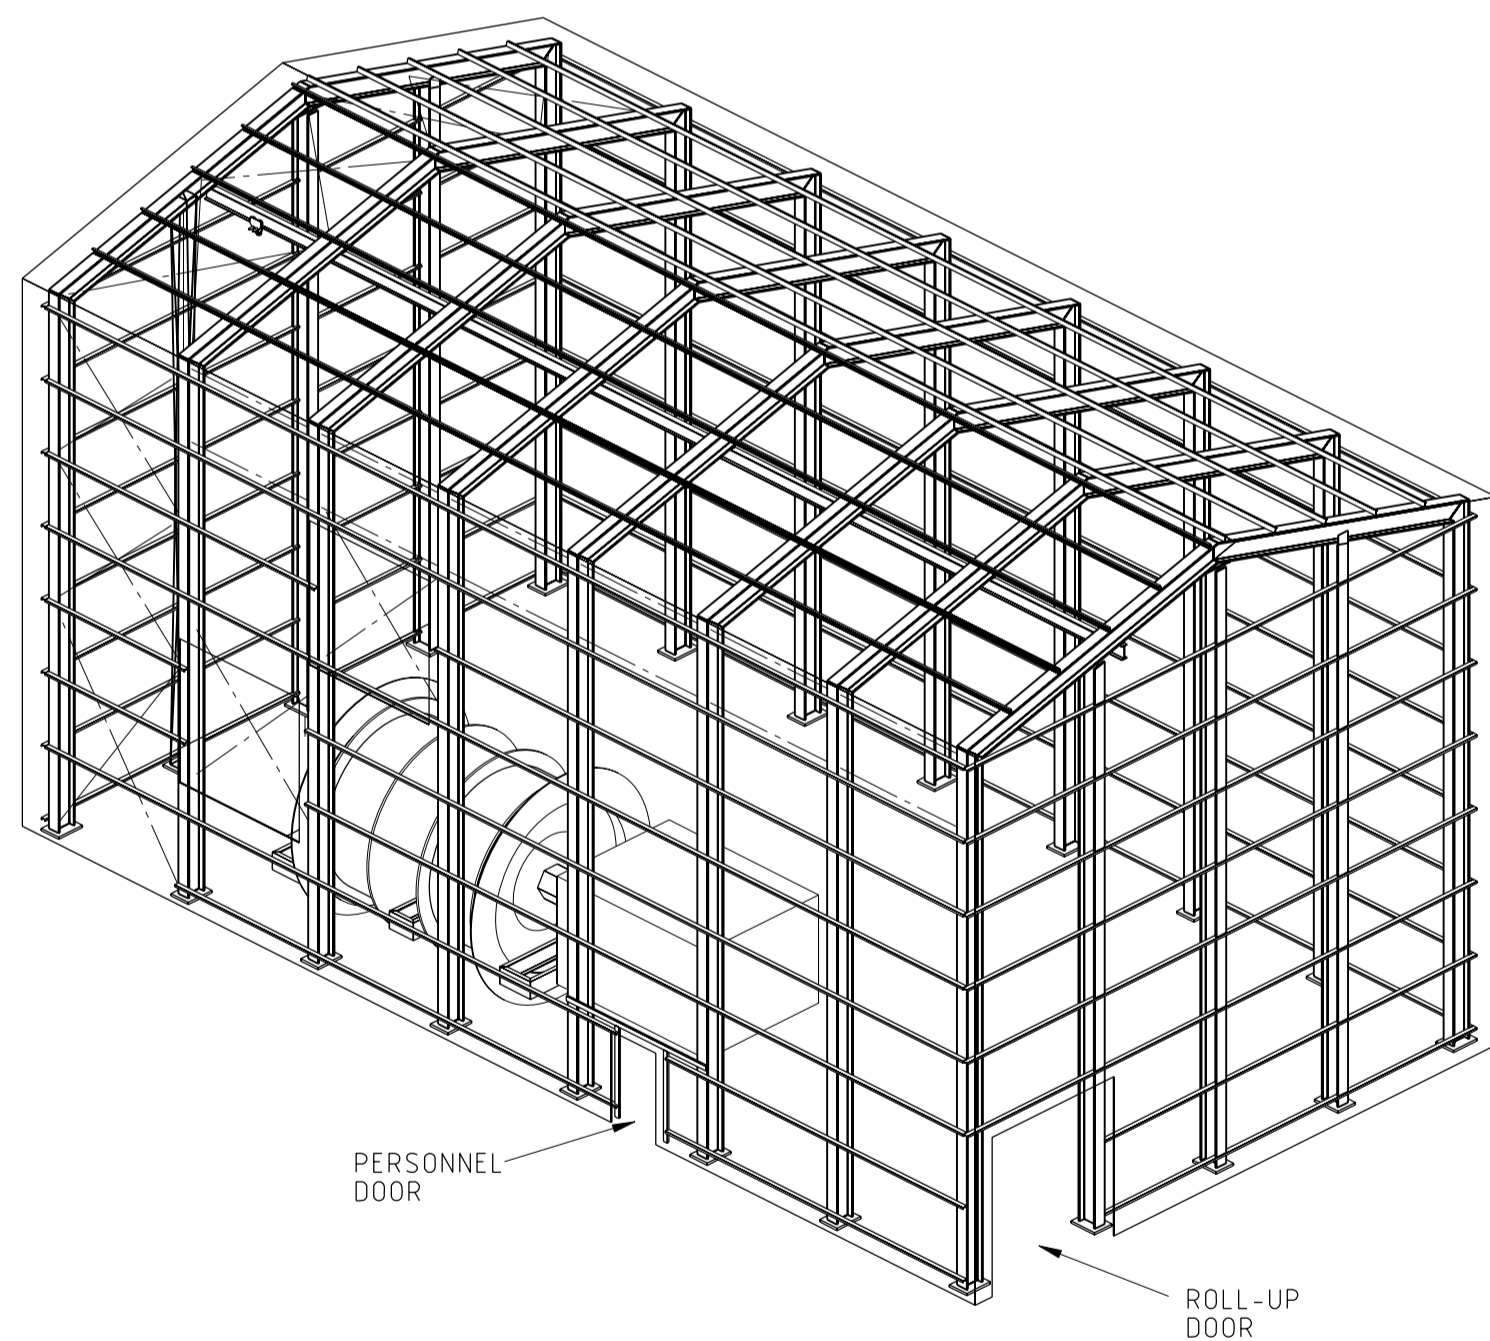

ISOMETRIC VIEW

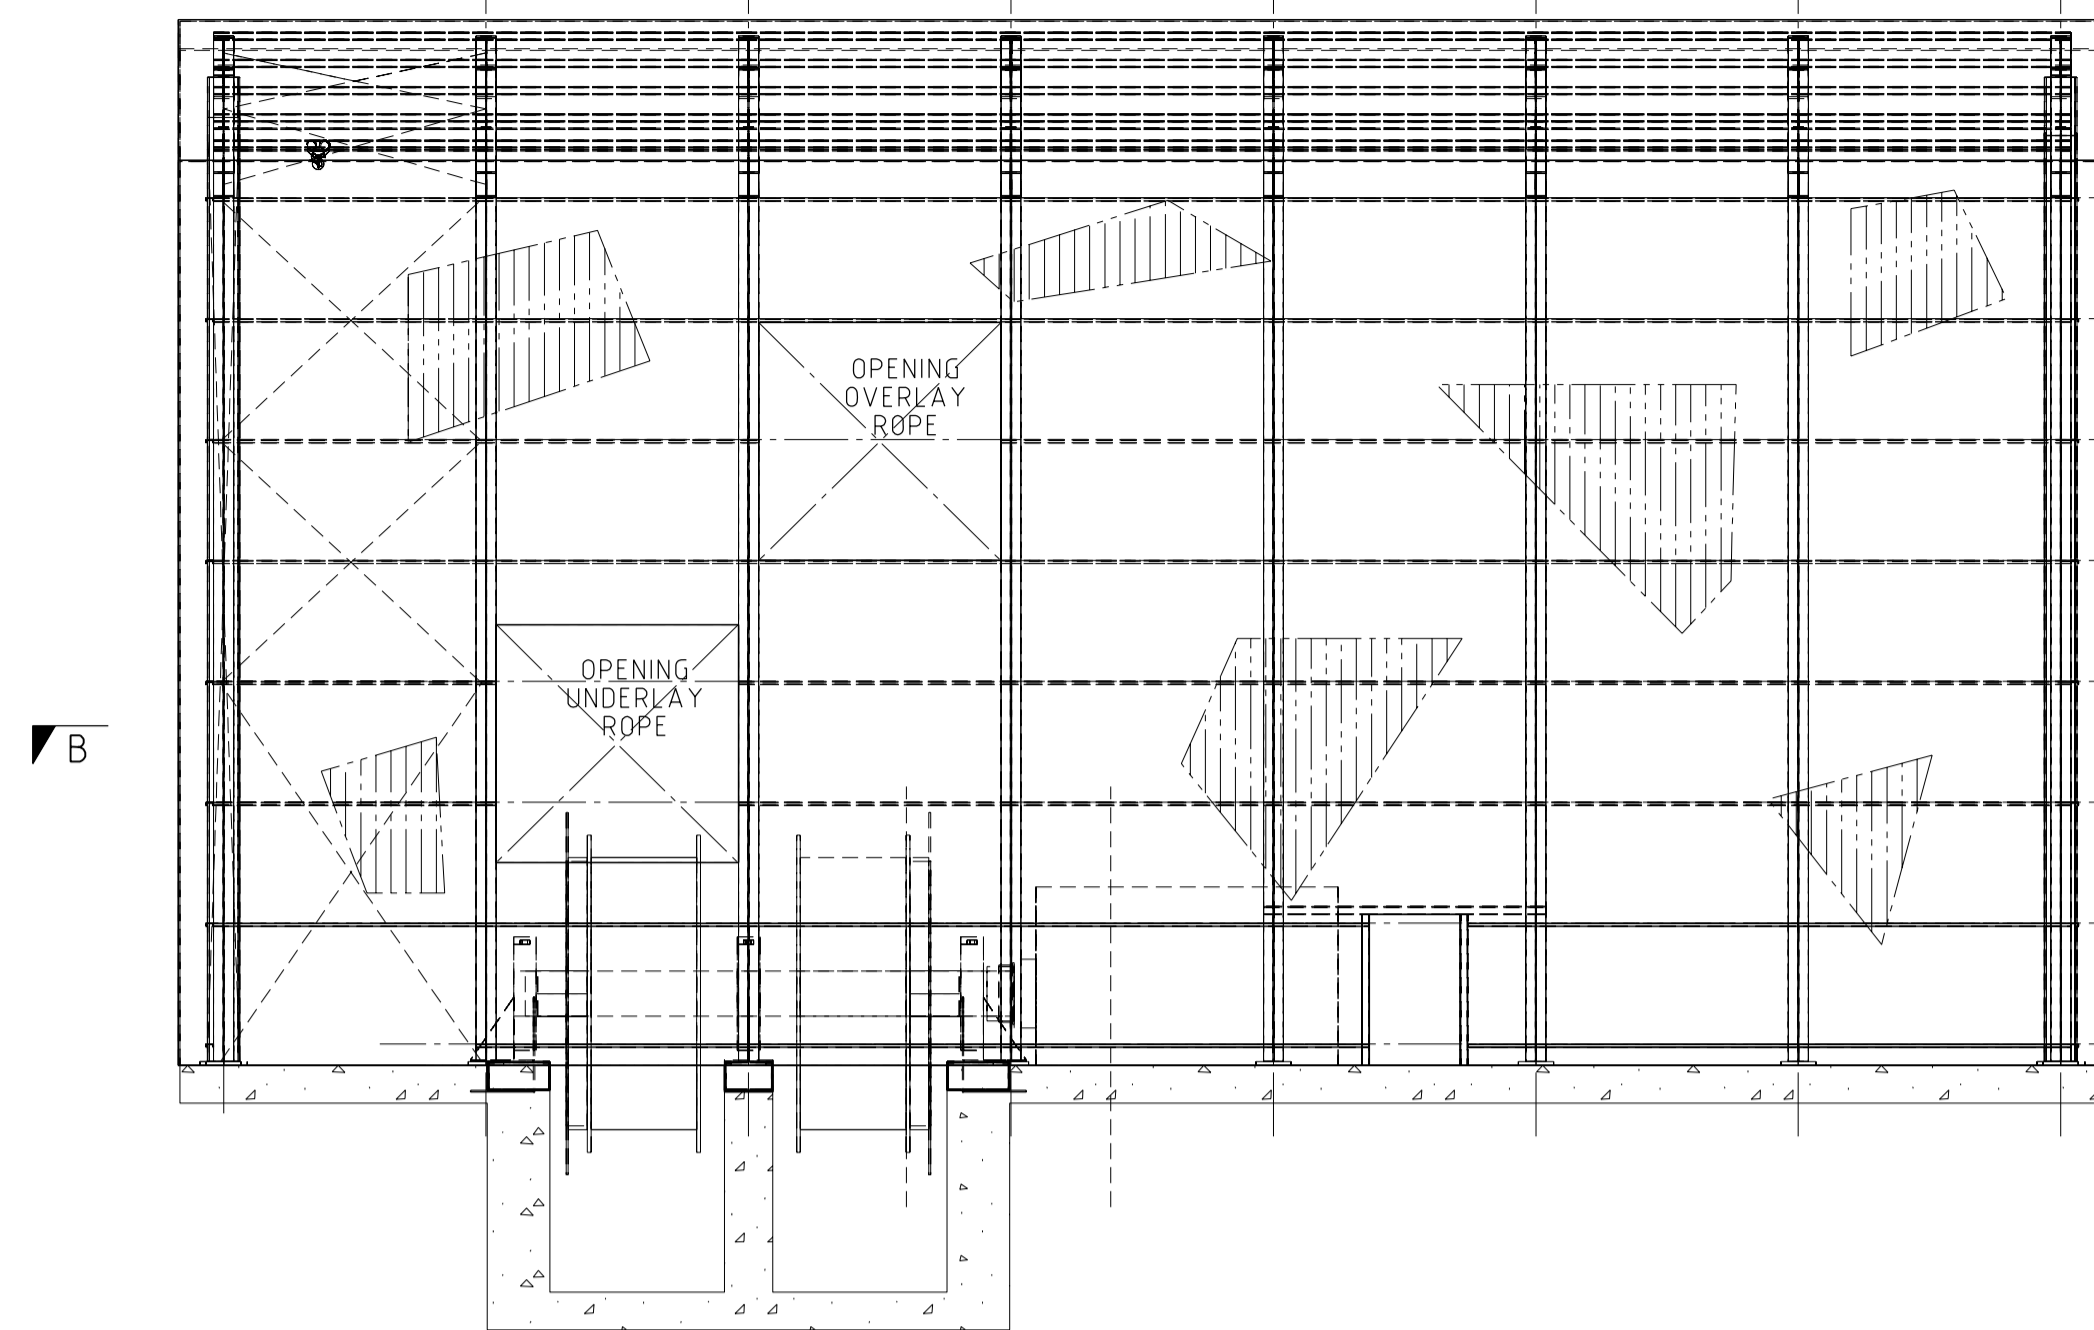

ELEVATION A-A
SCALE 1:100

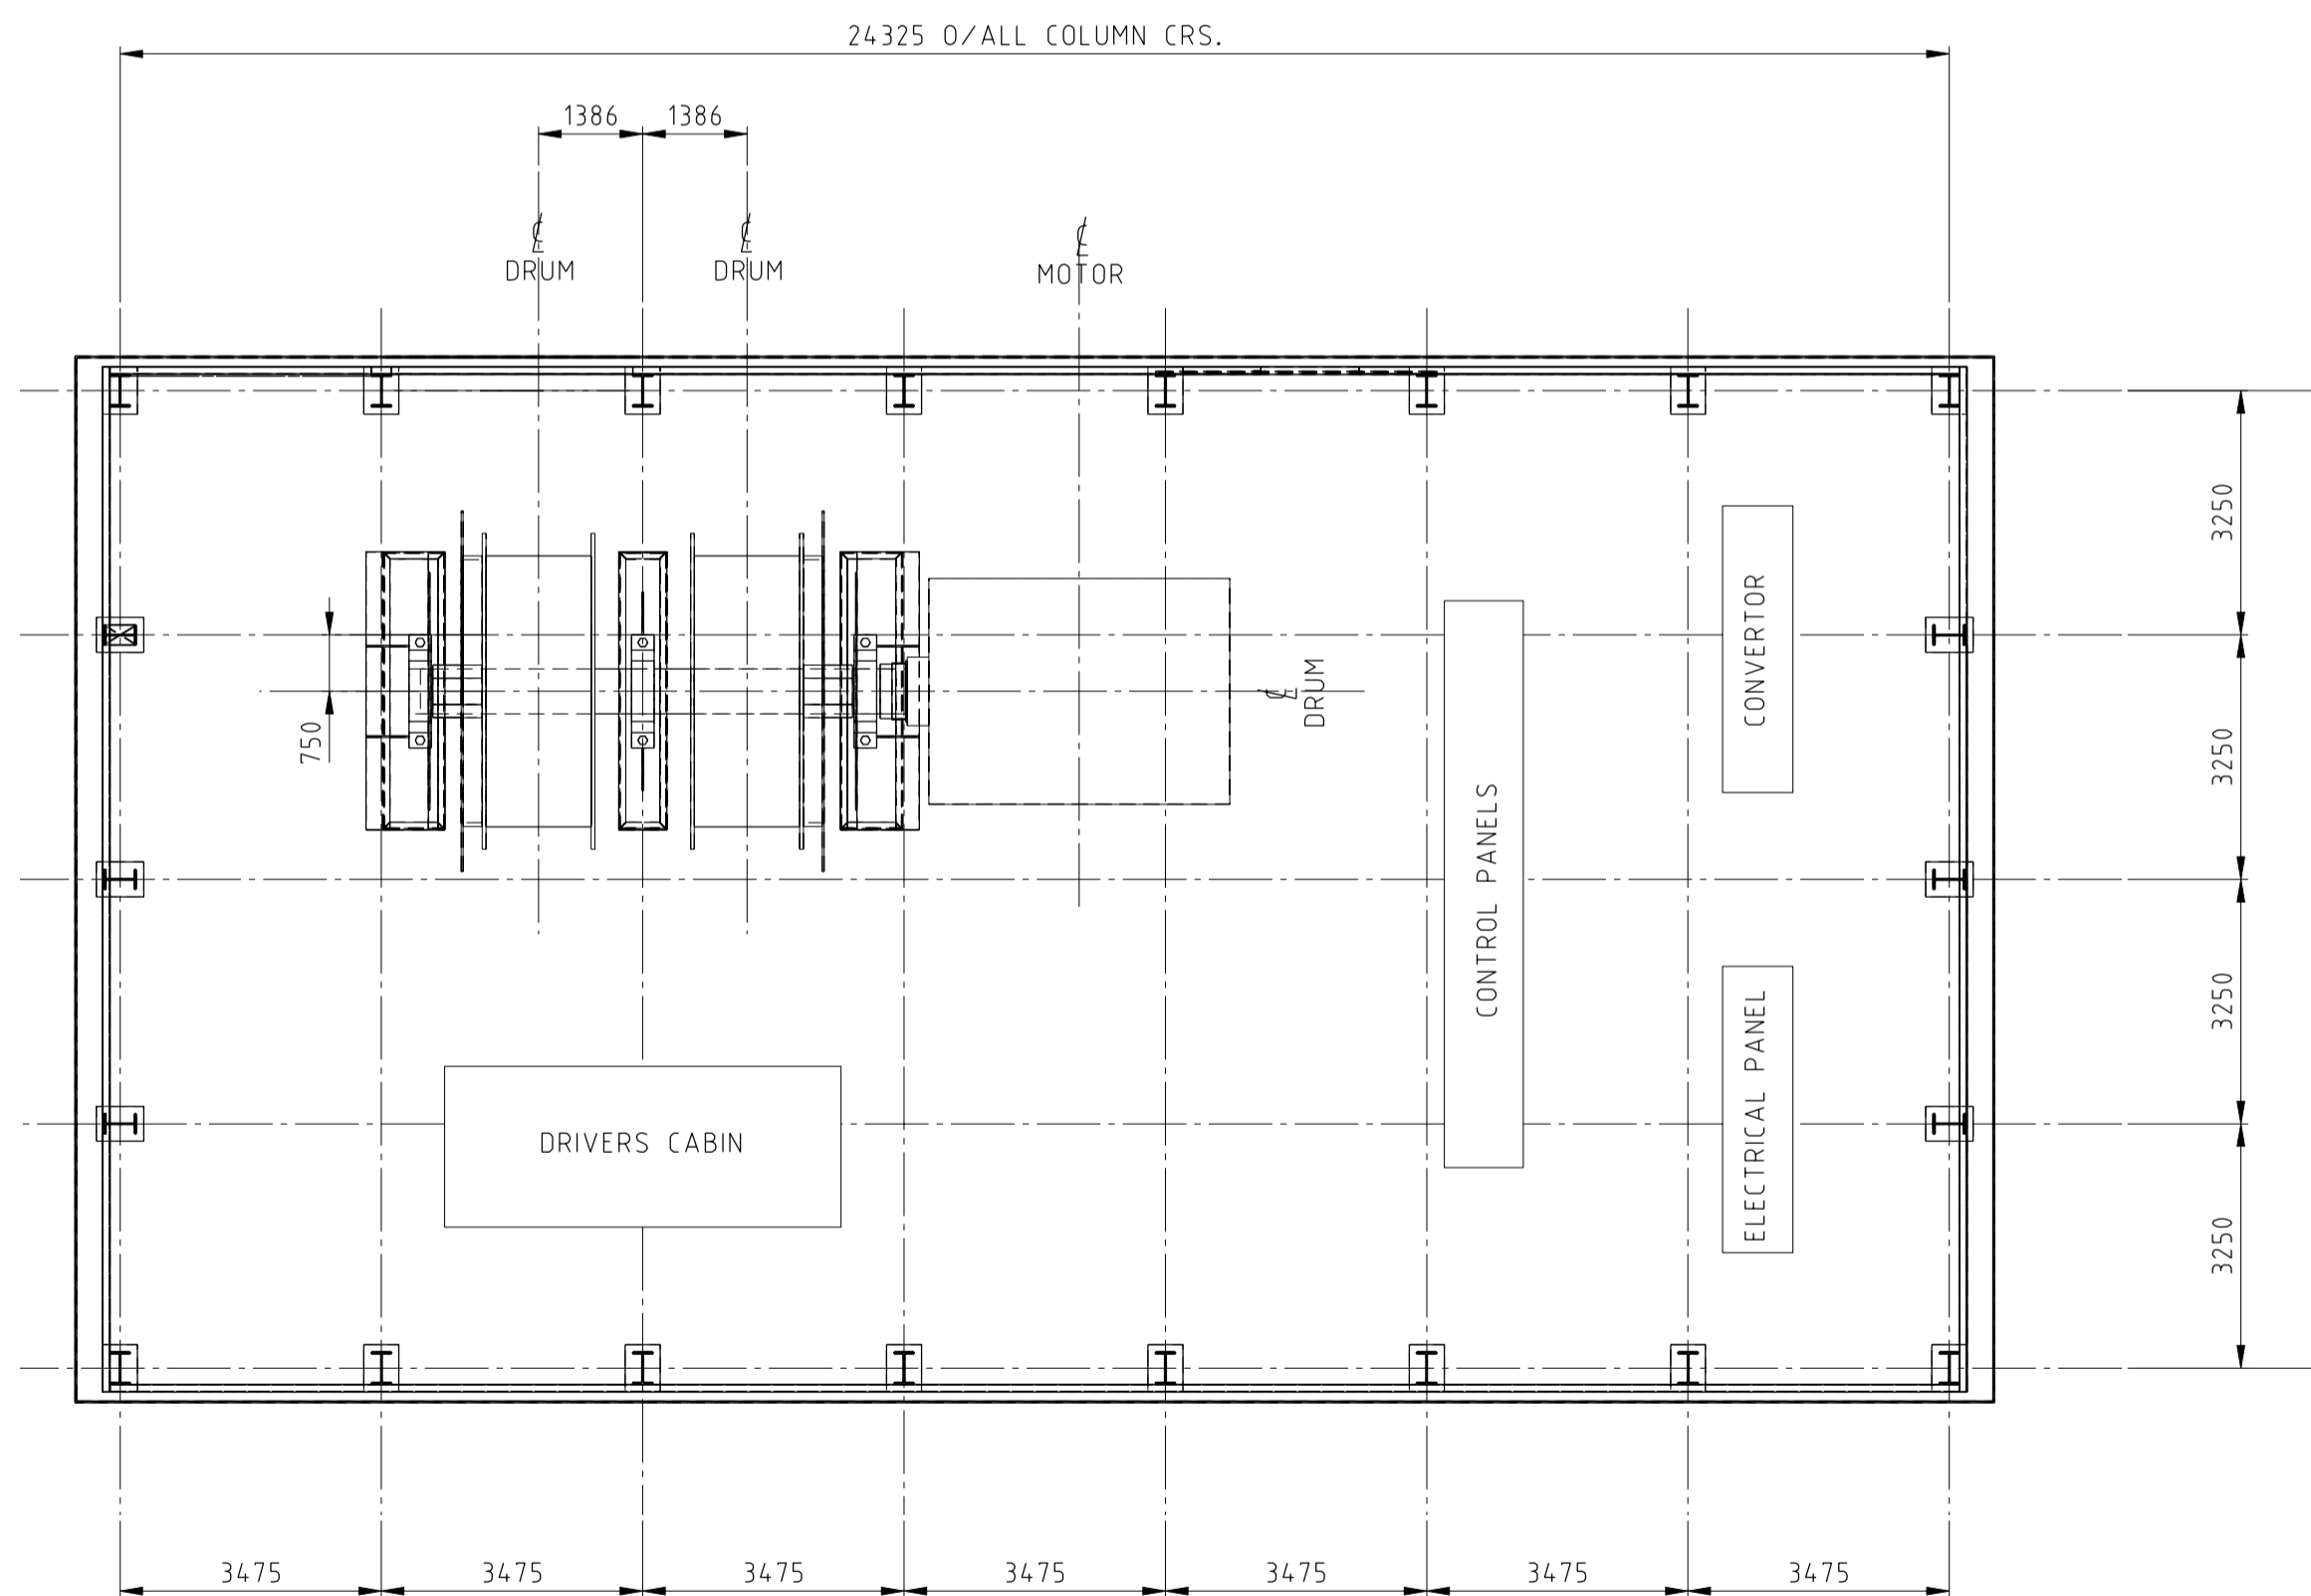

PLAN ON B-B
SCALE 1:100

DRAWING NO.	DRAWING TITLE
1	REFERENCE DRAWINGS

NO.	DESCRIPTION	CHK'D	APP'D	DATE
REVISIONS				

NOT FOR CONSTRUCTION
This drawing has been reviewed for the purposes of DGR Preliminary Engineering only and must not be used for other purposes.
Work Package Owner:
Stephen Keen
Area Lead:
G.R. Davidge
Engineering Manager:
Shelwin Adams
Project Manager:
Accepted by Owner:


REV.	ISSUE FOR	SAA	GRD	DATE
00	APPROVED FOR USE			09/12/10

ISSUE AUTHORIZATION


HATCH
DESIGNED BY: S Lo DRAGO
DATE: 11/11/09
CHECKED BY:
DATE: PROJ. DES. COORD.
DRAWN BY: JP DANIELS
DATE: 11/11/09
DISCIPLINE: ENGR.
DATE: PROJ. ENGR.
DATE:

NUCLEAR WASTE MANAGEMENT ORGANIZATION
DEEP GEOLOGIC REPOSITORY PROJECT
SHAFT HOISTING SYSTEM
MAIN SHAFT
HOIST HOUSE - SINKING CONDITION
LAYOUT
SCALE: 1:100 OR AS NOTED
DWG. NO.: H333000-WP405-20-042-0010
REV. 00


A
B
C
D
E

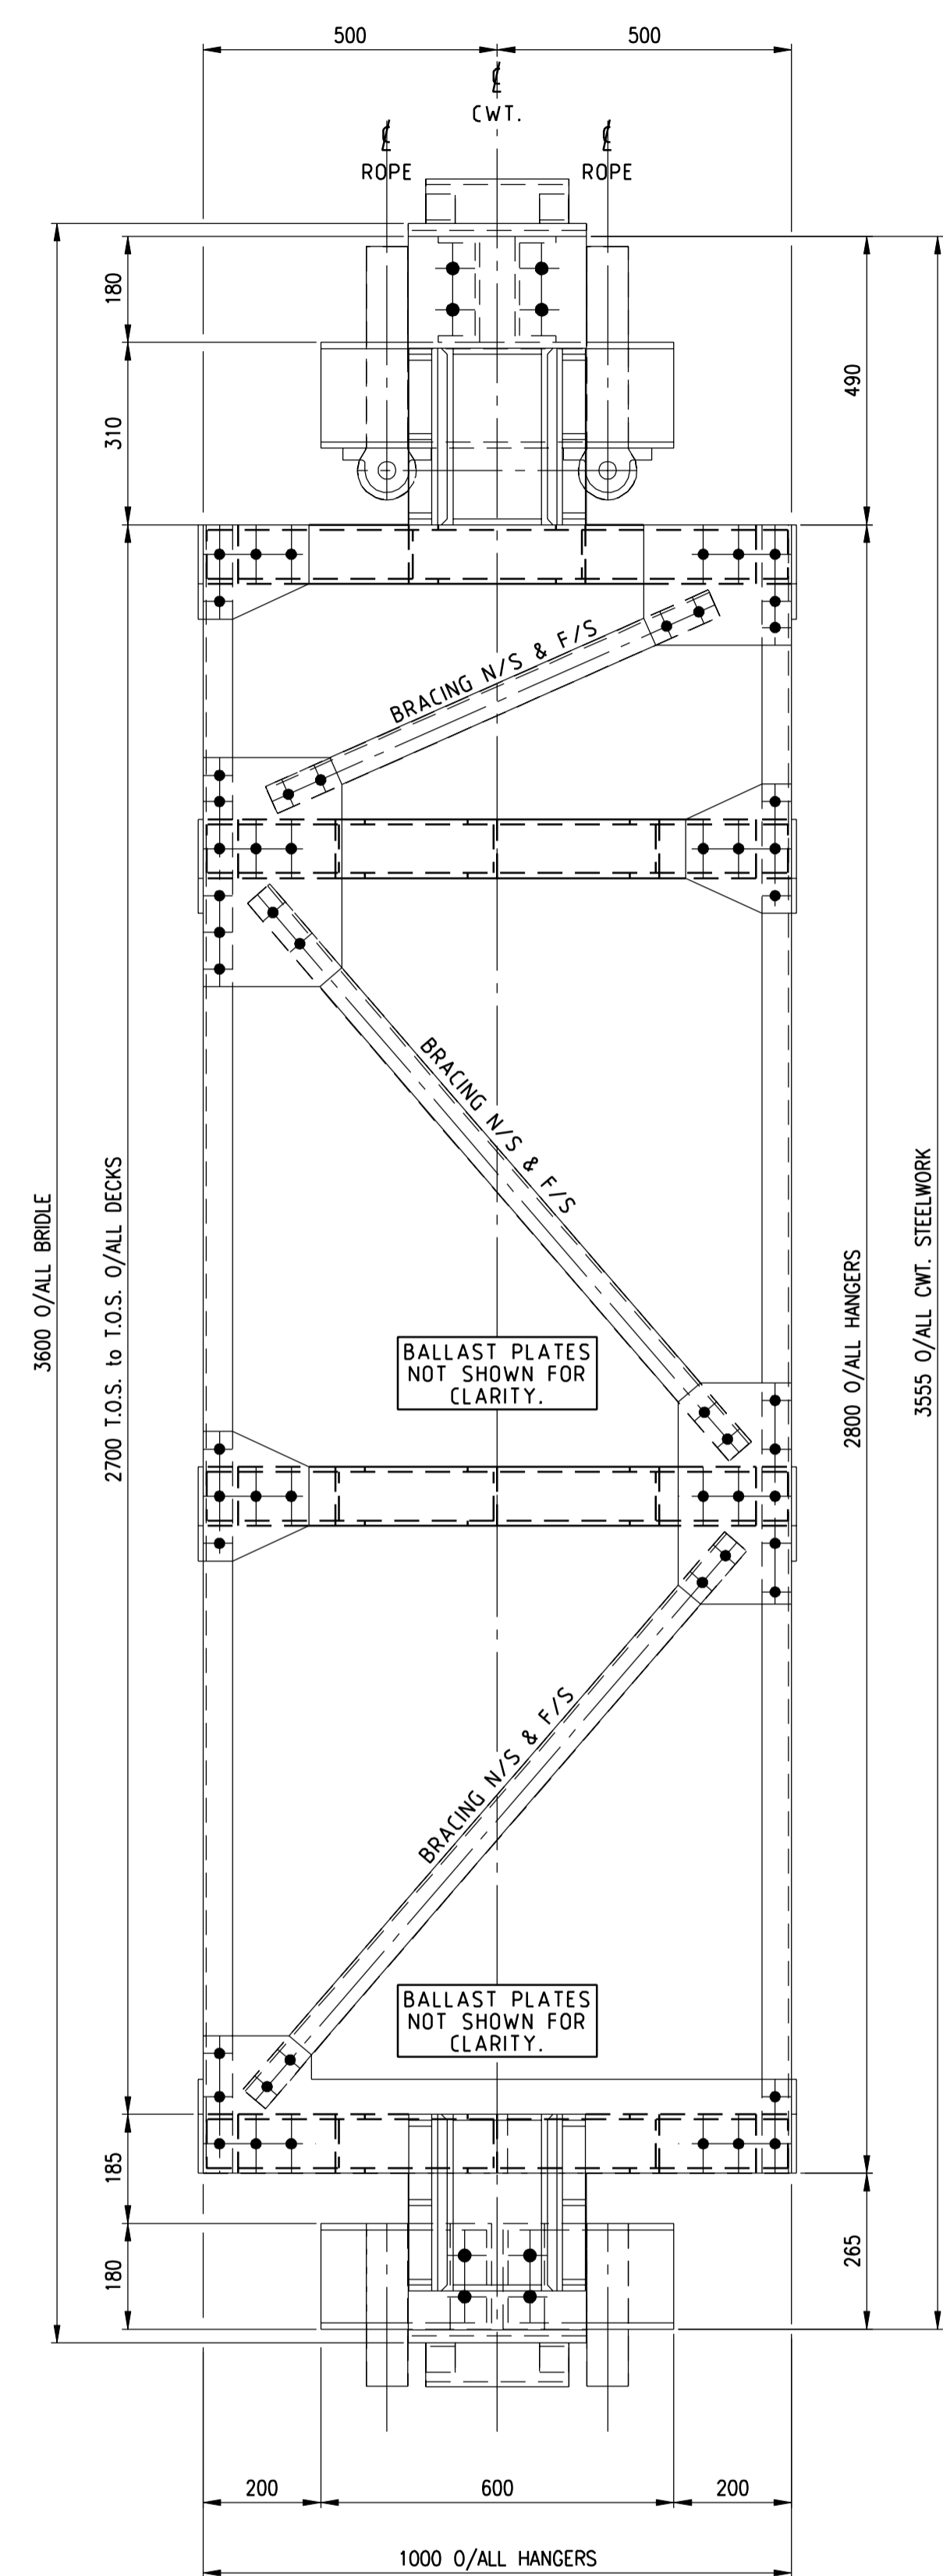


SIDE ELEVATION
SCALE 1:10

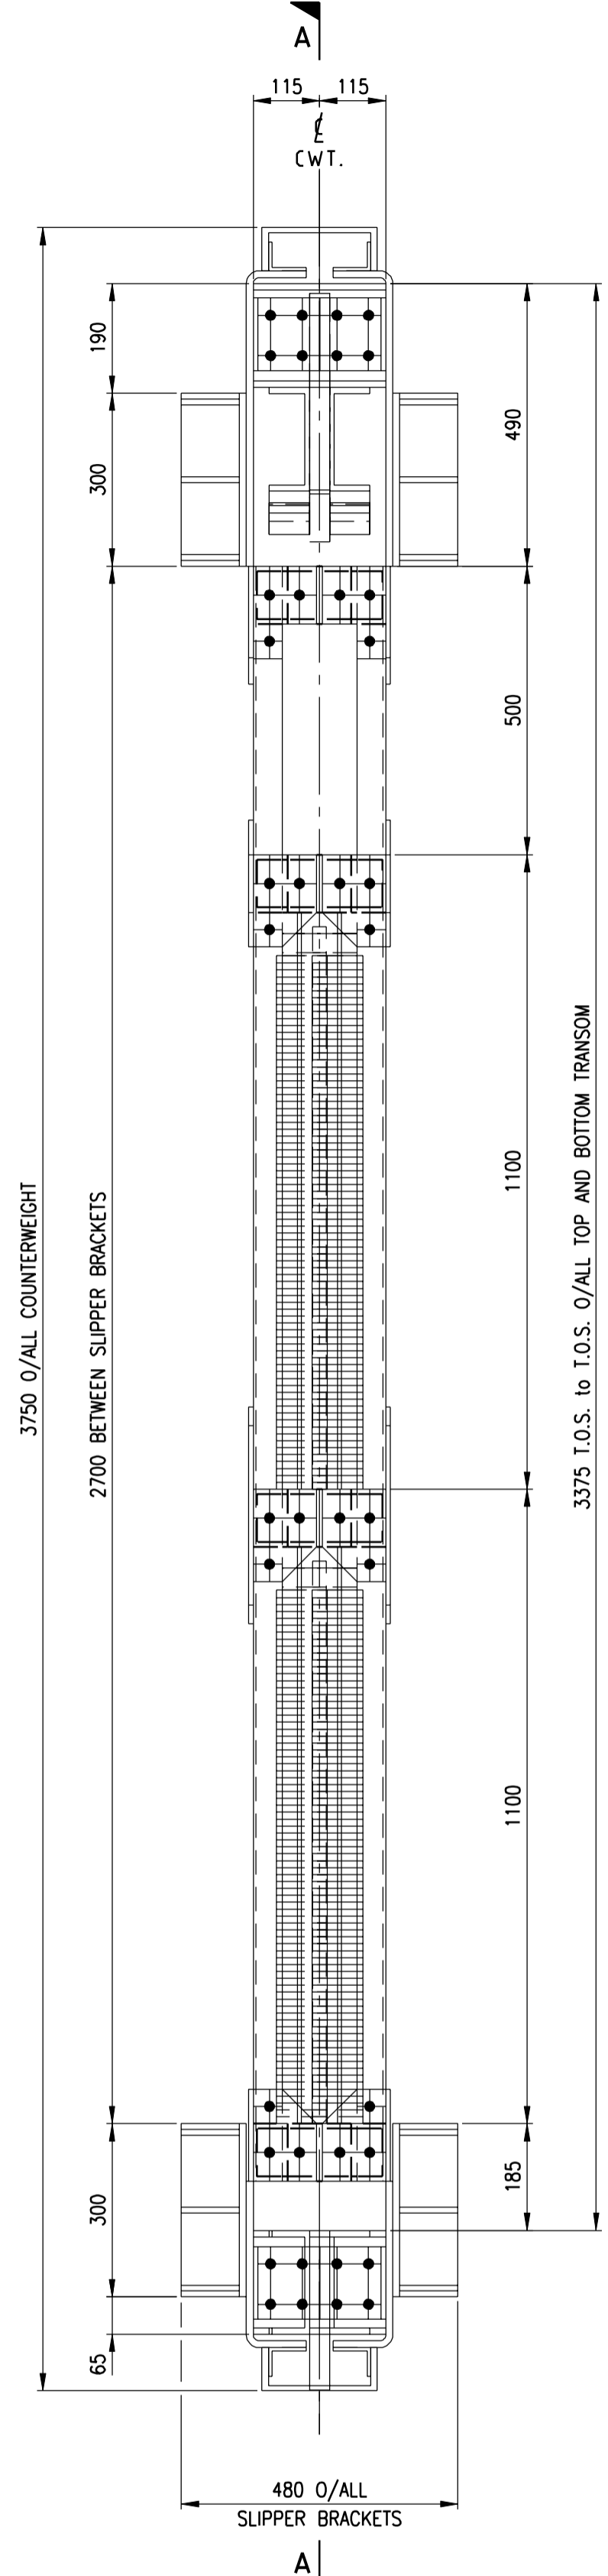


ELEVATION ON COUNTERWEIGHT
SCALE 1:10

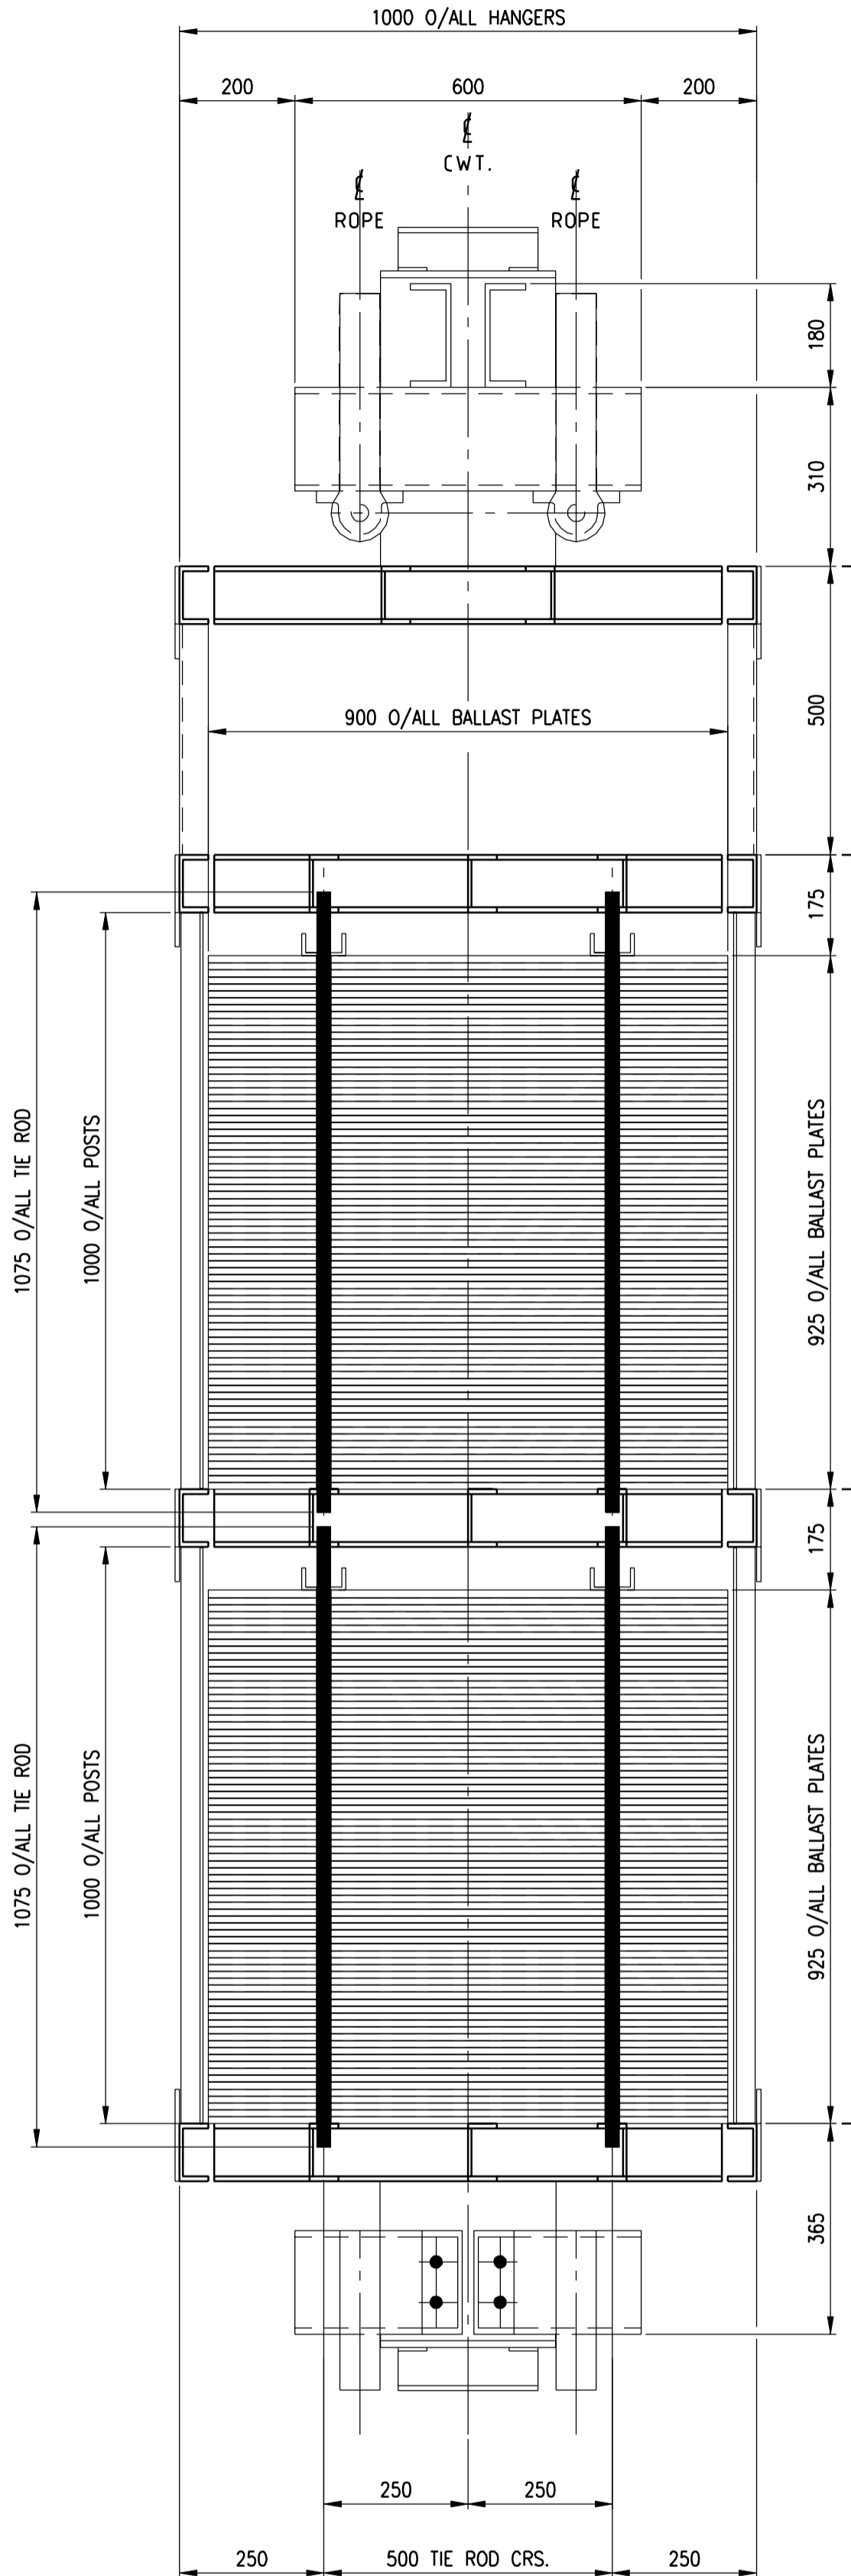


SECTION A-A
SCALE 1:10

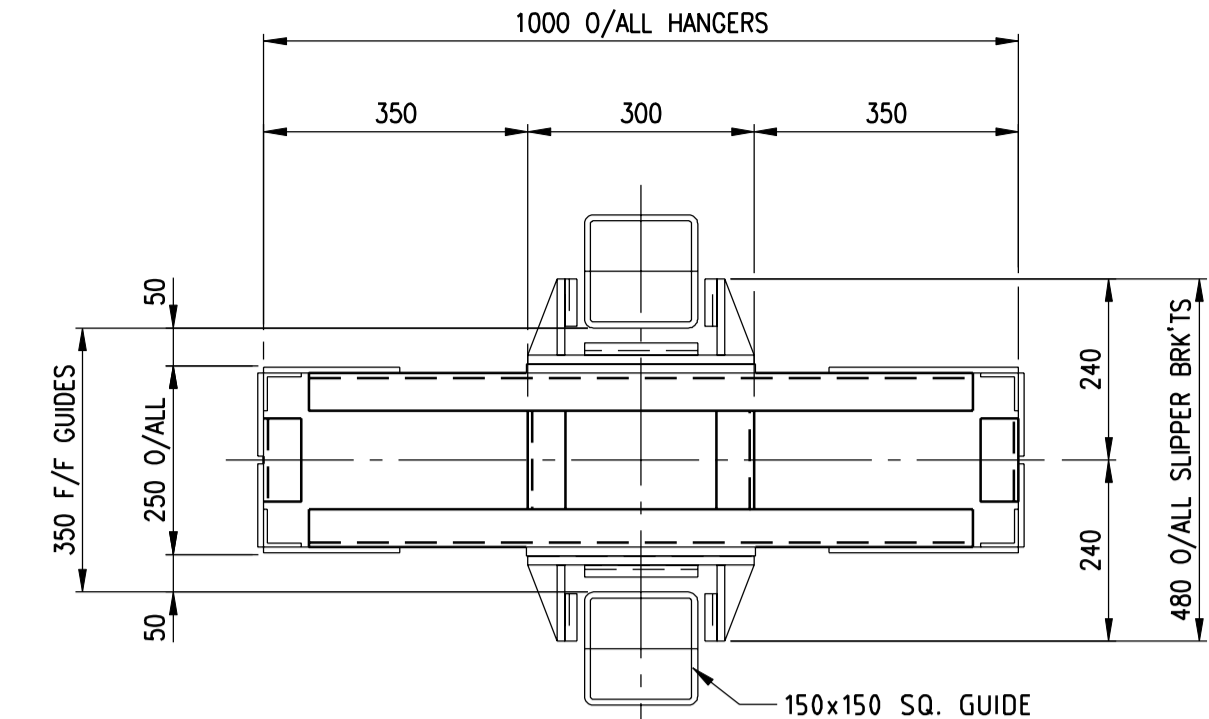

PLAN ON ROOF DECK
SCALE 1:10

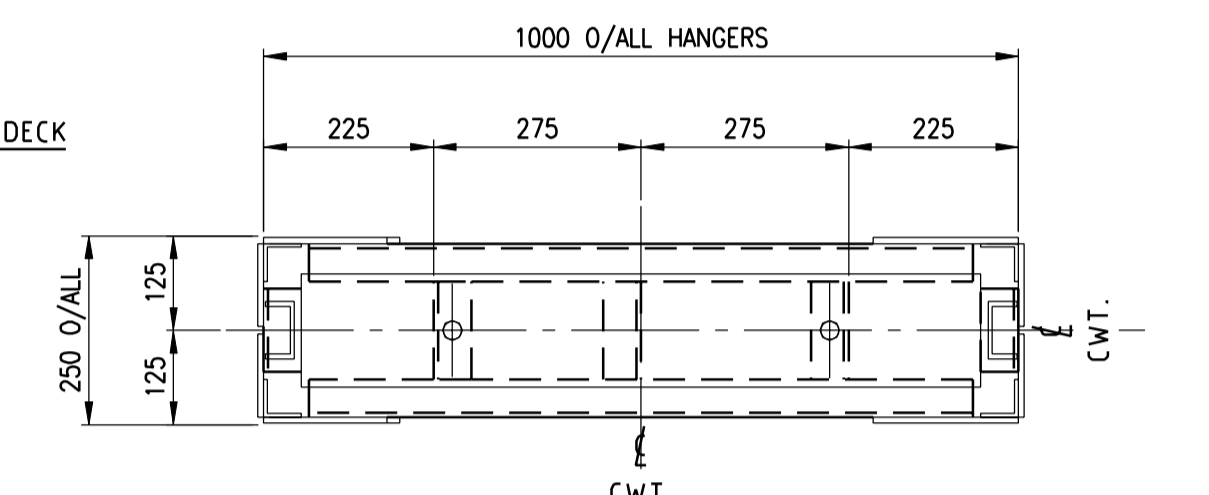

PLAN ON INTERMEDIATE DECKS
SCALE 1:10

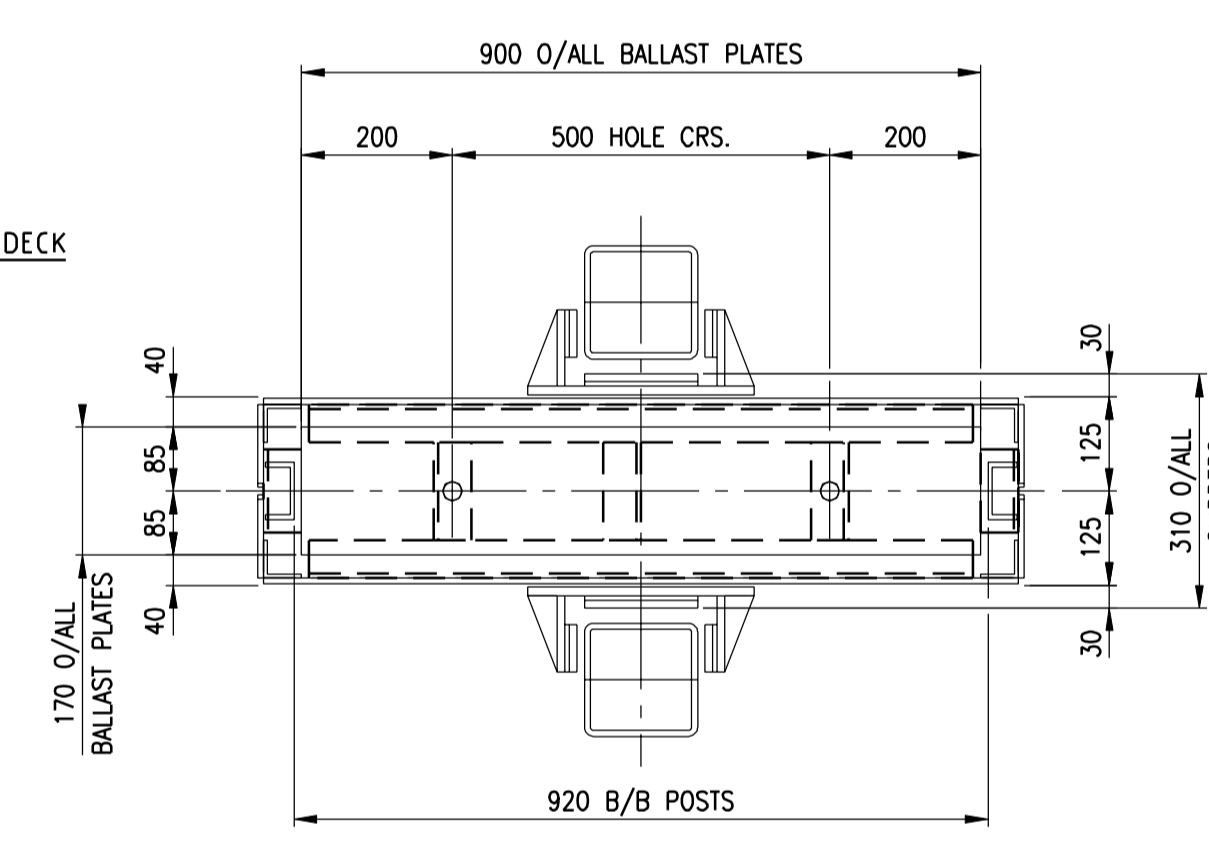


PLAN ON BOTTOM DECK
SCALE 1:10


PRELIMINARY

BALLAST PLATES -
154 PLATES - 77 PLATES PER DECK
14.4kg PER PLATE

ITEM No.	DESCRIPTION	ESTIMATED MASS
1.	BALLAST PLATES	2 200 Kg. SPLIT BETWEEN 2 - DECKS
2.	PRIMARY STEEL MEMBERS	320 Kg.
3.	ROPE ATTACHMENTS	250 Kg.
4.	ALLOWANCE FOR SUNDRIES	30 Kg.
5.	TOTAL ESTIMATED MAXIMUM MASS	2 800 Kg.

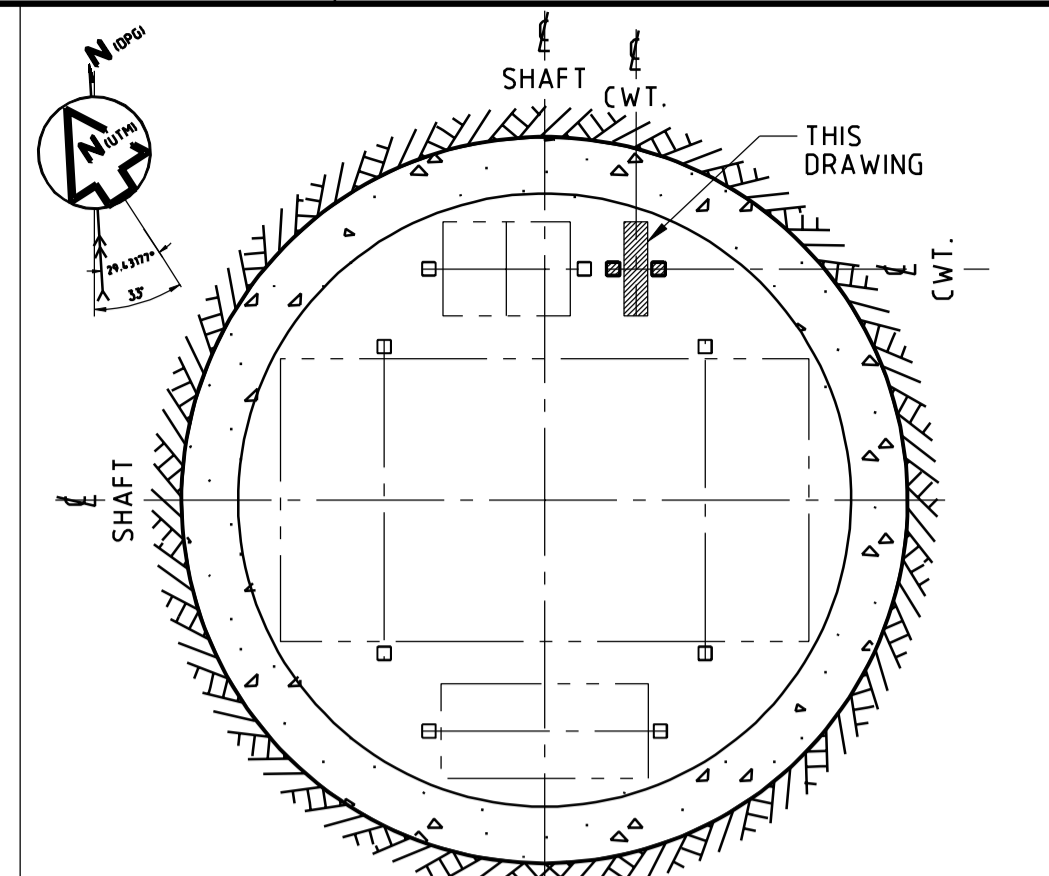

KEY PLAN

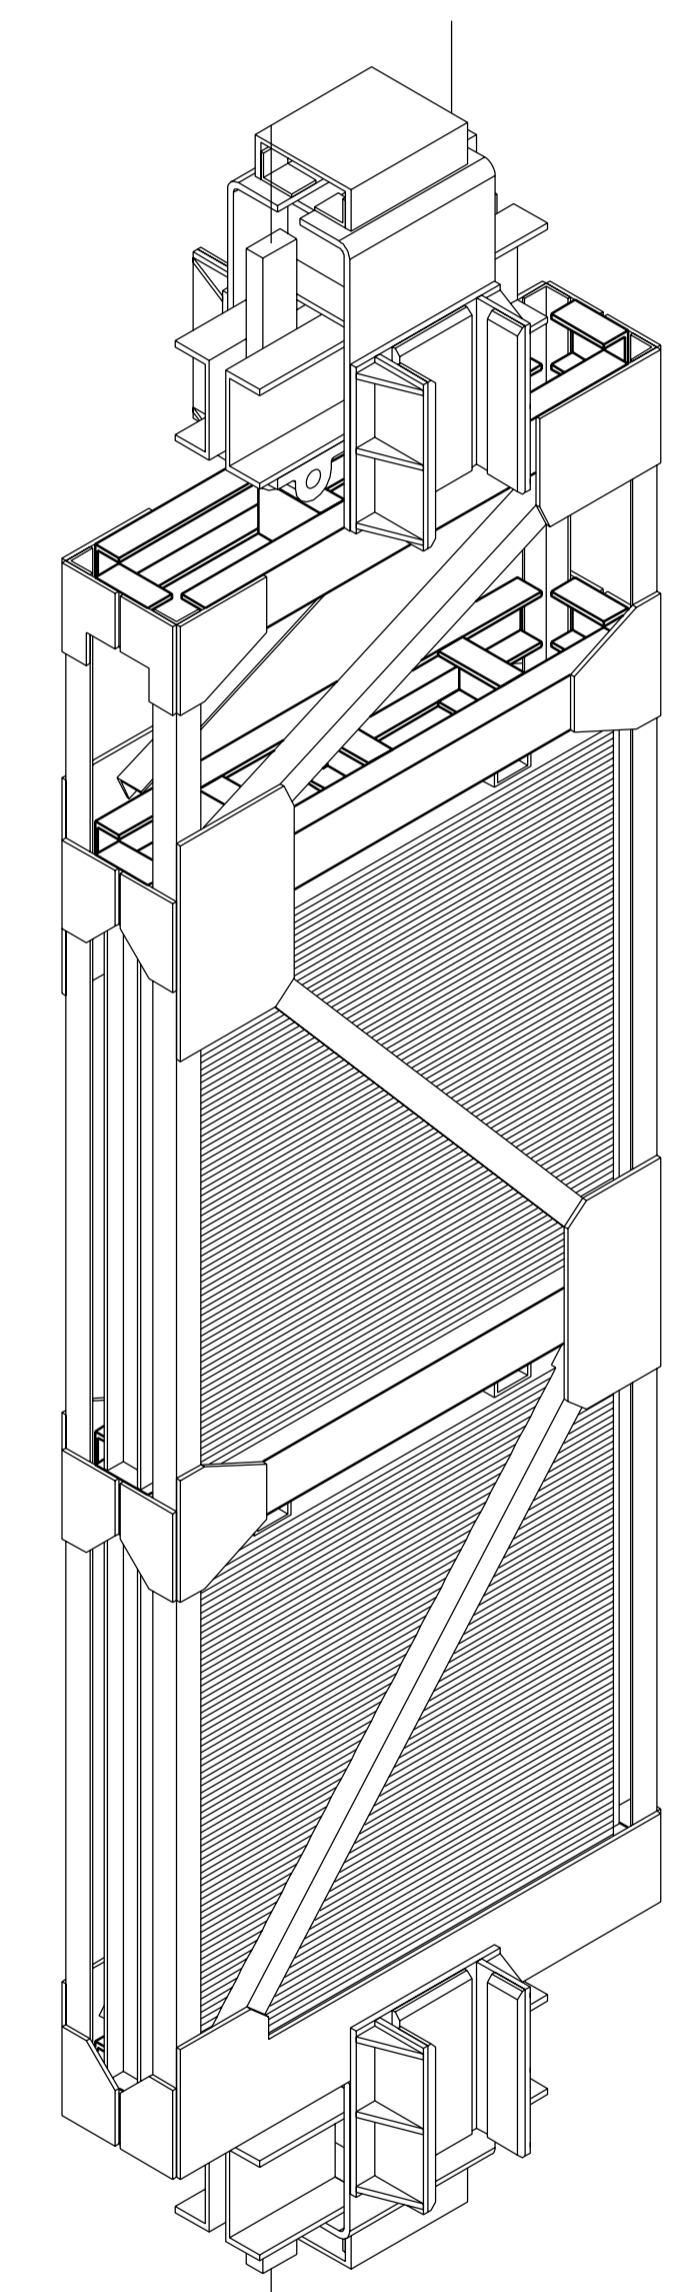

ISOMETRIC VIEW - COUNTERWEIGHT

- GENERAL NOTES:-**
1. ALL STRUCTURAL STEELWORK TO BE IN ACCORDANCE WITH CAN/CSA-S16-01.
 2. ALL STRUCTURAL STEEL TO BE 350WA UNLESS OTHERWISE NOTED.
 3. THIS DRAWING TO BE USED FOR PRELIMINARY DESIGN ONLY, NOT TO BE USED FOR CONSTRUCTION.

NOT FOR CONSTRUCTION
 This drawing has been reviewed for the purposes of DGR Preliminary Engineering only and must not be used for other purposes.
 Work Package Owner
Stephen Keen
 Area Lead
G.R. Davidge
 Engineering Manager
 Sherwin Aarons
 Project Manager
 Accepted by Owner





HATCH
 DESIGNED BY
 CHECKED BY
 DATE
 PROJECT MANAGER
 DATE

**NUCLEAR WASTE MANAGEMENT ORGANIZATION
 DEEP GEOLOGIC REPOSITORY PROJECT**
SHAFT HOISTING SYSTEMS
**MAIN SHAFT - PERMANENT CONDITION
 AUXILIARY - COUNTERWEIGHT
 GENERAL ARRANGEMENT**
 SCALE 1:10
 DWG. NO. H333000-WP405-35-042-0001

DRAWING NO.	DRAWING TITLE

NO.	DESCRIPTION	CHK'D	APP'D	DATE

REV.	ISSUE FOR	SA	GRD	DATE
00	APPROVED FOR USE			09/12/10

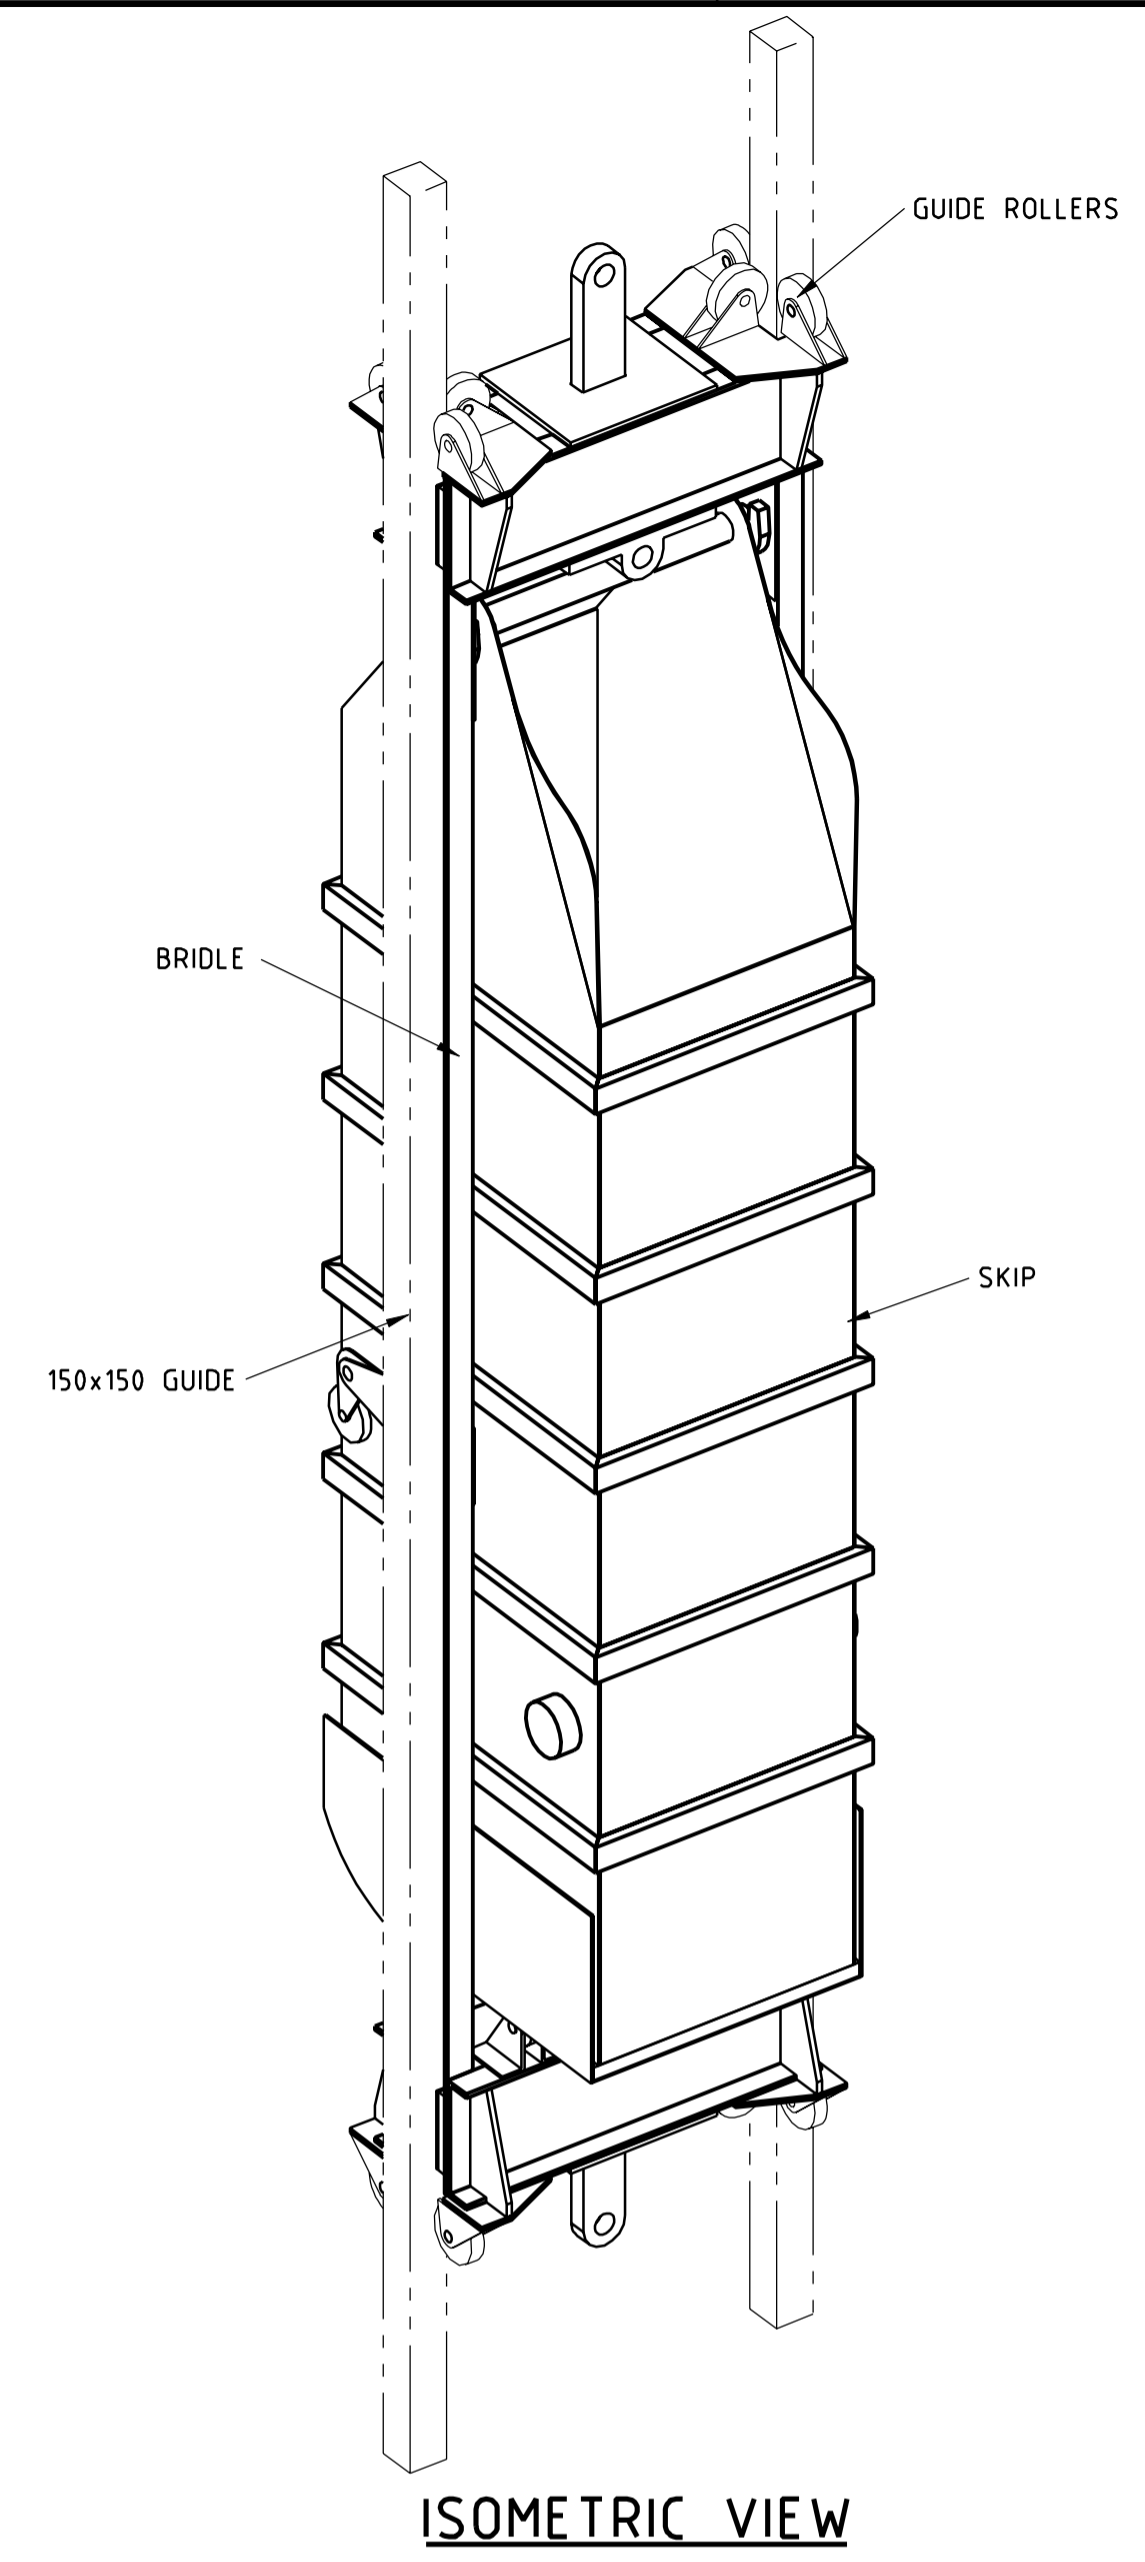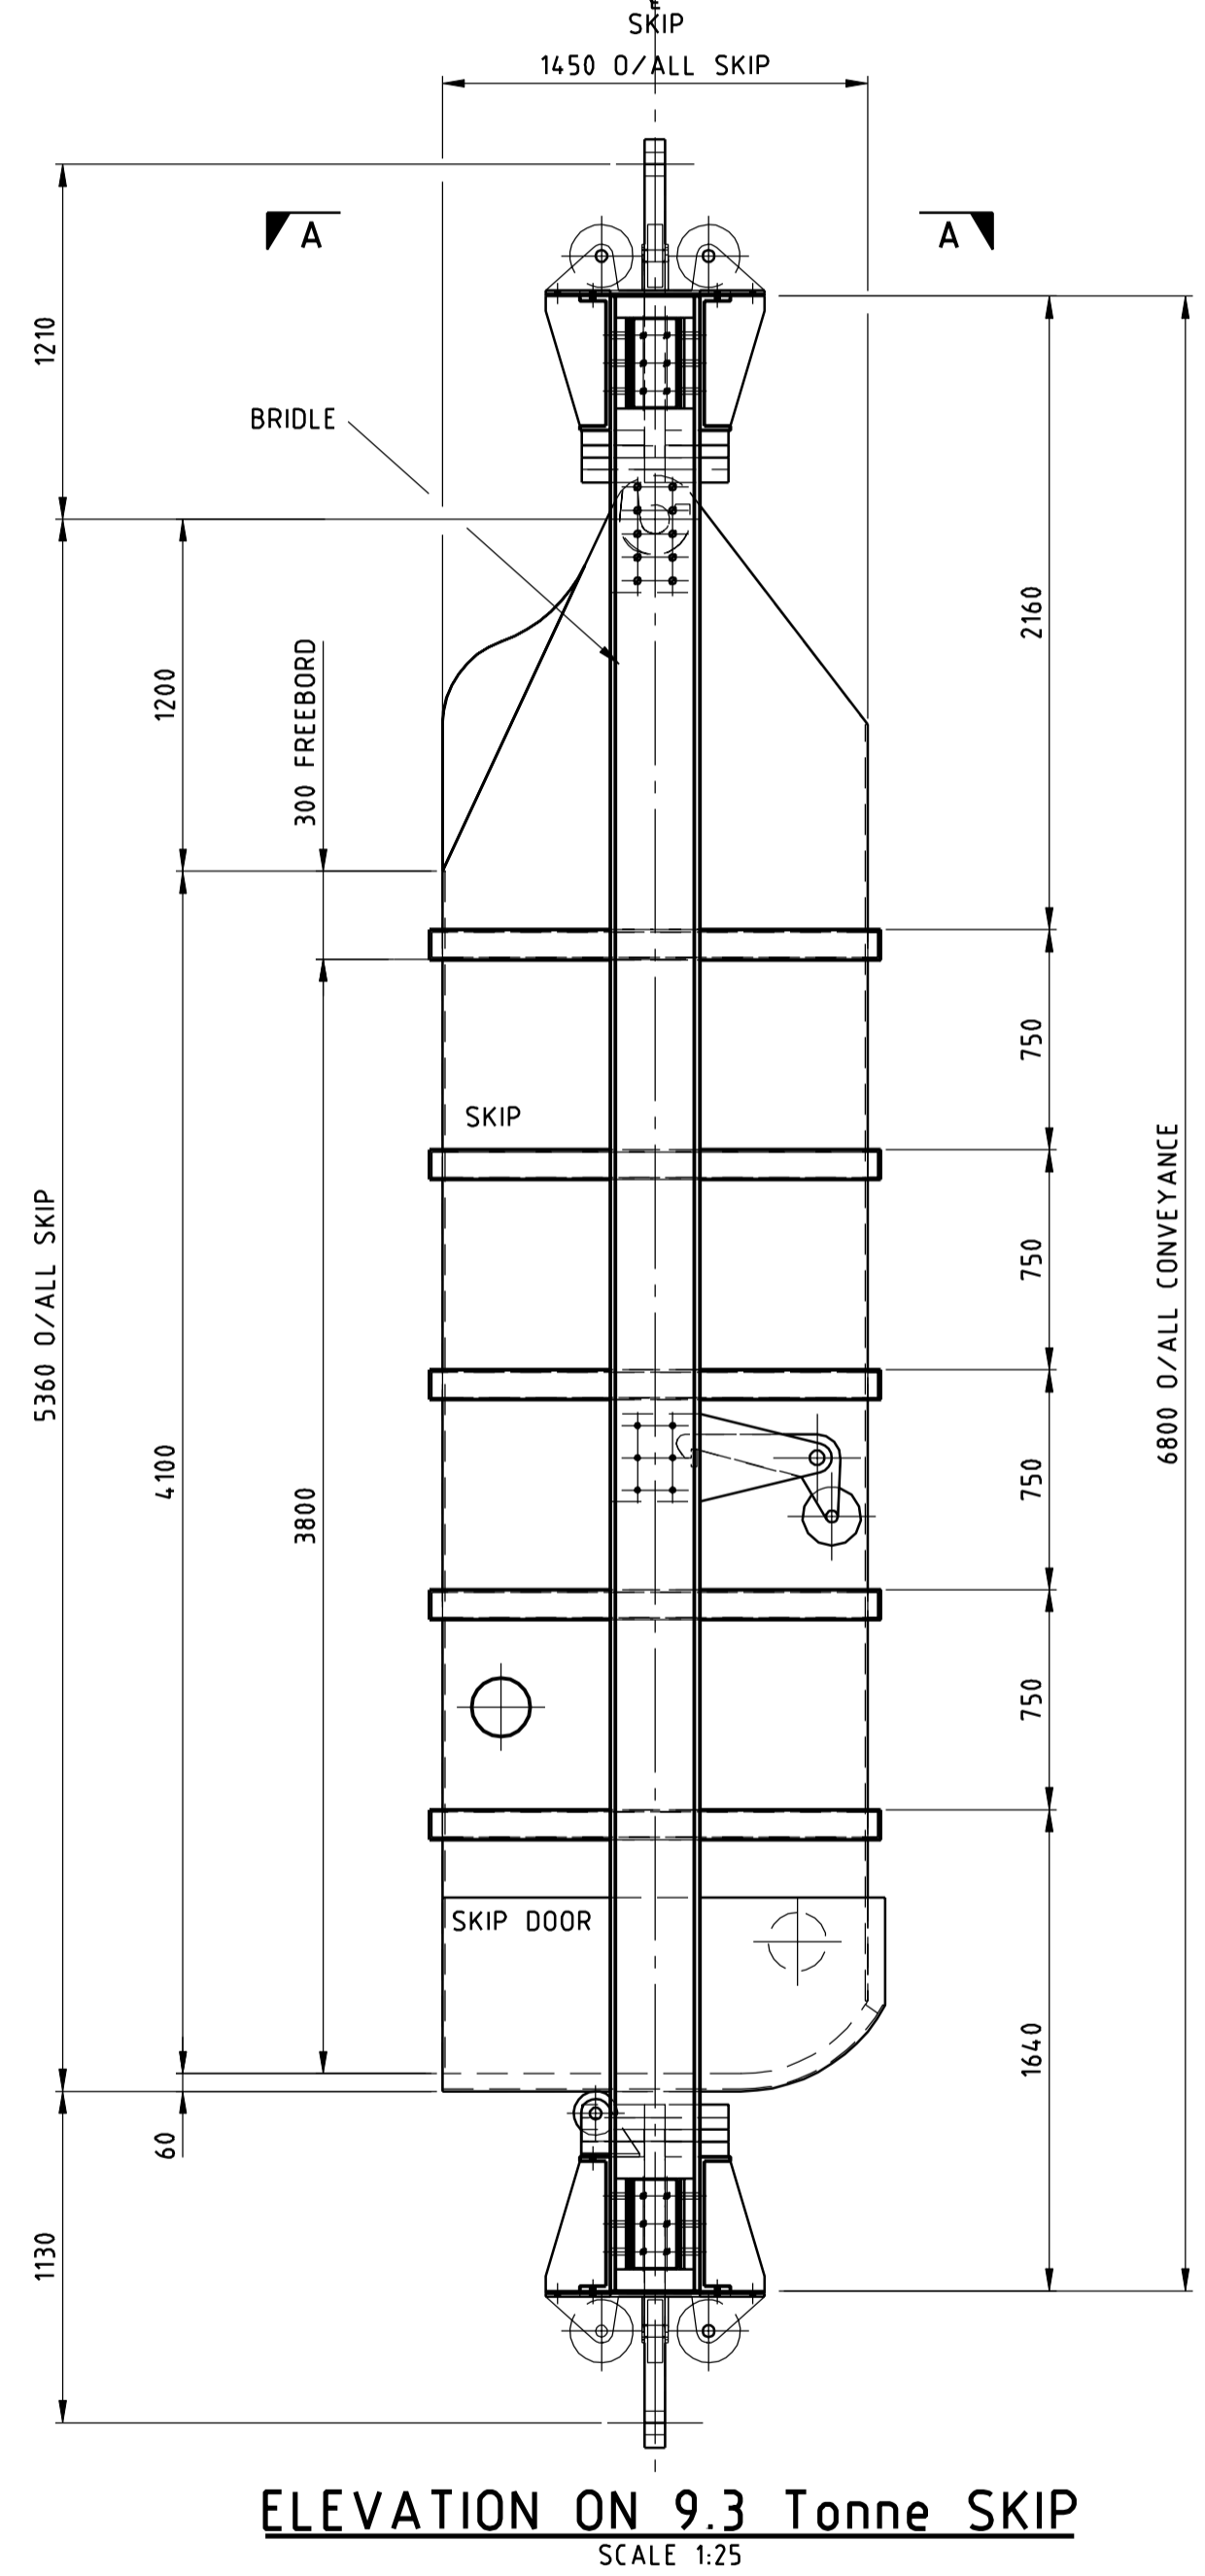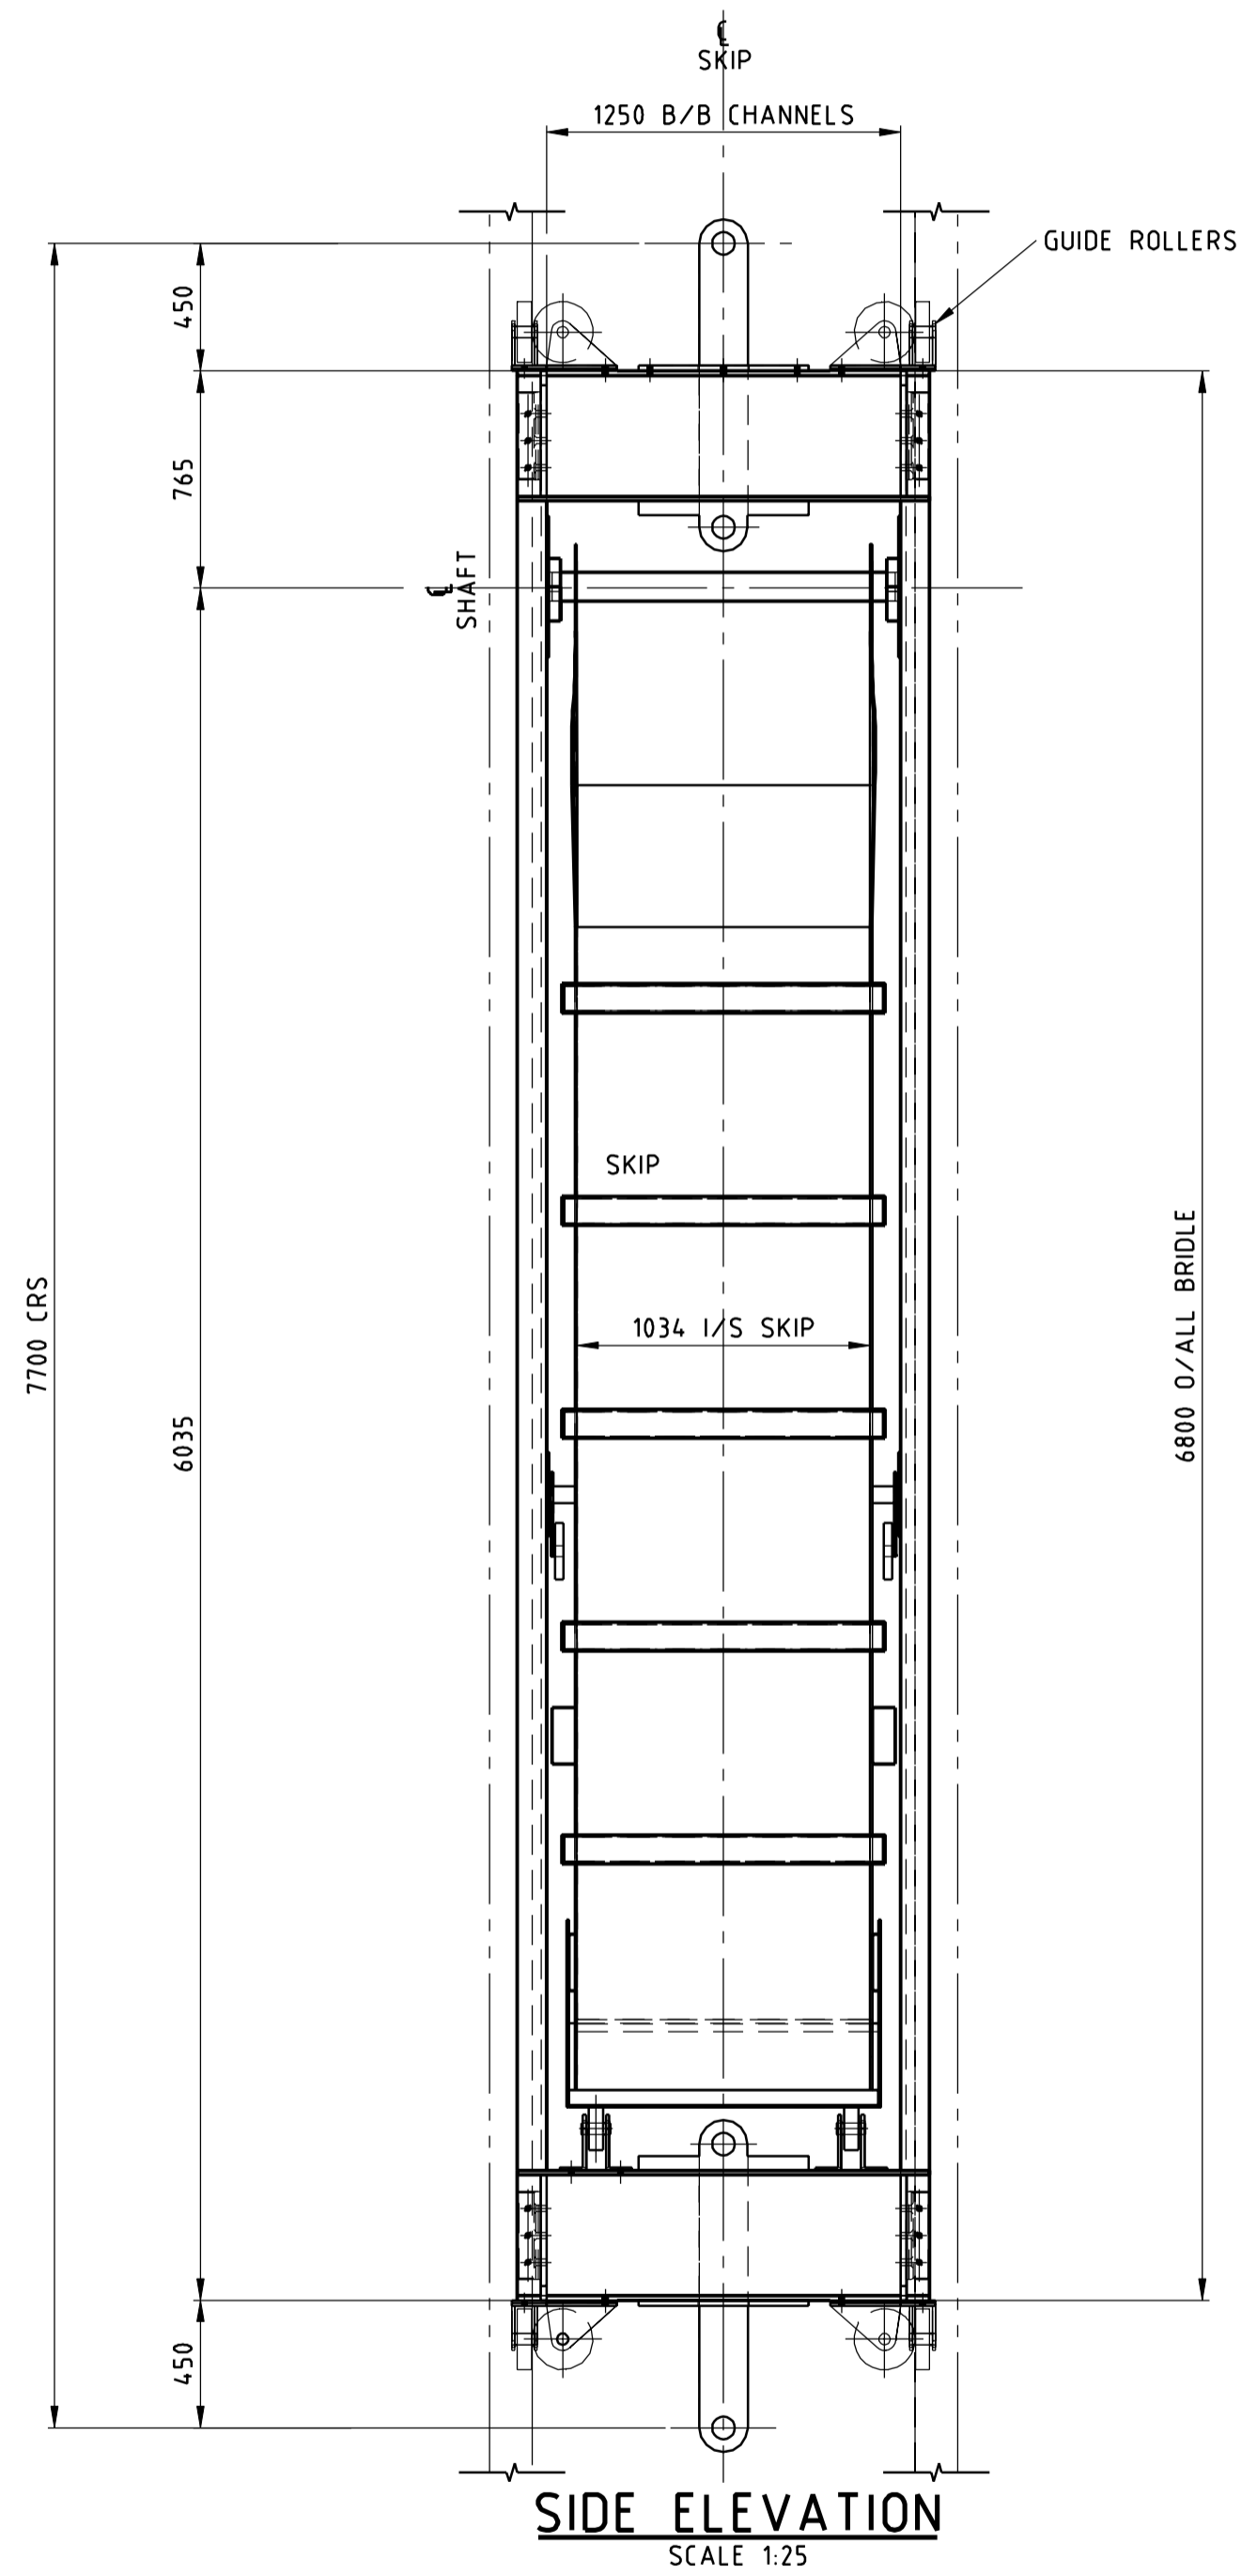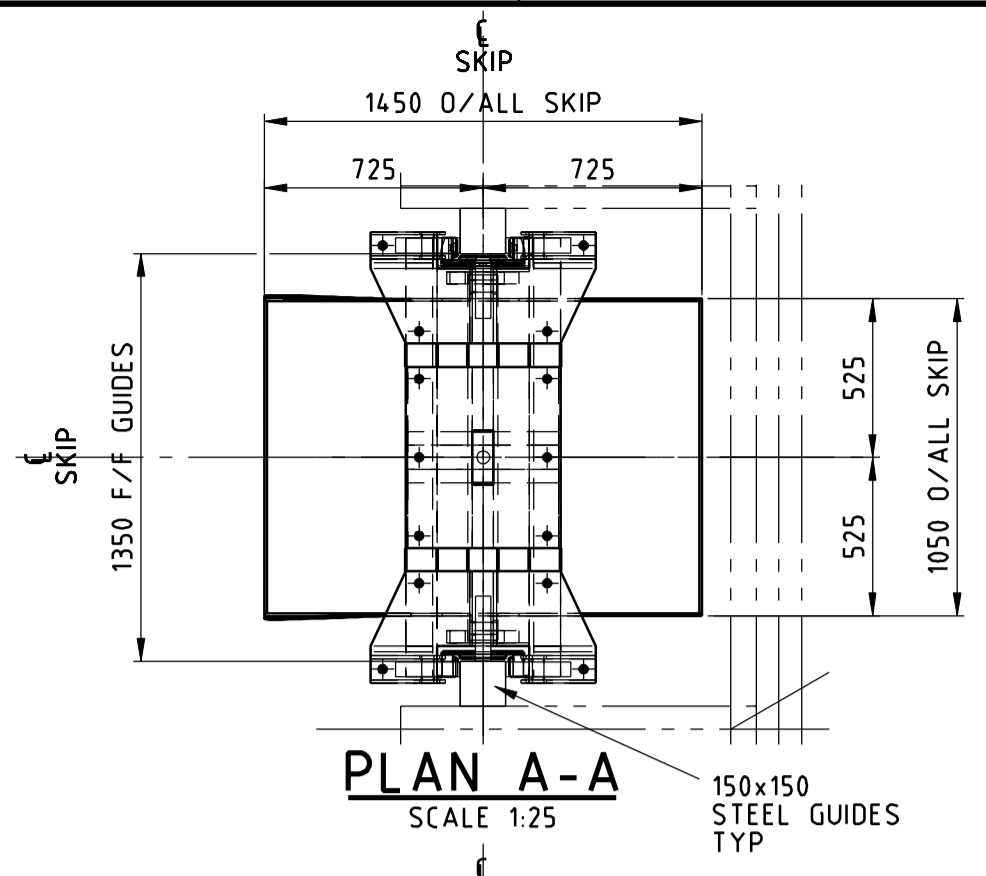

ITEMS	ESTIMATED MASS
1. MAXIMUM SKIP PAYLOAD	9 300 KG
2. PRIMARY STEEL MEMBERS	1 550 KG
3. ROPE ATTACHMENTS	230 KG
4. ALLOWANCE FOR SUNDRIES	491 KG
5. SKIP	4650 KG
TOTAL ESTIMATED MAXIMUM MASS	16 221 KG

GENERAL NOTE:-
 1. ALL STRUCTURAL STEELWORK TO BE IN ACCORDANCE WITH CAN/CSA-S16-01.
 2. ALL STRUCTURAL STEEL TO BE CSA G40.21 350WT UNLESS OTHERWISE NOTED.
 3. DRAWING TO BE USED FOR PRELIMINARY DESIGN ONLY, NOT TO BE USED FOR CONSTRUCTION.
 4. SIZE OF CONVEYANCE BASED ON SHAFT SIZE FROM CONCEPTUAL DESIGN REPORT.
 5. ROLLOMATIC BOTTOM DISCHARGE TYPE SKIP ASSUMED.
 6. A 2 Tonne ALLOWANCE HAS BEEN MADE FOR EITHER SLINGING OF AN INSPECTION PLATFORM UNDER THE SKIP OR PLACING AN INSPECTION PLATFORM ON TOP OF THE SKIP

PRELIMINARY

DRAWING NO.	DRAWING TITLE

NO.	DESCRIPTION	CHK'D	APP'D	DATE

REV.	ISSUE FOR	AUTH. BY	DATE
00	APPROVED FOR USE	GRD SAA	03/12/09

DESIGNED BY	DRAWN BY
DATE	M.C. BOTHMA
CHECKED BY	DATE 14/10/09
S. KEEN	DISCIPL. ENGR.
DATE 14/10/09	DATE
PROJ. DES. COORD.	PROJ. ENGR.
DATE	DATE
PROJ. MGR.	
M. DAWBORN	
DATE 10/10/09	

HATCH

NUCLEAR WASTE MANAGEMENT ORGANIZATION
DEEP GEOLOGIC REPOSITORY PROJECT


SHAFT HOISTING SYSTEMS

VENTILATION SHAFT-PERMANENT CONDITION
9.3 Tonne SKIP
GENERAL ARRANGEMENT


SCALE: 1:25 OR AS NOTED

DWG. NO. H333000-WP405-20-042-0014


REV. 00

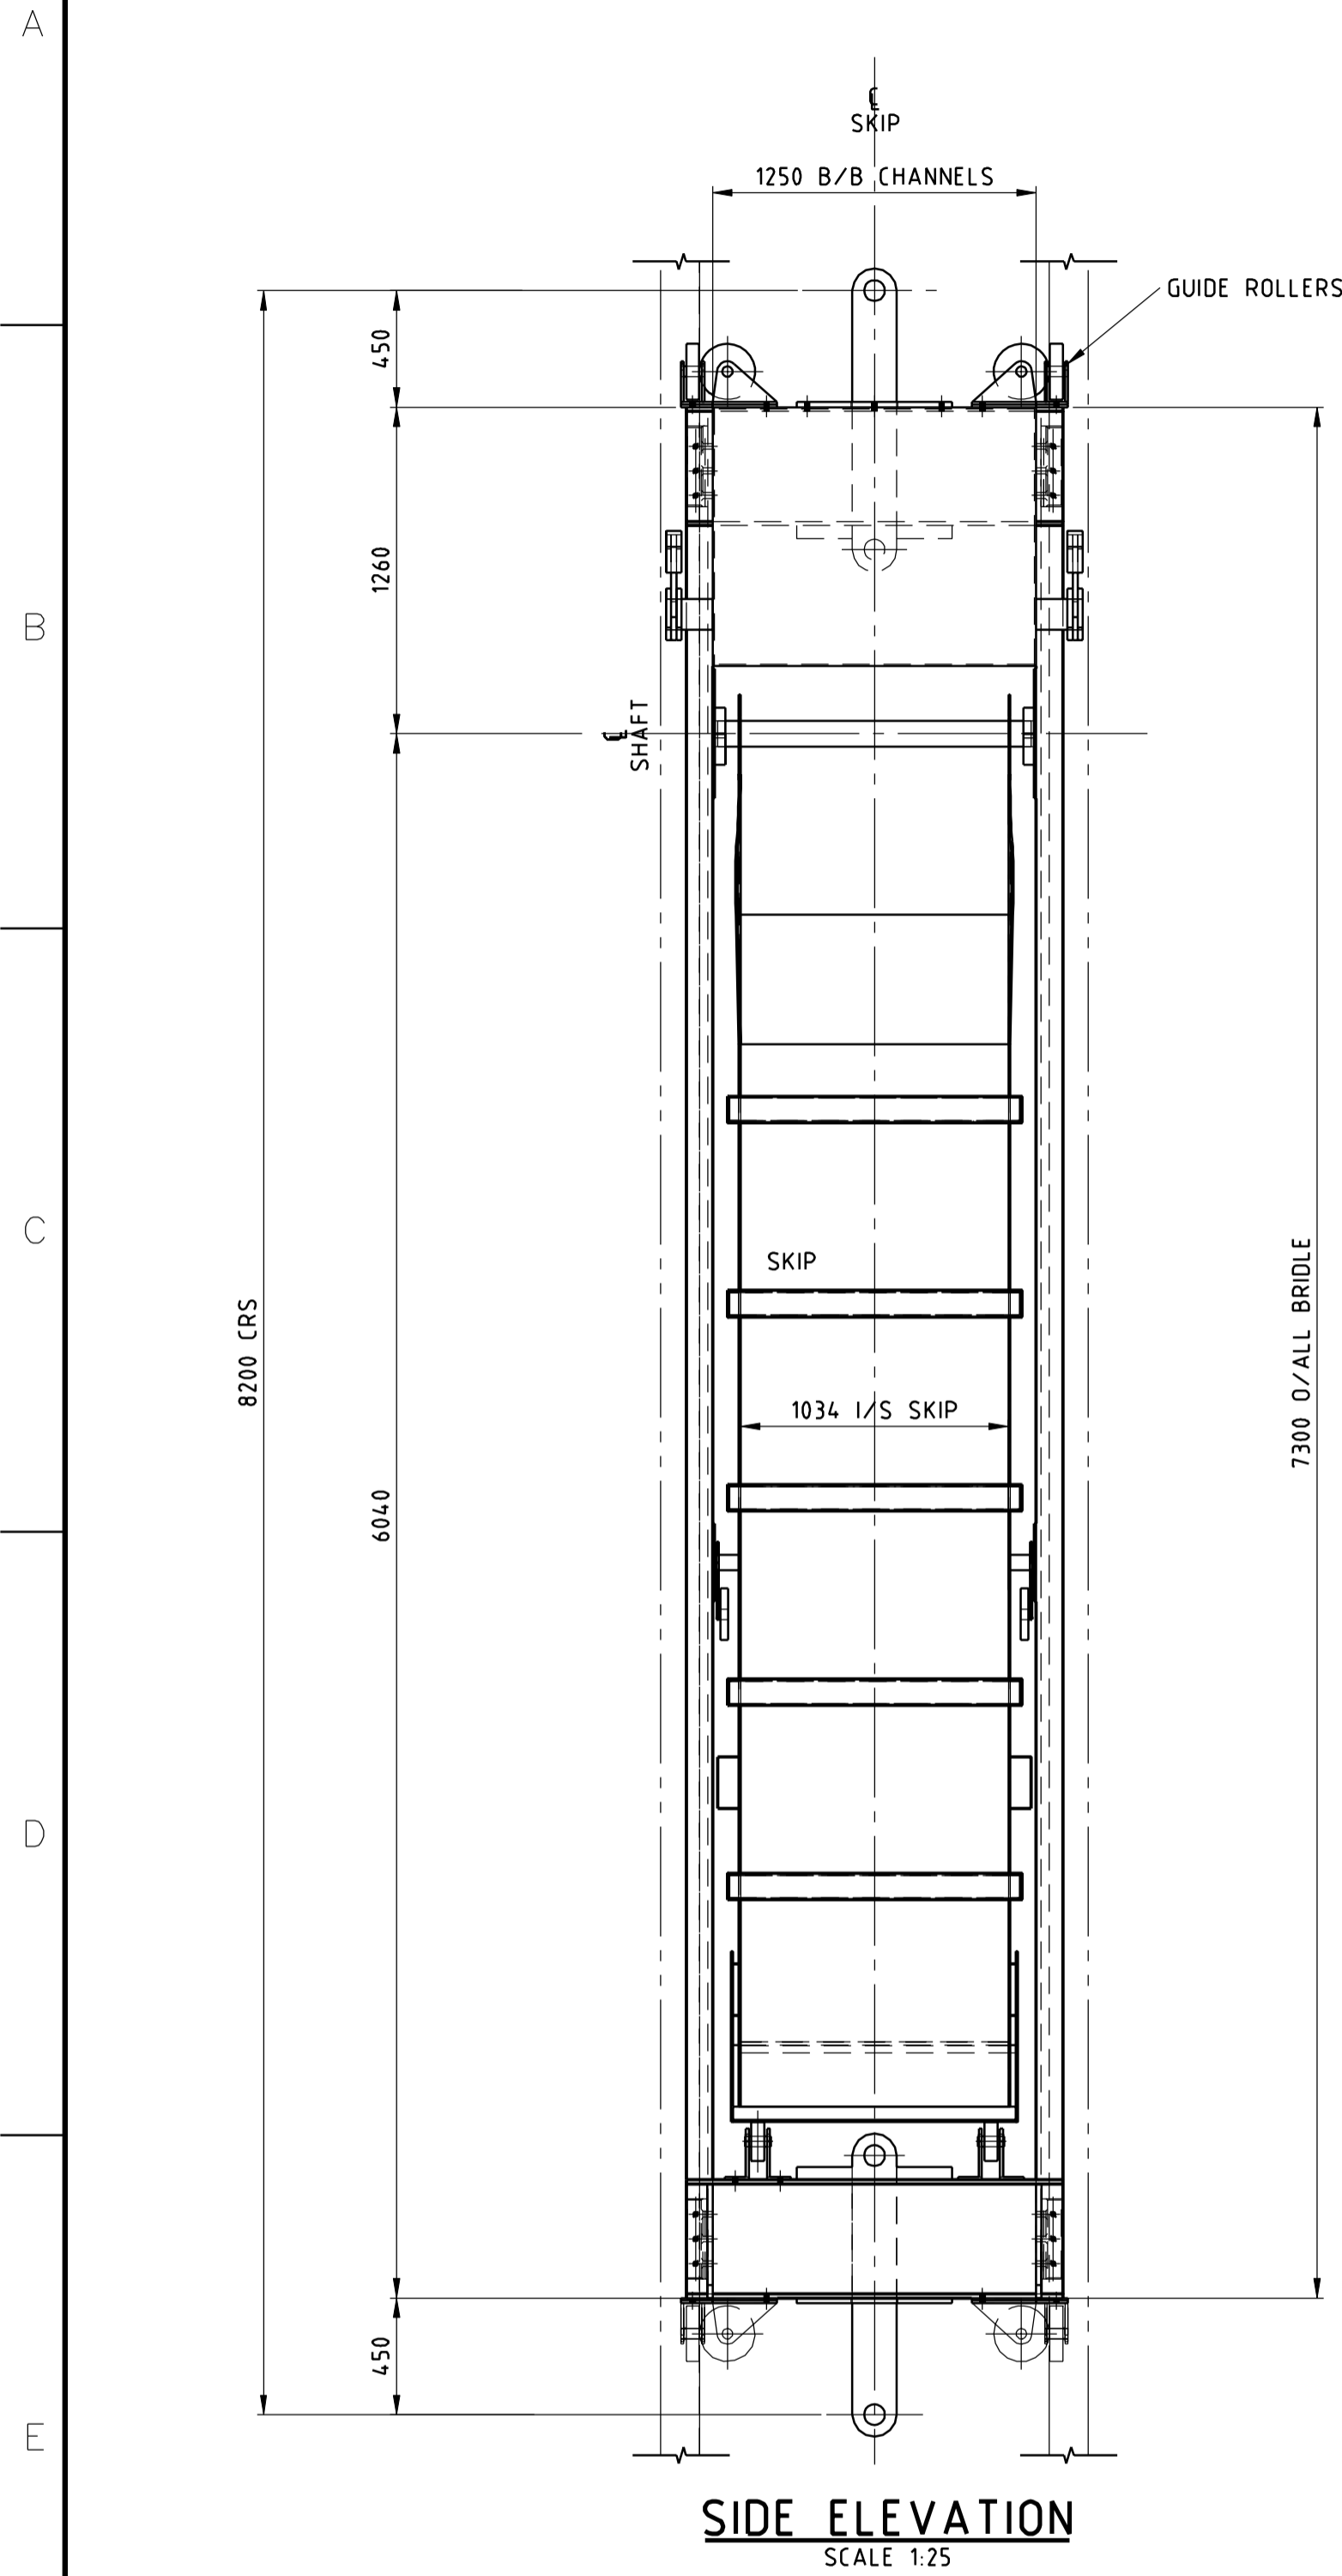


SIDE ELEVATION
SCALE 1:25

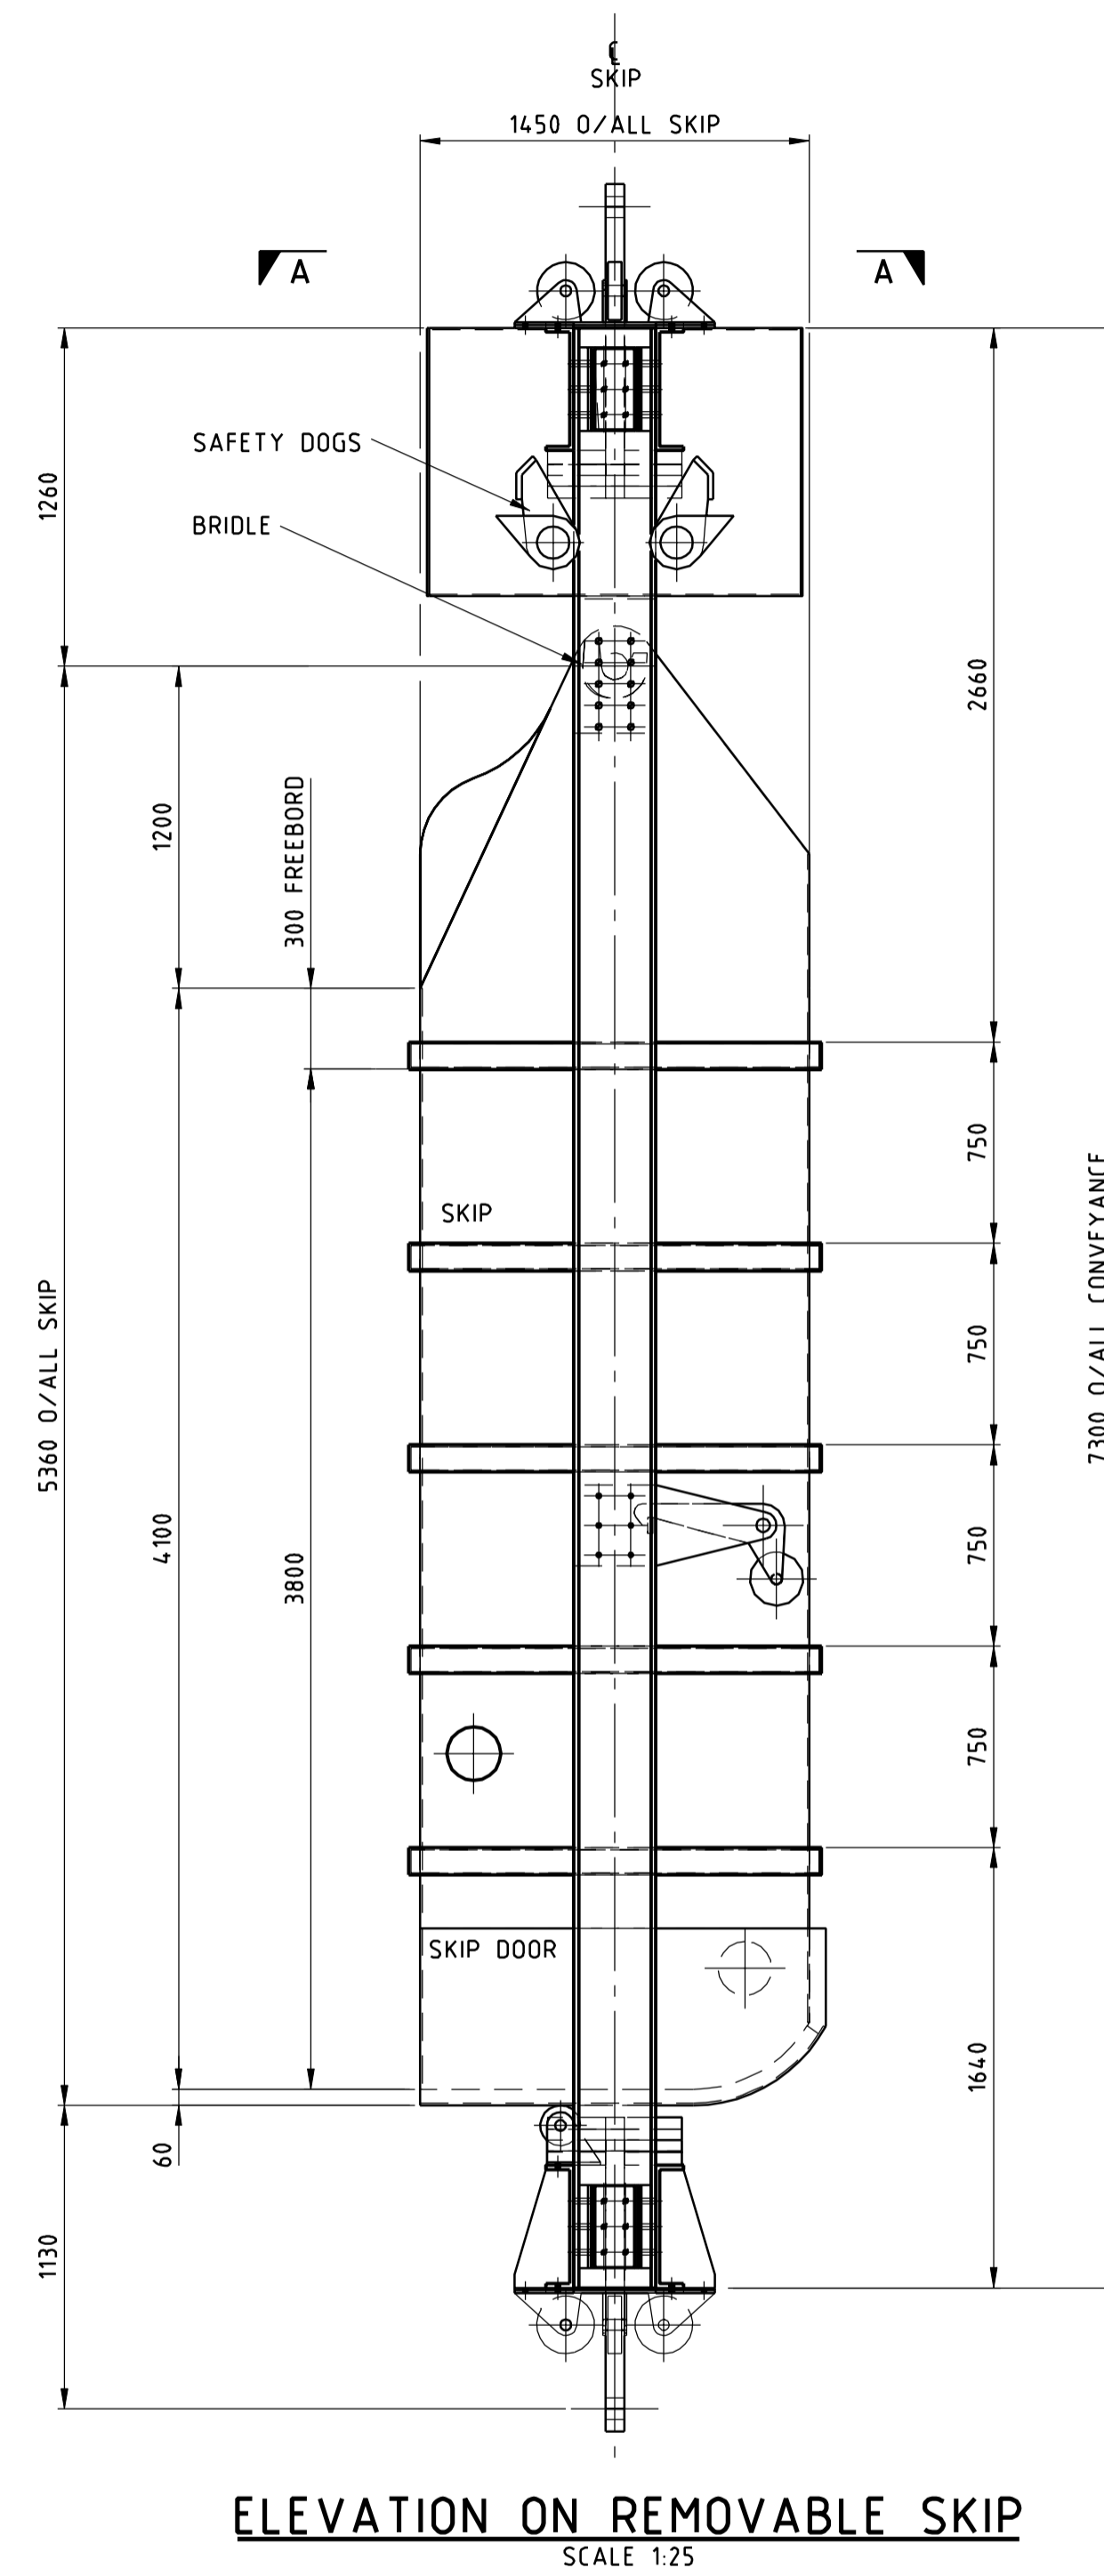

ELEVATION ON REMOVABLE SKIP
SCALE 1:25

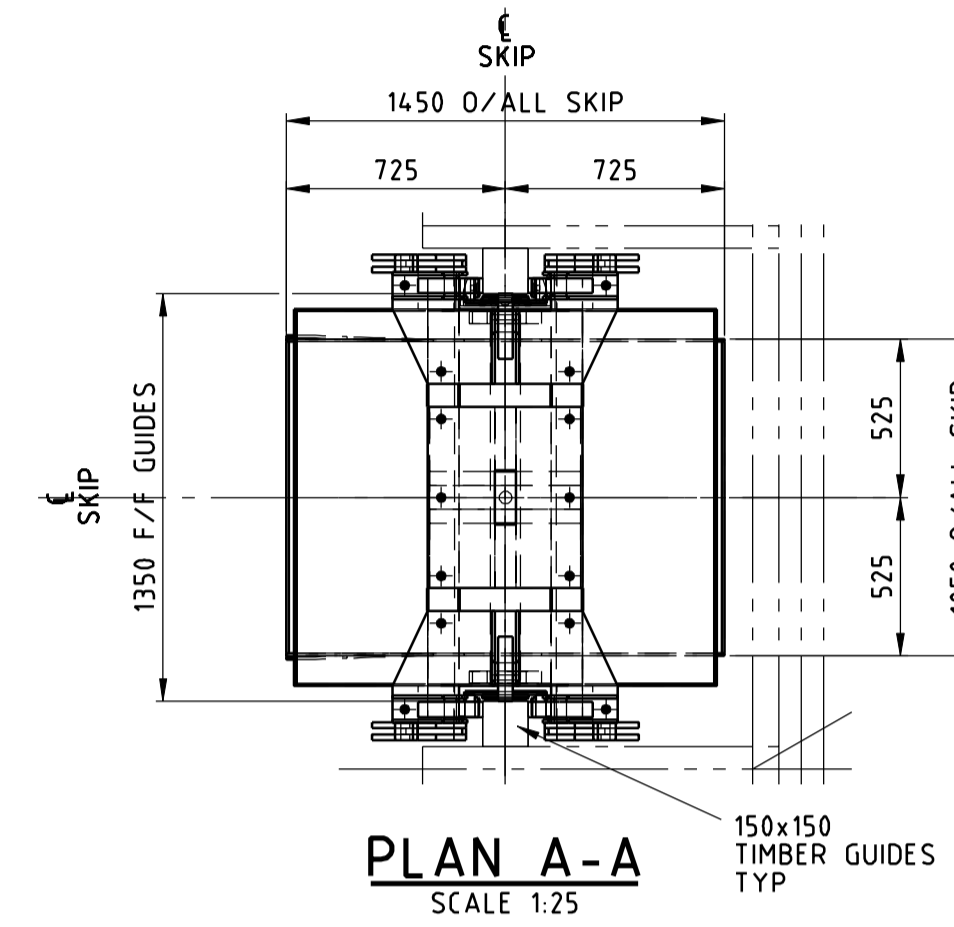

PLAN A-A
SCALE 1:25
150x150
TIMBER
GUIDES
TYP

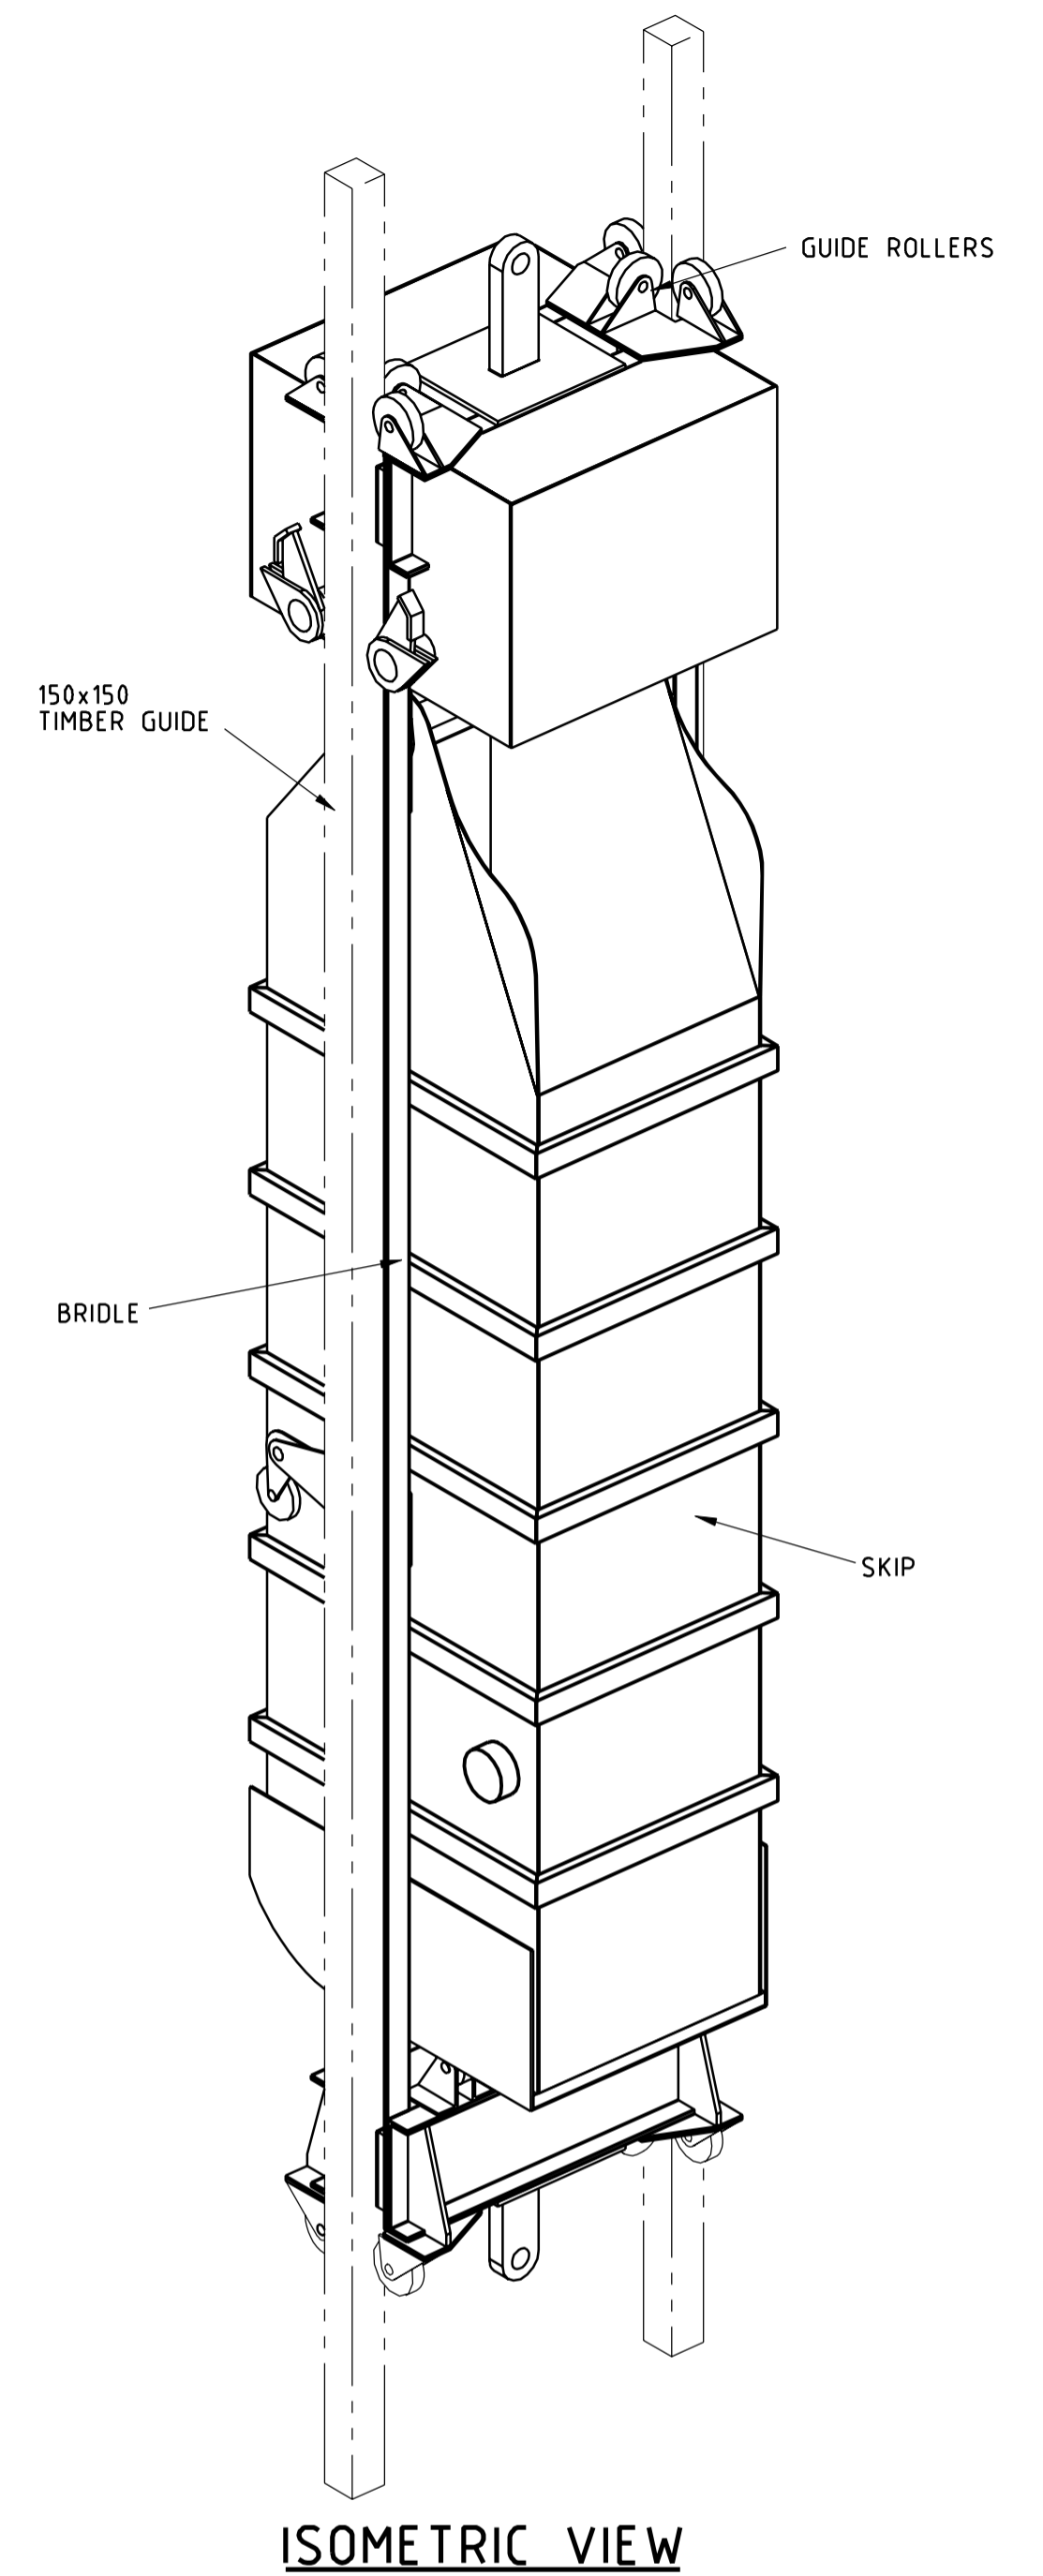

ISOMETRIC VIEW

ITEMS	ESTIMATED MASS
1. MAXIMUM SKIP PAYLOAD	9 300 KG
2. PRIMARY STEEL MEMBERS	2 015 KG
3. ROPE ATTACHMENTS	230 KG
4. ALLOWANCE FOR SUNDRIES	491 KG
5. SKIP	4650 KG
TOTAL ESTIMATED MAXIMUM MASS	16 686 KG

PRELIMINARY

- GENERAL NOTE:-
1. ALL STRUCTURAL STEELWORK TO BE IN ACCORDANCE WITH CAN/CSA-S16-01.
 2. ALL STRUCTURAL STEEL TO BE CSA G40.21 350WT UNLESS OTHERWISE NOTED.
 3. DRAWING TO BE USED FOR PRELIMINARY DESIGN ONLY, NOT TO BE USED FOR CONSTRUCTION.
 4. SIZE OF CONVEYANCE BASED ON SHAFT SIZE FROM CONCEPTUAL DESIGN REPORT.
 5. ROLLOMATIC BOTTOM DISCHARGE TYPE SKIP ASSUMED.
 6. A 2 Tonne ALLOWANCE HAS BEEN MADE FOR EITHER SLINGING OF AN INSPECTION PLATFORM UNDER THE SKIP OR PLACING AN INSPECTION PLATFORM ON TOP OF THE SKIP.

NO.	DESCRIPTION	CHK'D	APP'D	DATE

<p>NOT FOR CONSTRUCTION This drawing has been reviewed for the purposes of DGR Preliminary Engineering only and must not be used for other purposes.</p>				
<p>Work Package Owner Stephen Keen Digitally signed by Stephen Keen DN: cn=Stephen Keen, o=Hatch Ltd., email=s.keen@hatch.com, c=CA</p>				
<p>Area Lead G.R. Davy Digitally signed by G.R. Davy DN: cn=G.R. Davy, o=Hatch Ltd., email=g.r.davy@hatch.com, c=CA</p>				
<p>Engineering Manager Stephen Keen Digitally signed by Stephen Keen DN: cn=Stephen Keen, o=Hatch Ltd., email=s.keen@hatch.com, c=CA</p>				
<p>Project Manager M. Dawborn Digitally signed by M. Dawborn DN: cn=M. Dawborn, o=Hatch Ltd., email=m.dawborn@hatch.com, c=CA</p>				
<p>Accepted by Owner Digitally signed by Owner DN: cn=Owner, o=Owner, email=owner@owner.com, c=CA</p>				

DESIGNED BY	M.C. BOTHMA	DATE	14/10/09
CHECKED BY	S. KEEN	DATE	14/10/09
PROJ. DES. COORD.	M. DAWBORN	DATE	14/10/09
DATE	03/12/09	DATE	03/12/09
REV.	ISSUE FOR	AUTH. BY	DATE
00	APPROVED FOR USE	GRD SAA	03/12/09
ISSUE AUTHORIZATION			

HATCH


NUCLEAR WASTE MANAGEMENT ORGANIZATION
 DEEP GEOLOGIC REPOSITORY PROJECT

SHAFT HOISTING SYSTEMS


VENTILATION SHAFT-LATERAL DEVELOPMENT
 BALE AND REMOVABLE SKIP
 GENERAL ARRANGEMENT

SCALE 1:25
 DWG. NO. H333000-WP405-20-042-0015


A
B
C
D
E
F

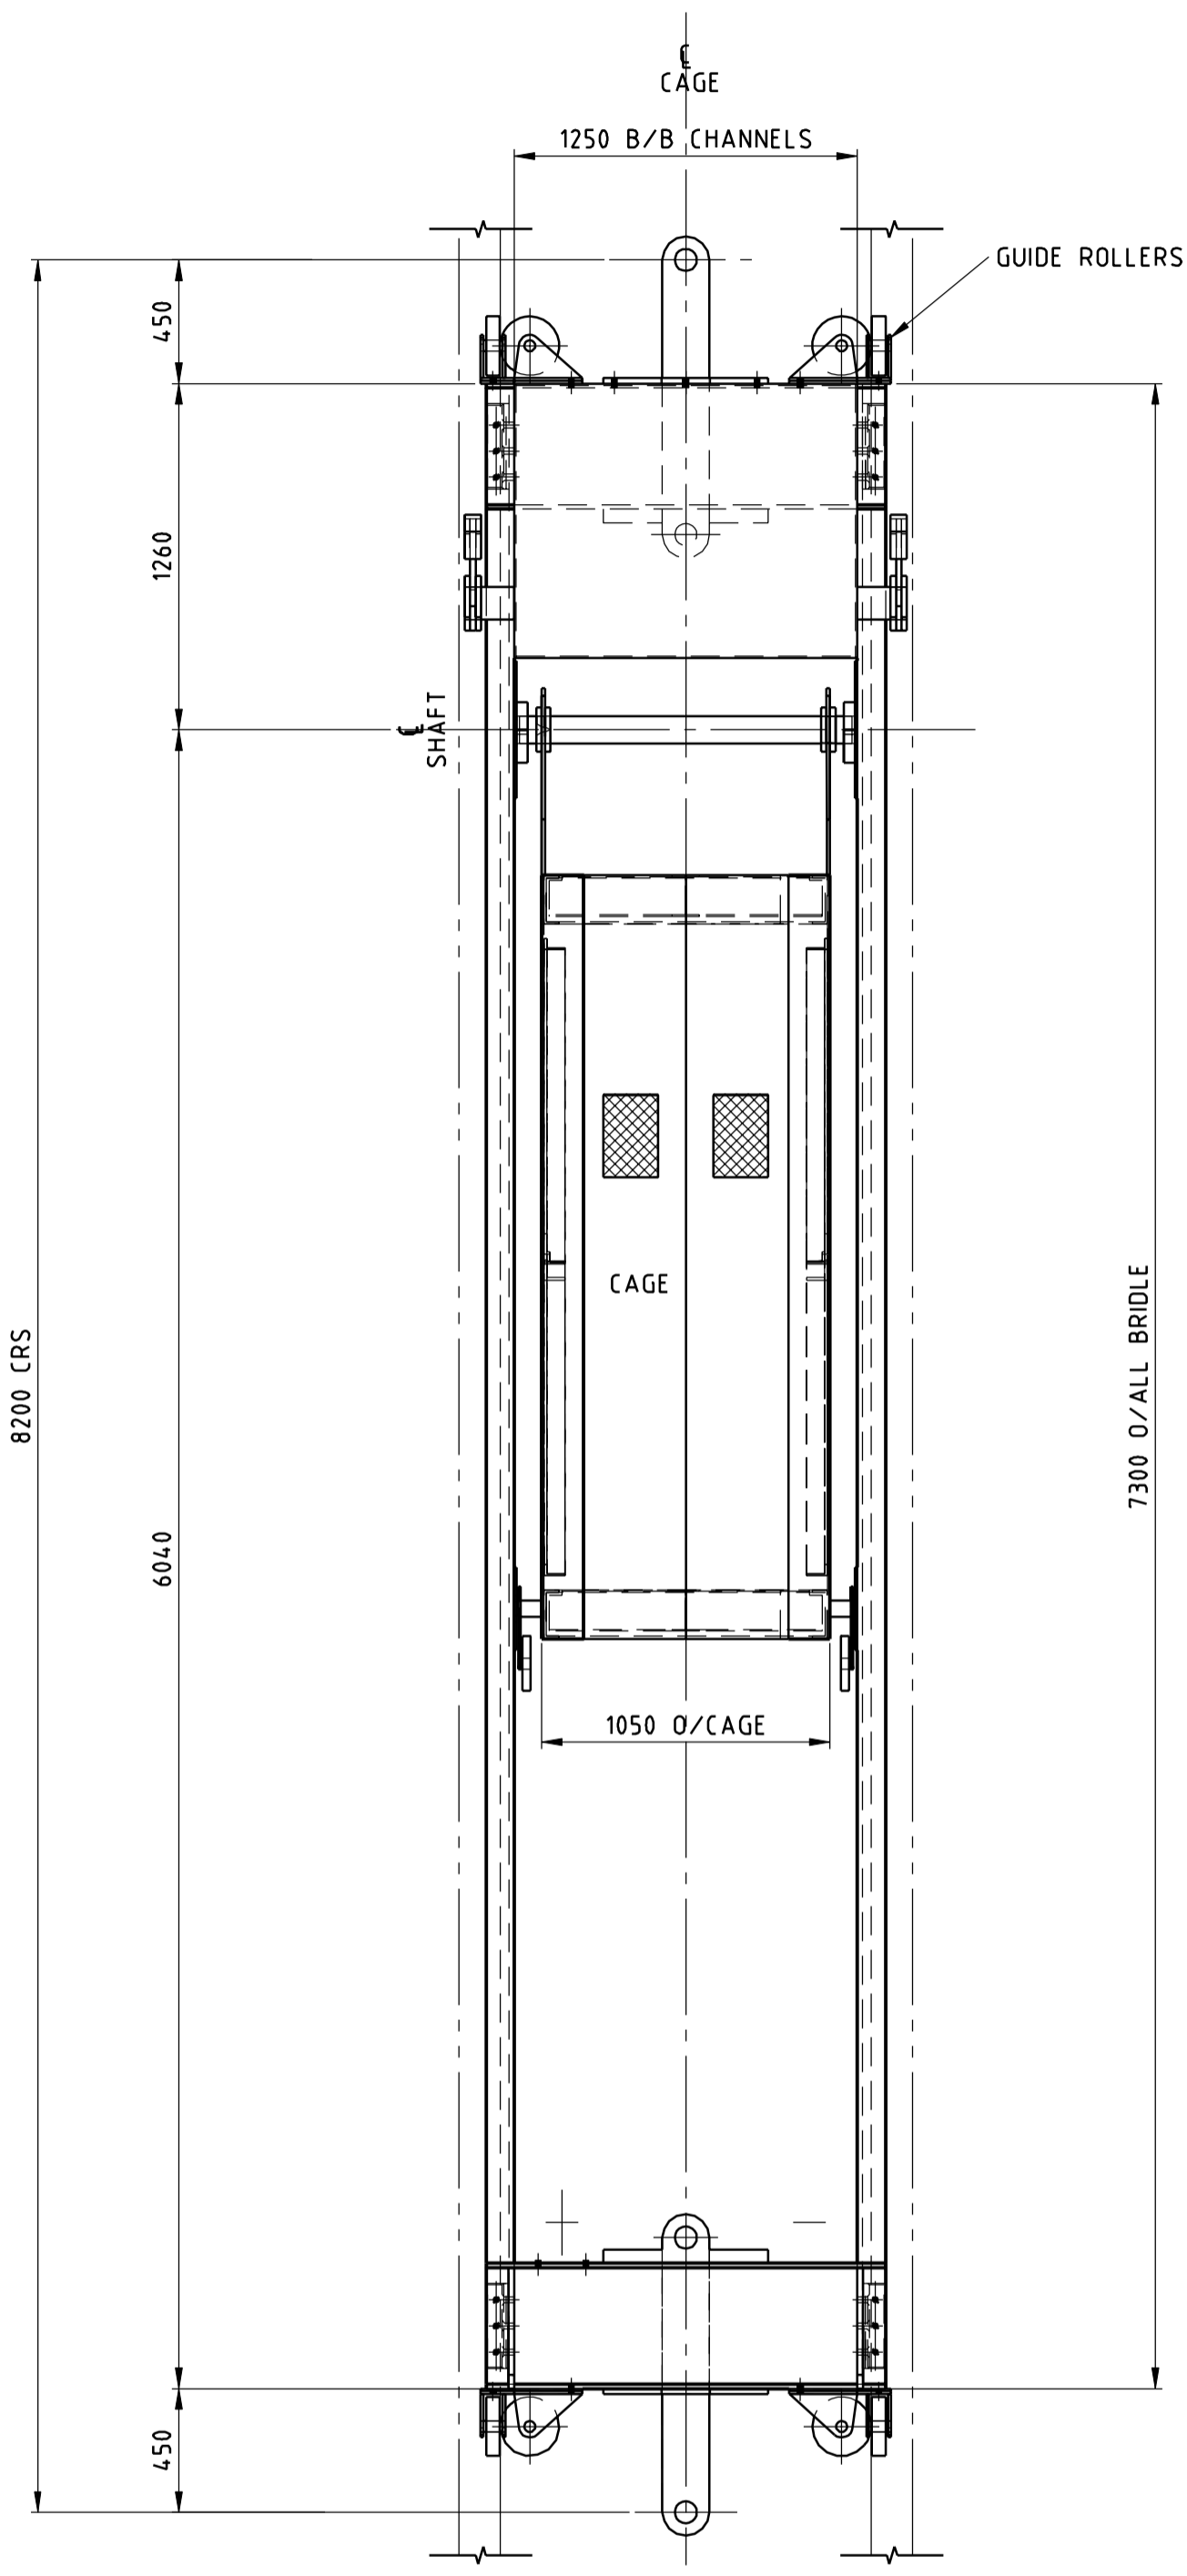


SIDE ELEVATION
SCALE 1:25

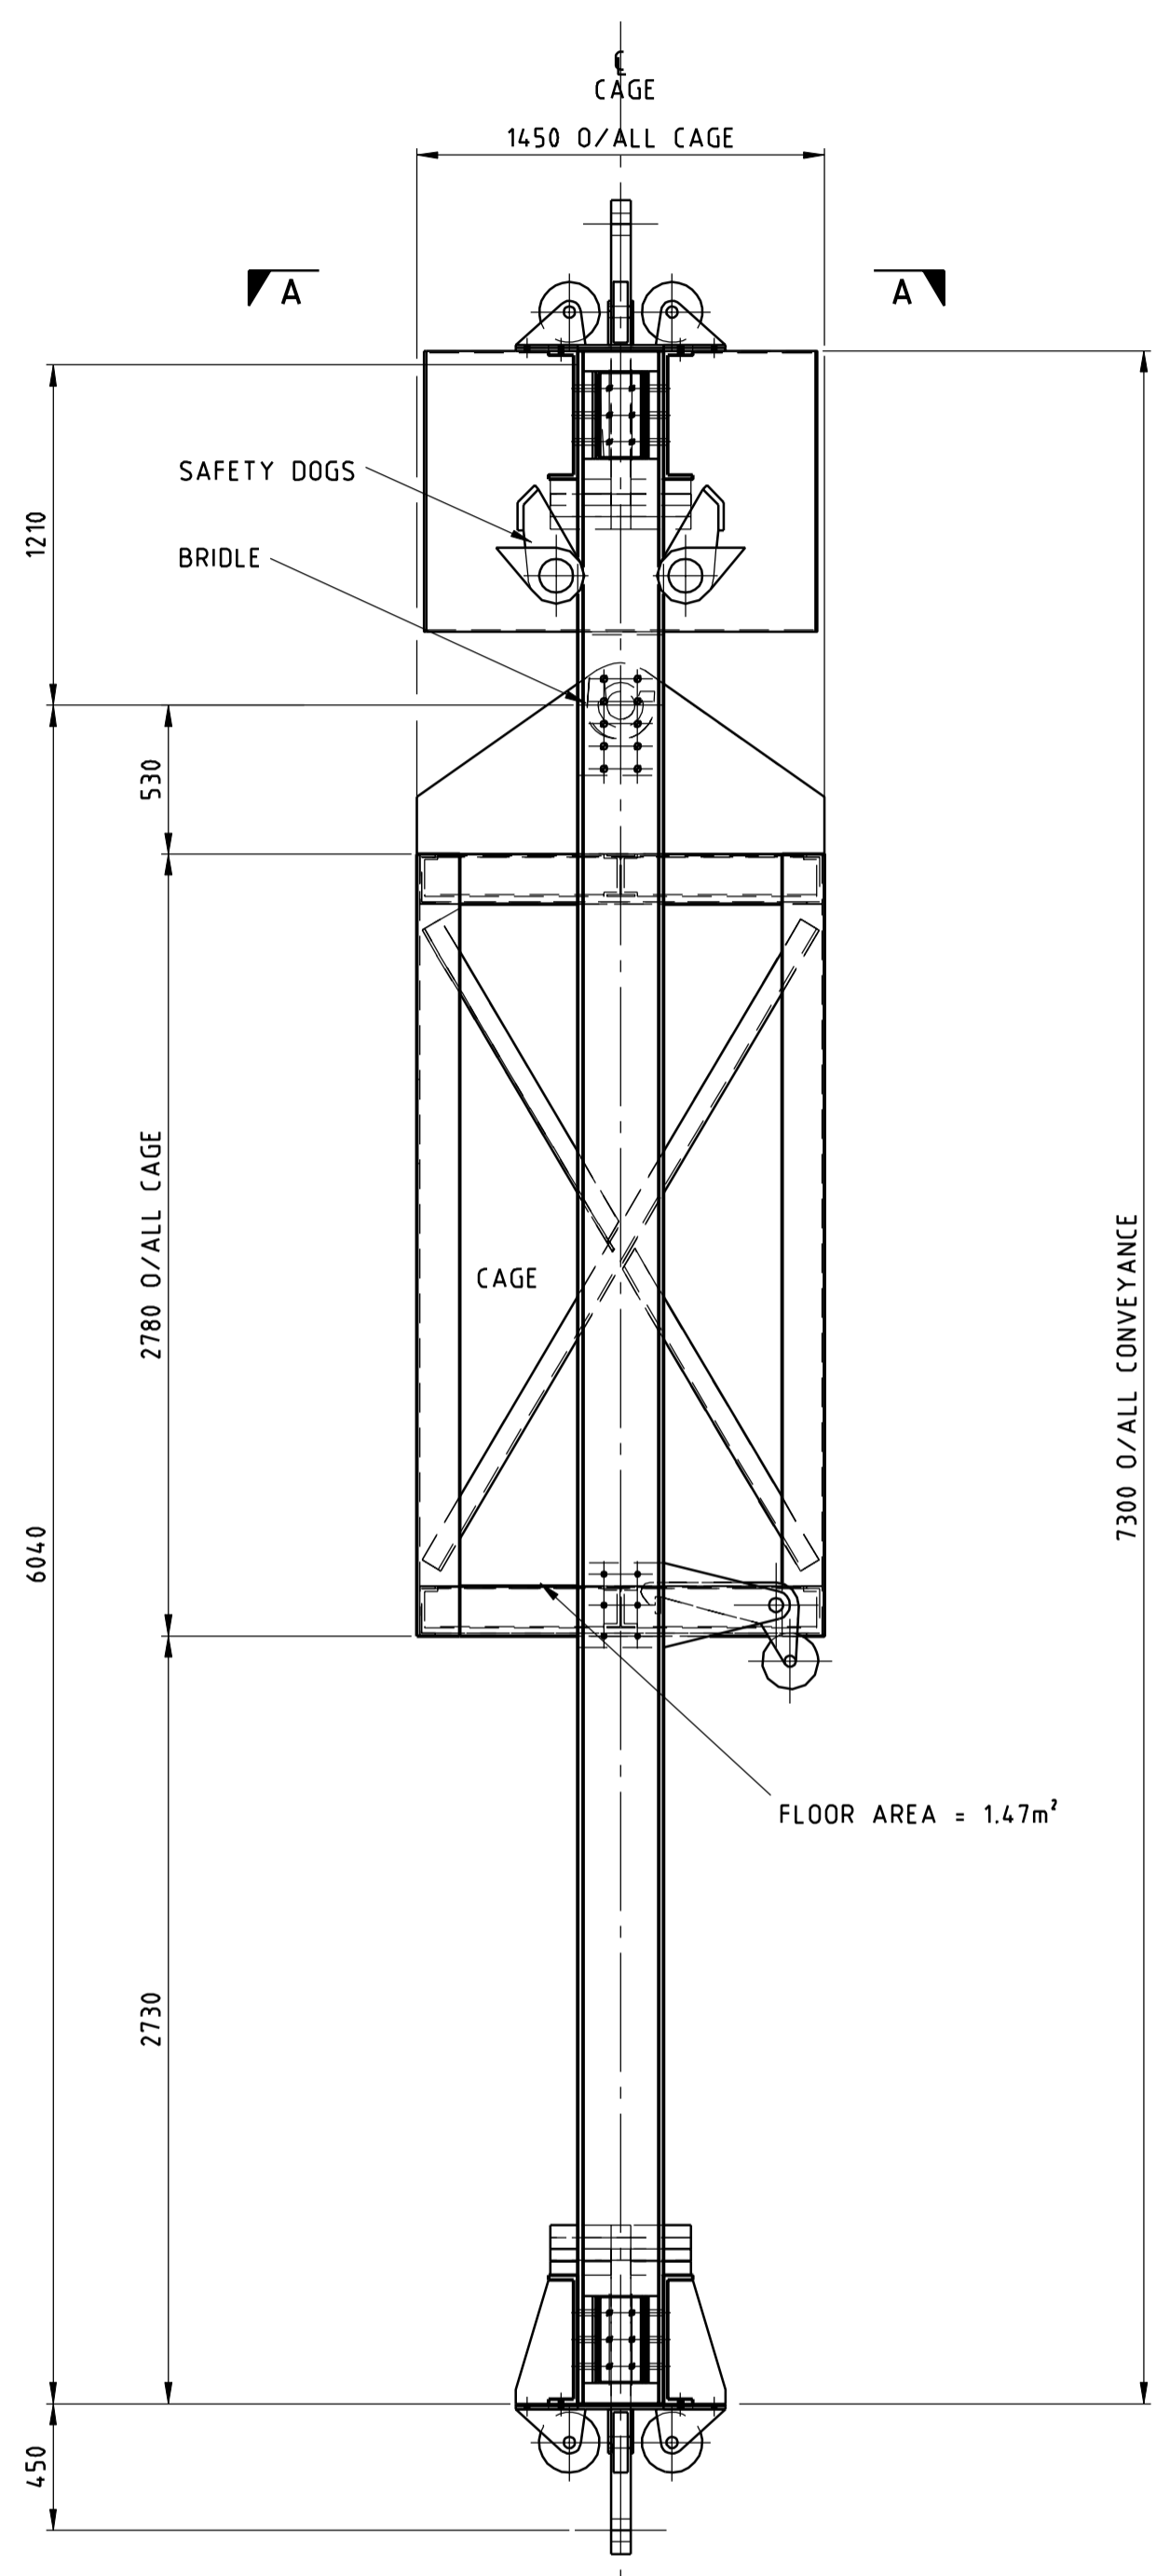

ELEVATION ON REMOVABLE CAGE
SCALE 1:25

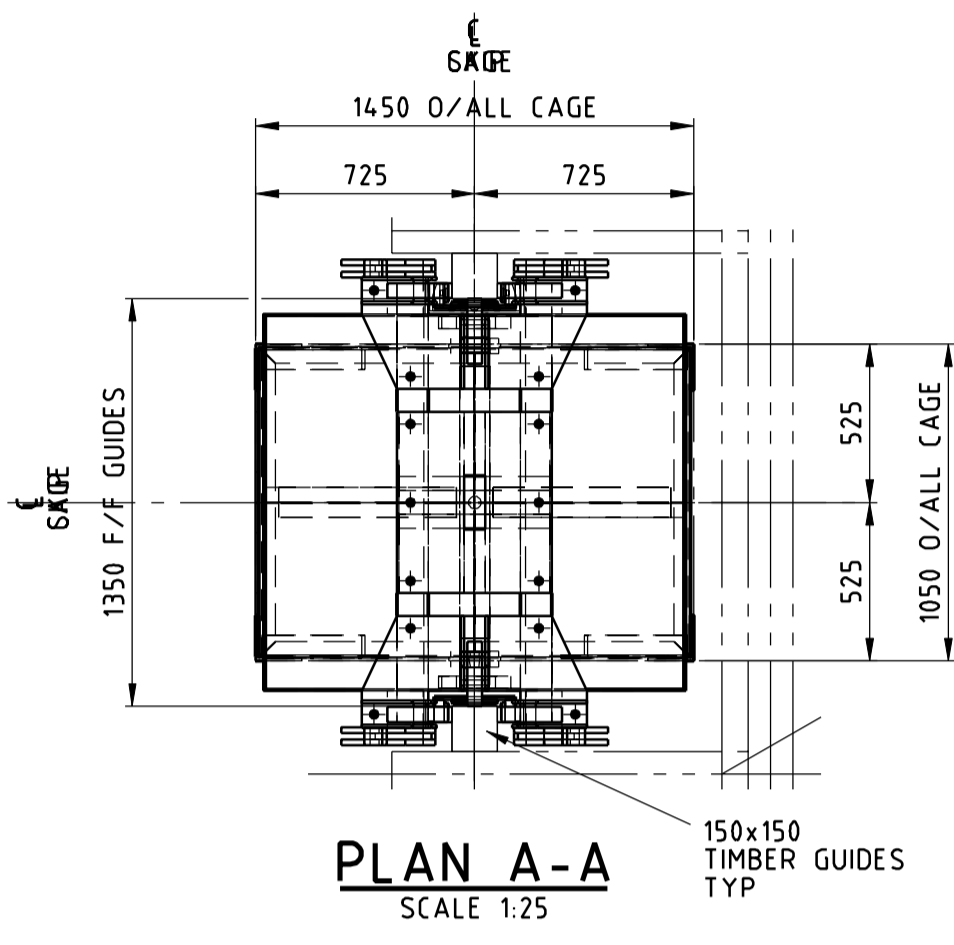

PLAN A-A
SCALE 1:25
150x150 TIMBER GUIDES TYP

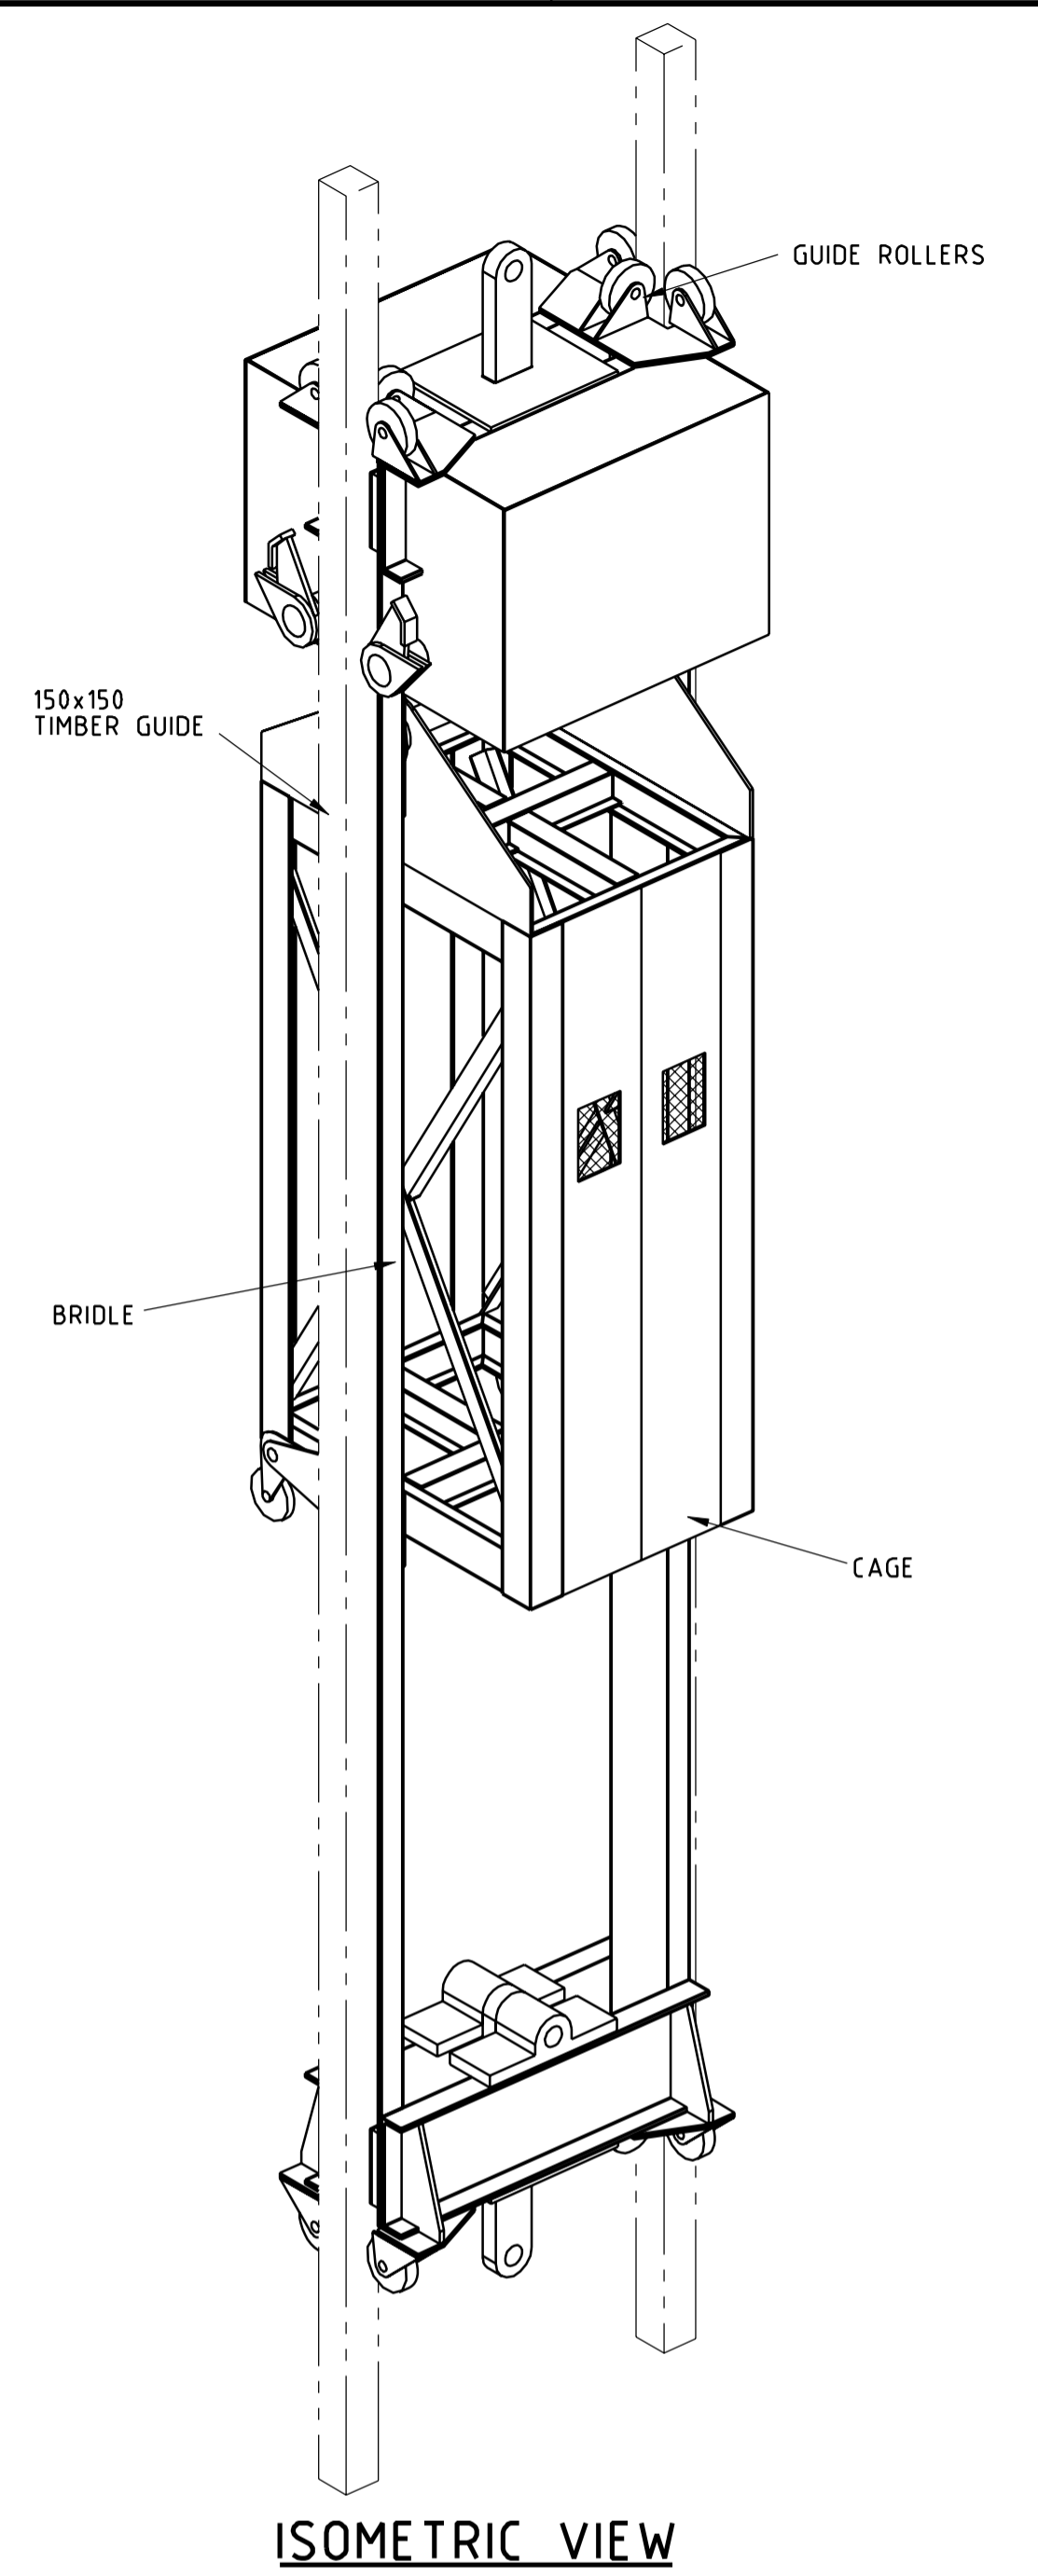

ISOMETRIC VIEW

ITEMS	ESTIMATED MASS
1. PRIMARY STEEL MEMBERS	2 870 KG
2. ROPE ATTACHMENTS	230 KG
3. ALLOWANCE FOR SUNDRIES	700 KG
4. CAGE MATERIAL TRANSPORT	847 KG
TOTAL ESTIMATED MAXIMUM MASS	4 647 KG

PRELIMINARY

- GENERAL NOTE--
- ALL STRUCTURAL STEELWORK TO BE IN ACCORDANCE WITH CAN/CSA-S16-01.
 - ALL STRUCTURAL STEEL TO BE CSA G40.21 350WT UNLESS OTHERWISE NOTED.
 - DRAWING TO BE USED FOR PRELIMINARY DESIGN ONLY, NOT TO BE USED FOR CONSTRUCTION.
 - SIZE OF CONVEYANCE BASED ON SHAFT SIZE FROM CONCEPTUAL DESIGN REPORT.
 - A 2 Tonne ALLOWANCE HAS BEEN MADE FOR EITHER SLINGING OF AN INSPECTION PLATFORM UNDER THE SKIP OR PLACING AN INSPECTION PLATFORM ON TOP OF THE SKIP

DRAWING NO.	DRAWING TITLE

REFERENCE DRAWINGS

NO.	DESCRIPTION	CHK'D	APP'D	DATE

REVISIONS


REV.	ISSUE FOR	AUTH. BY	DATE
00	APPROVED FOR USE	GRD SAA	03/12/09

ISSUE AUTHORIZATION

DESIGNED BY	DRAWN BY
	M.C. BOTHMA
DATE	DATE 14/10/09
CHECKED BY	DISCIPL. ENGR.
S. KEEN	
DATE 14/10/09	DATE
PROJ. DES. COORD.	PROJ. ENGR.

NUCLEAR WASTE MANAGEMENT ORGANIZATION DEEP GEOLOGIC REPOSITORY PROJECT	
SHAFT HOISTING SYSTEMS	
VENTILATION SHAFT-LATERAL DEVELOPMENT BALE AND REMOVABLE CAGE GENERAL ARRANGEMENT	
SCALE	DWG. NO.
1:25 OR AS NOTED	H333000-WP405-20-042-0016

H333000-WP406-20-042-0001
DWG. NO.

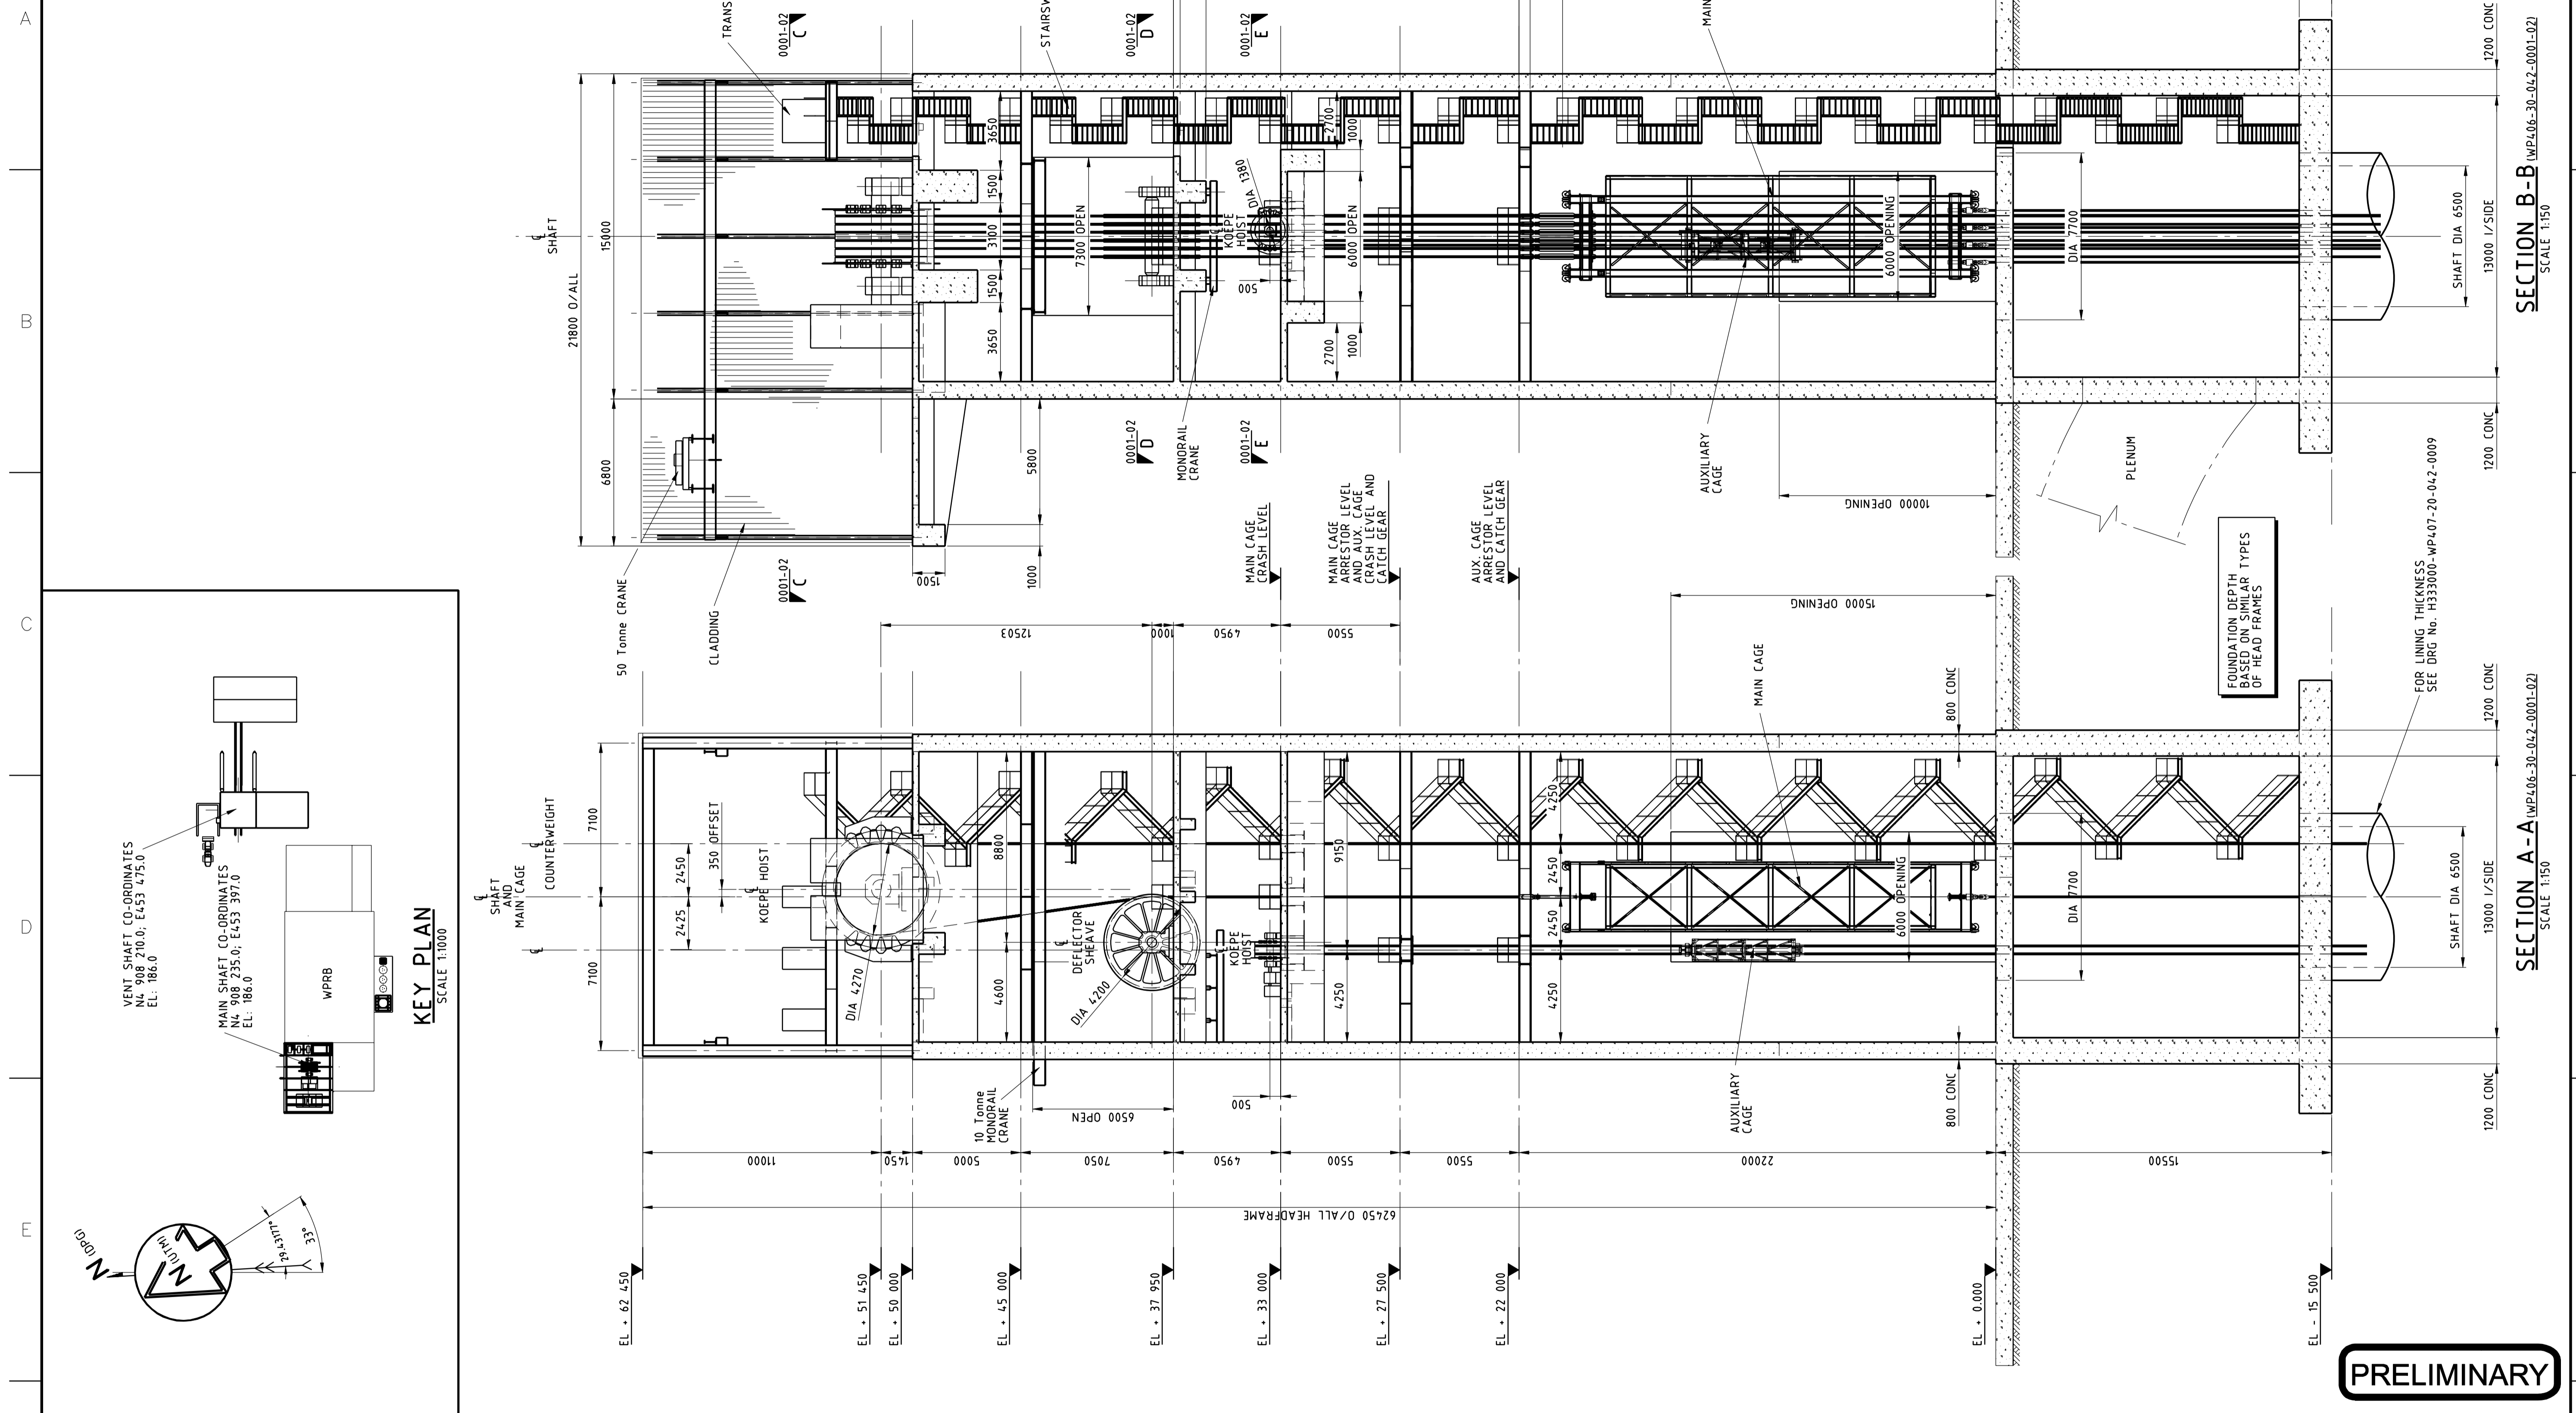

DRAWING NO.	DRAWING TITLE
	REFERENCE DRAWINGS

NO.	DESCRIPTION	CHK'D	APP'D	DATE


NOT FOR CONSTRUCTION This drawing has been reviewed for the purposes of DGR Preliminary Engineering only and must not be used for other purposes.	
Work Package Owner	
Area Lead	Digitally signed by G.R. Davy Date: 2009.12.10 15:47:02 -0500
Engineering Manager	Shelwin Aarons 2009.12.10 15:47:02 -0500
Project Manager	Digitally signed by M.R. Dawson Date: 2009.12.10 15:47:02 -0500
Accepted by Owner	Digitally signed by Drew Wilson Date: 2009.12.10 15:47:02 -0500

HATCH	
DESIGNED BY N. HENDERSON DATE 31/07/09	DRAWN BY R. LABUSCHAGNE DATE 2009-07-31 DISCIPLINE ENGR.
CHECKED BY	DATE
PROJ. DES. COORD.	DATE
M. DAWBORN DATE 31/07/09	


NUCLEAR WASTE MANAGEMENT ORGANIZATION DEEP GEOLOGIC REPOSITORY PROJECT	
HEADFRAMES	
MAIN SHAFT CONCRETE HEADFRAME GENERAL ARRANGEMENT	
SCALE 1:150 OR AS NOTED	DWG. NO. H333000-WP406-20-042-0001

H333000-WP406-20-0002


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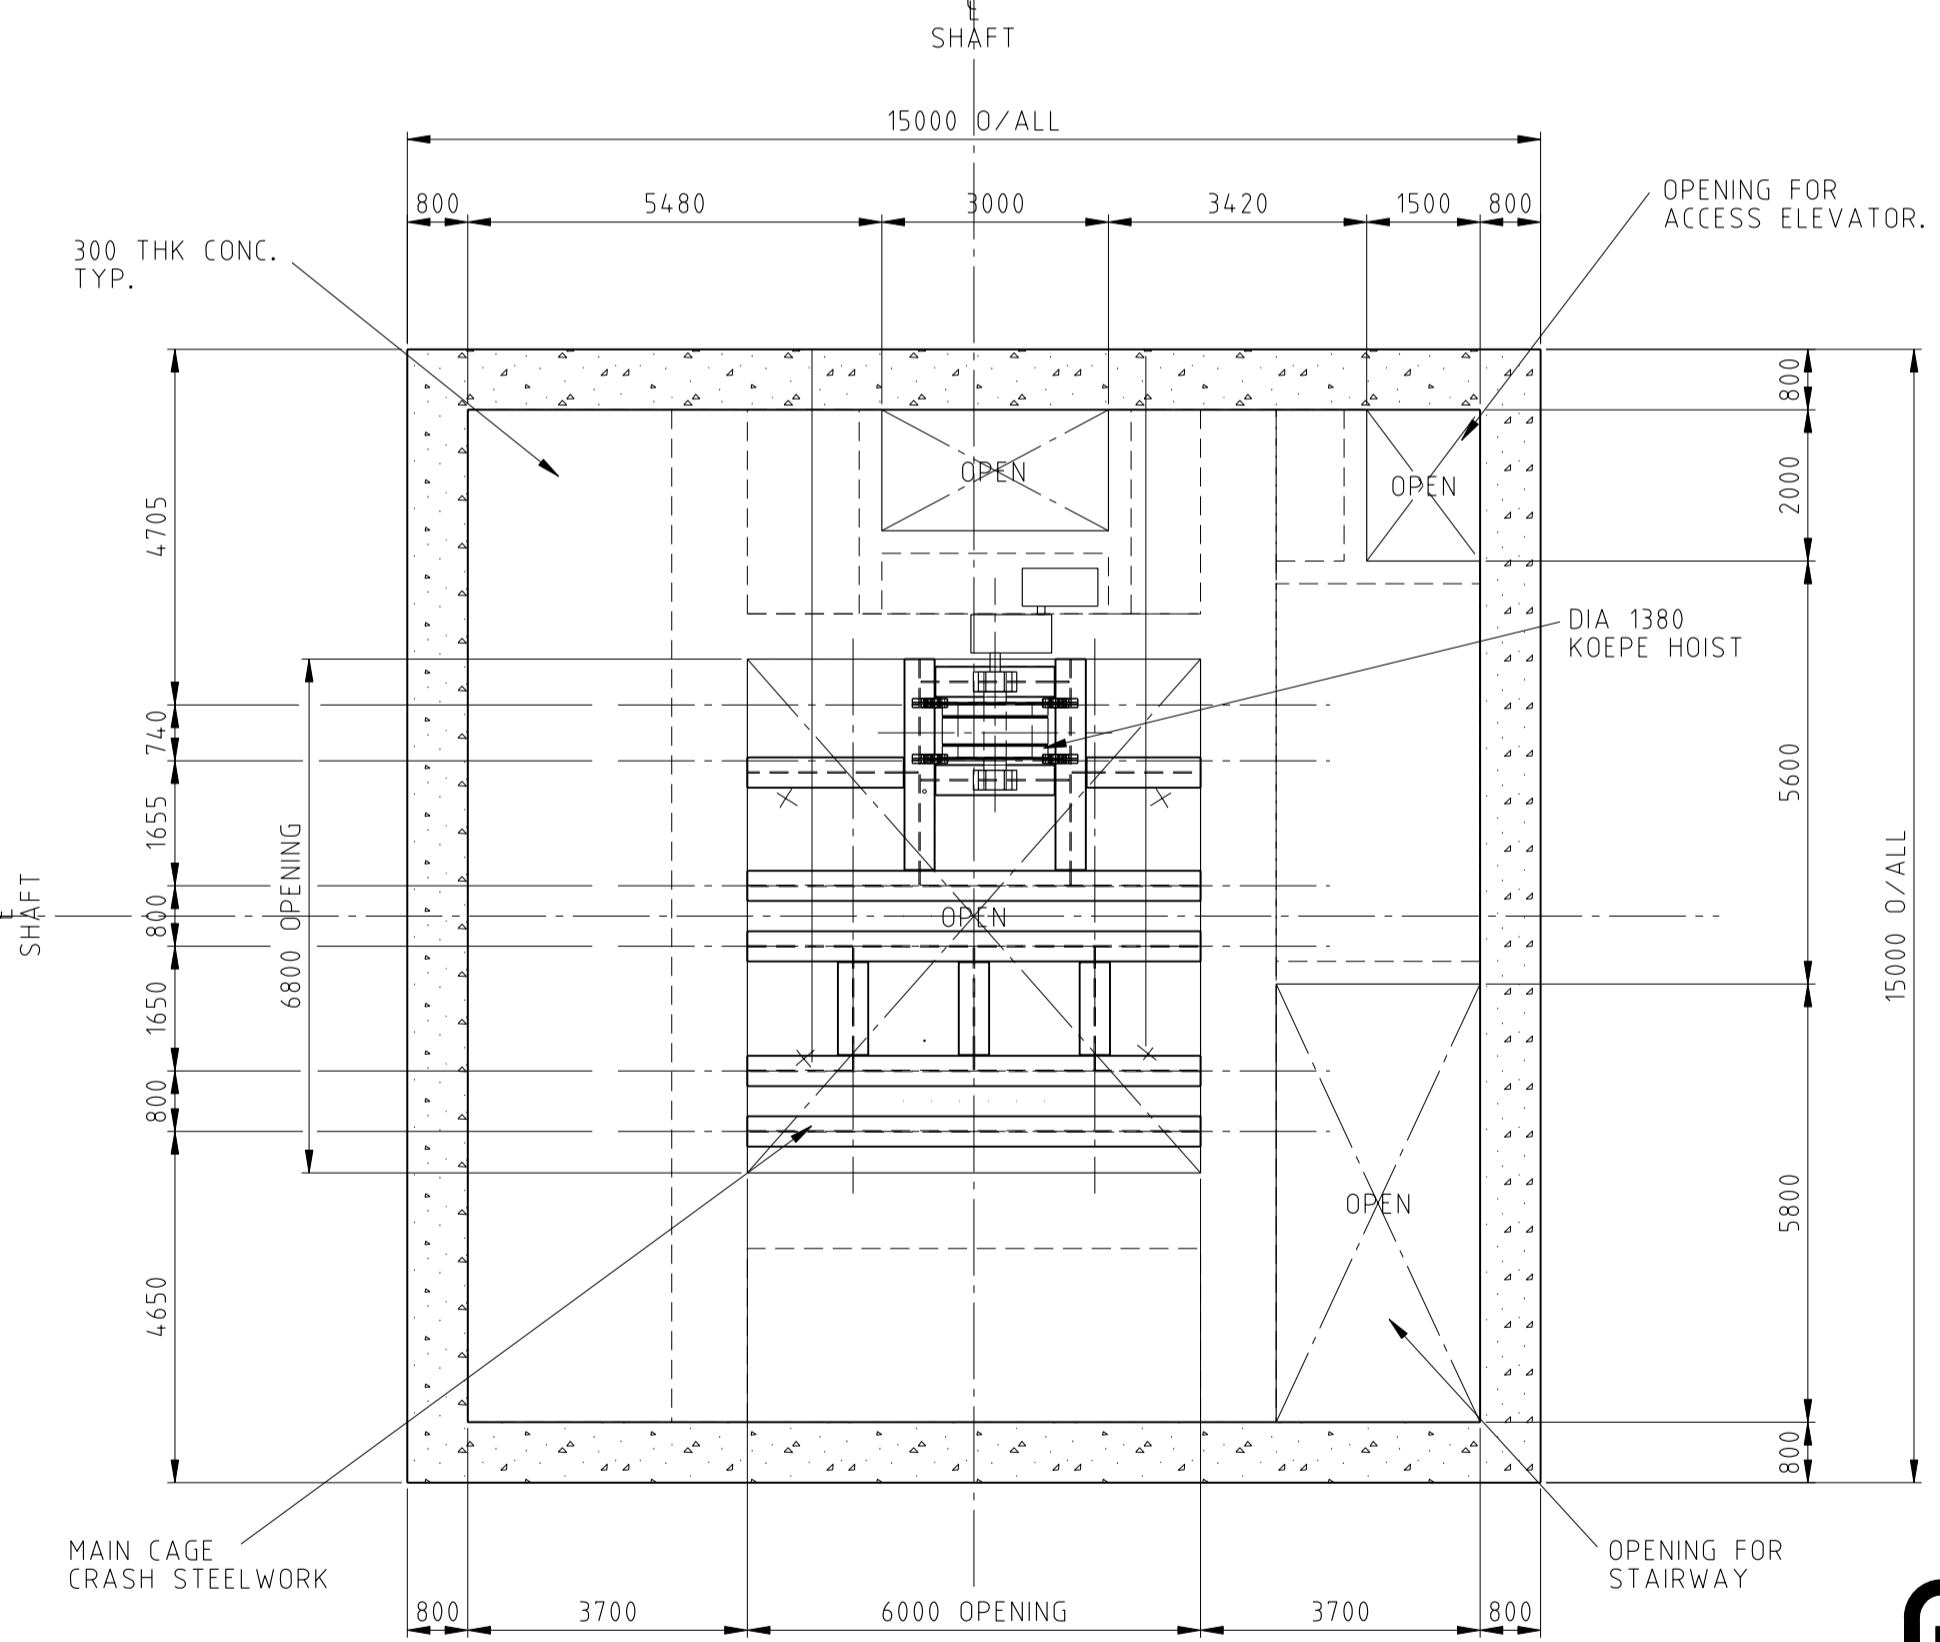
PLAN C-C (WP406-30-042-0001-01)
SCALE 1:100

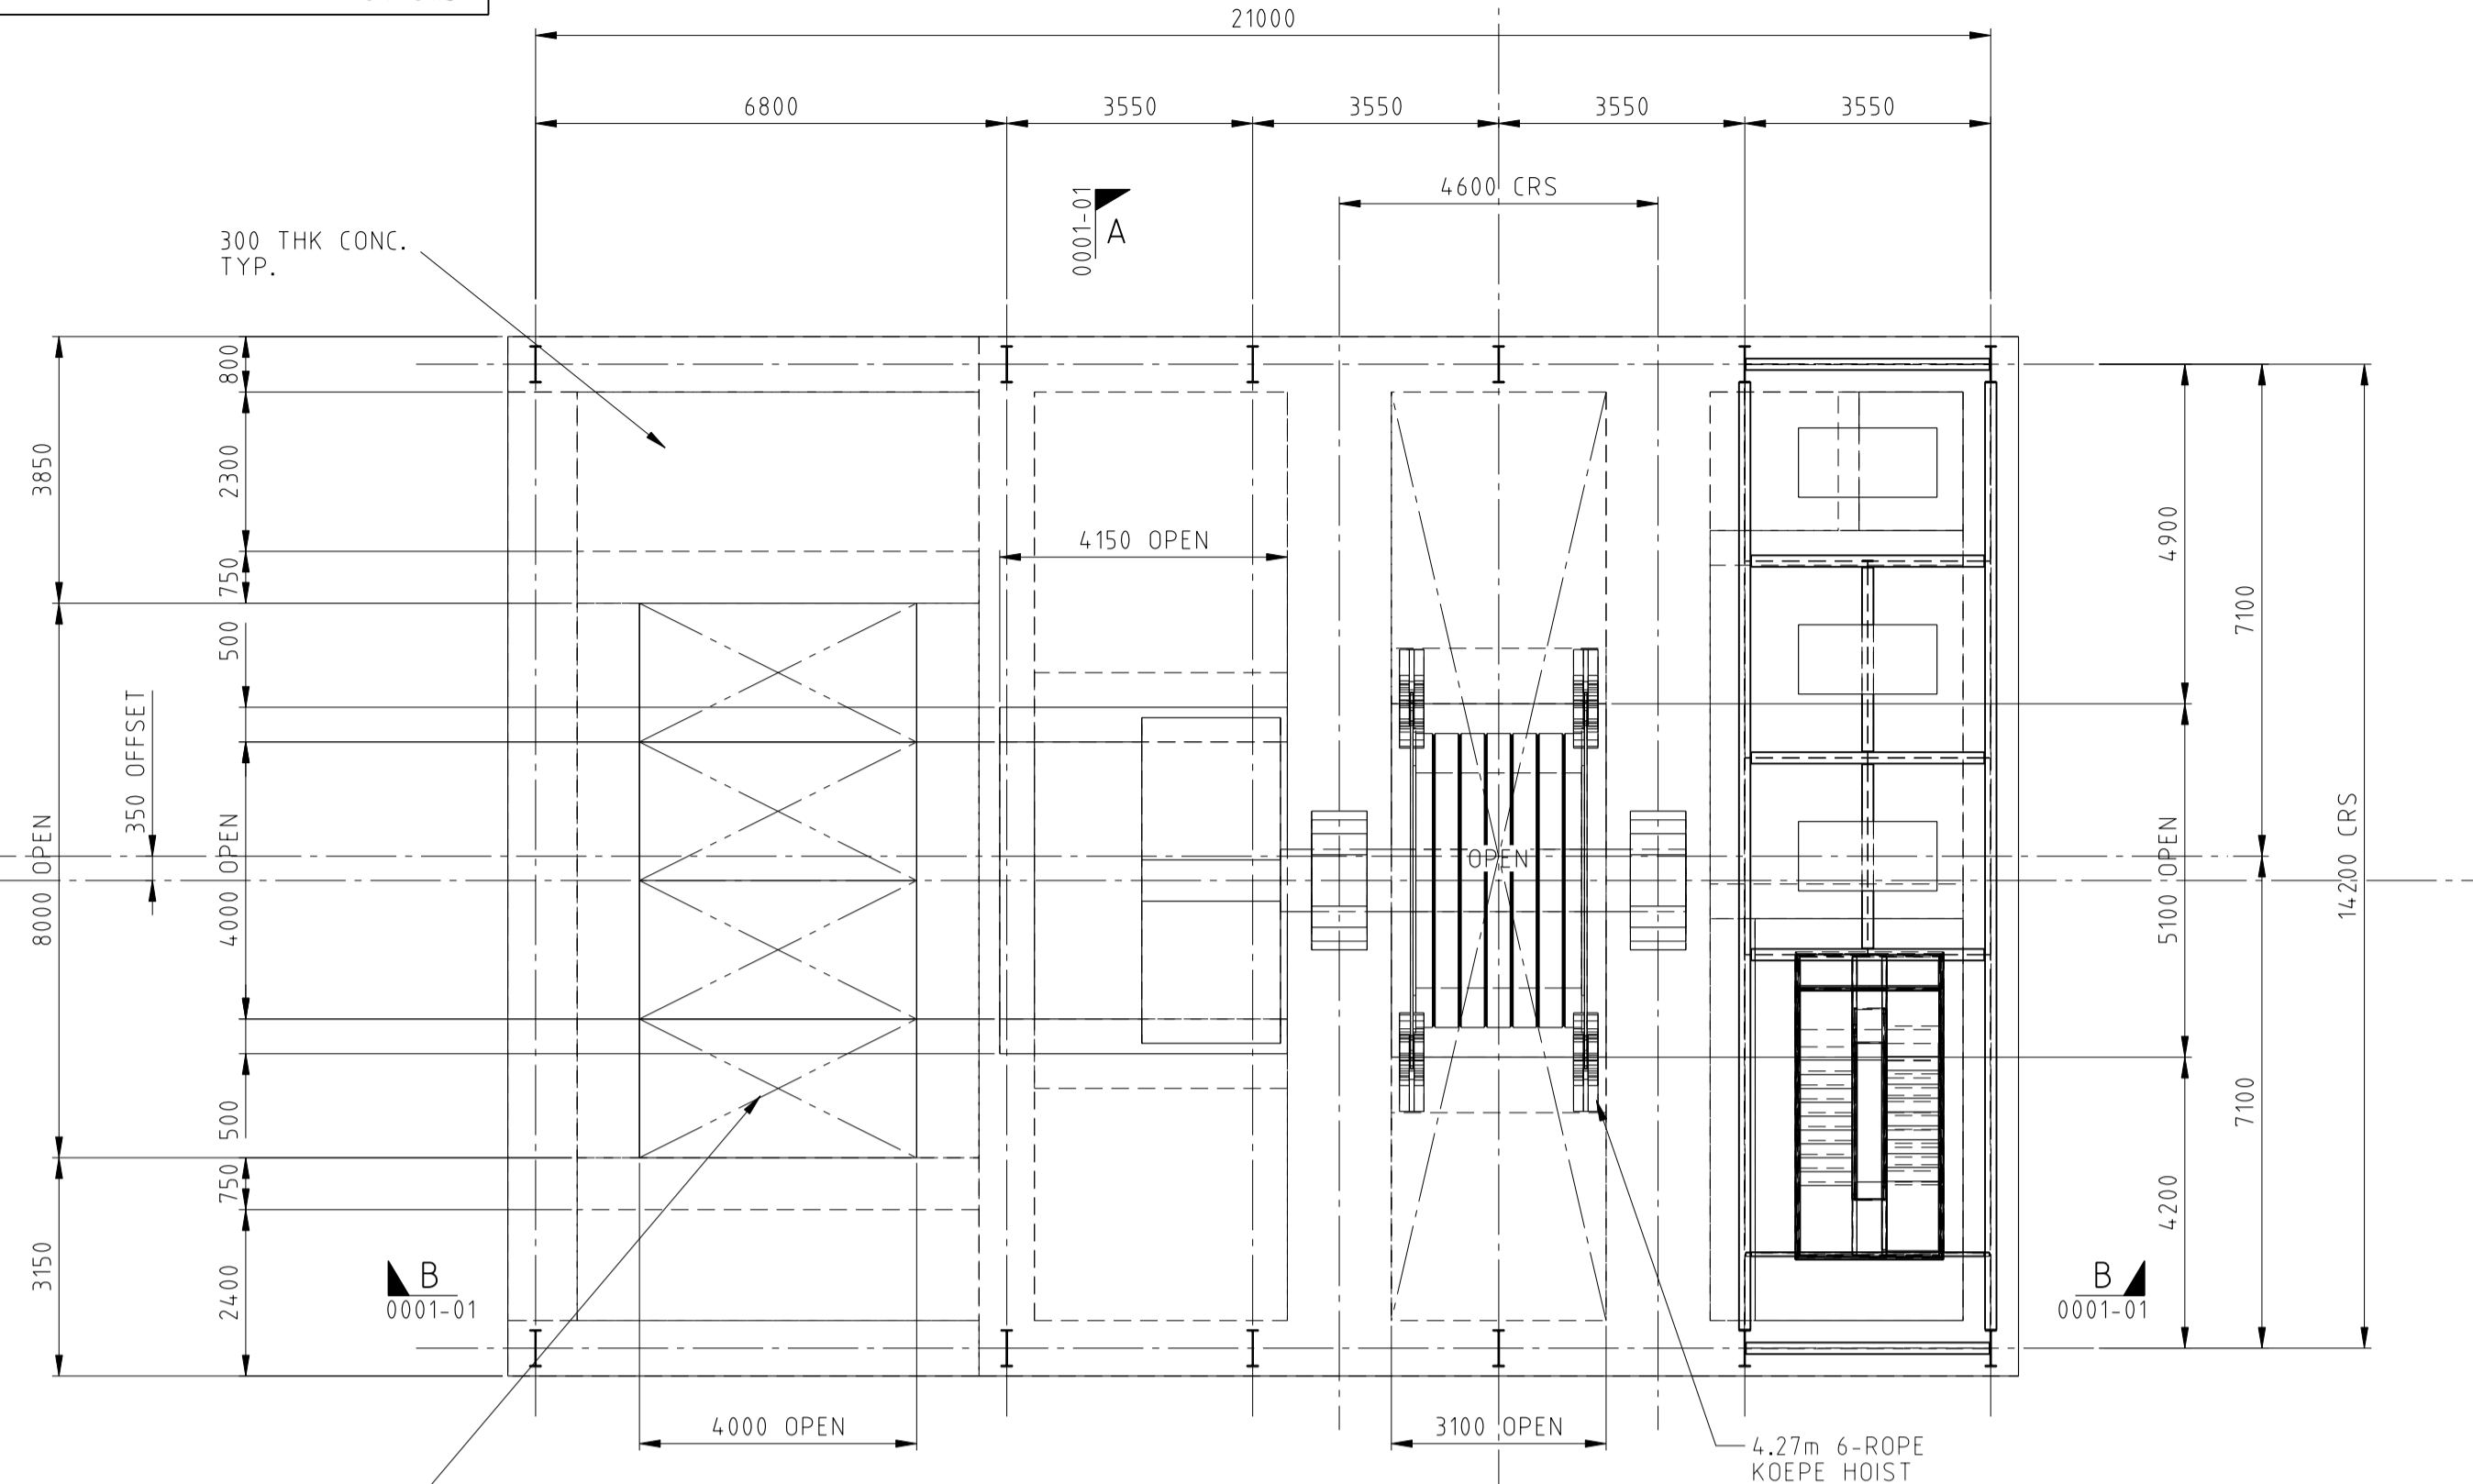

KEY PLAN
NTS

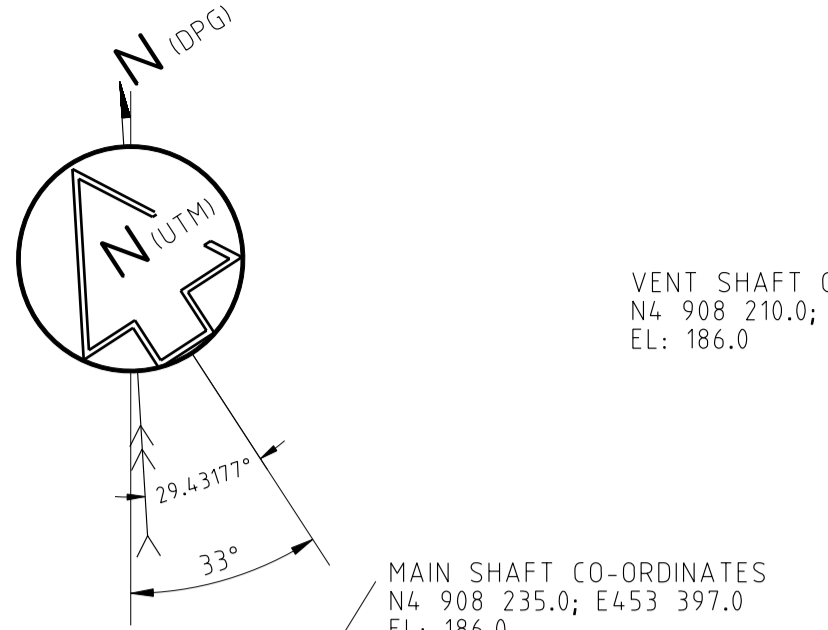

PLAN D-D (WP406-30-042-0001-01)
SCALE 1:100

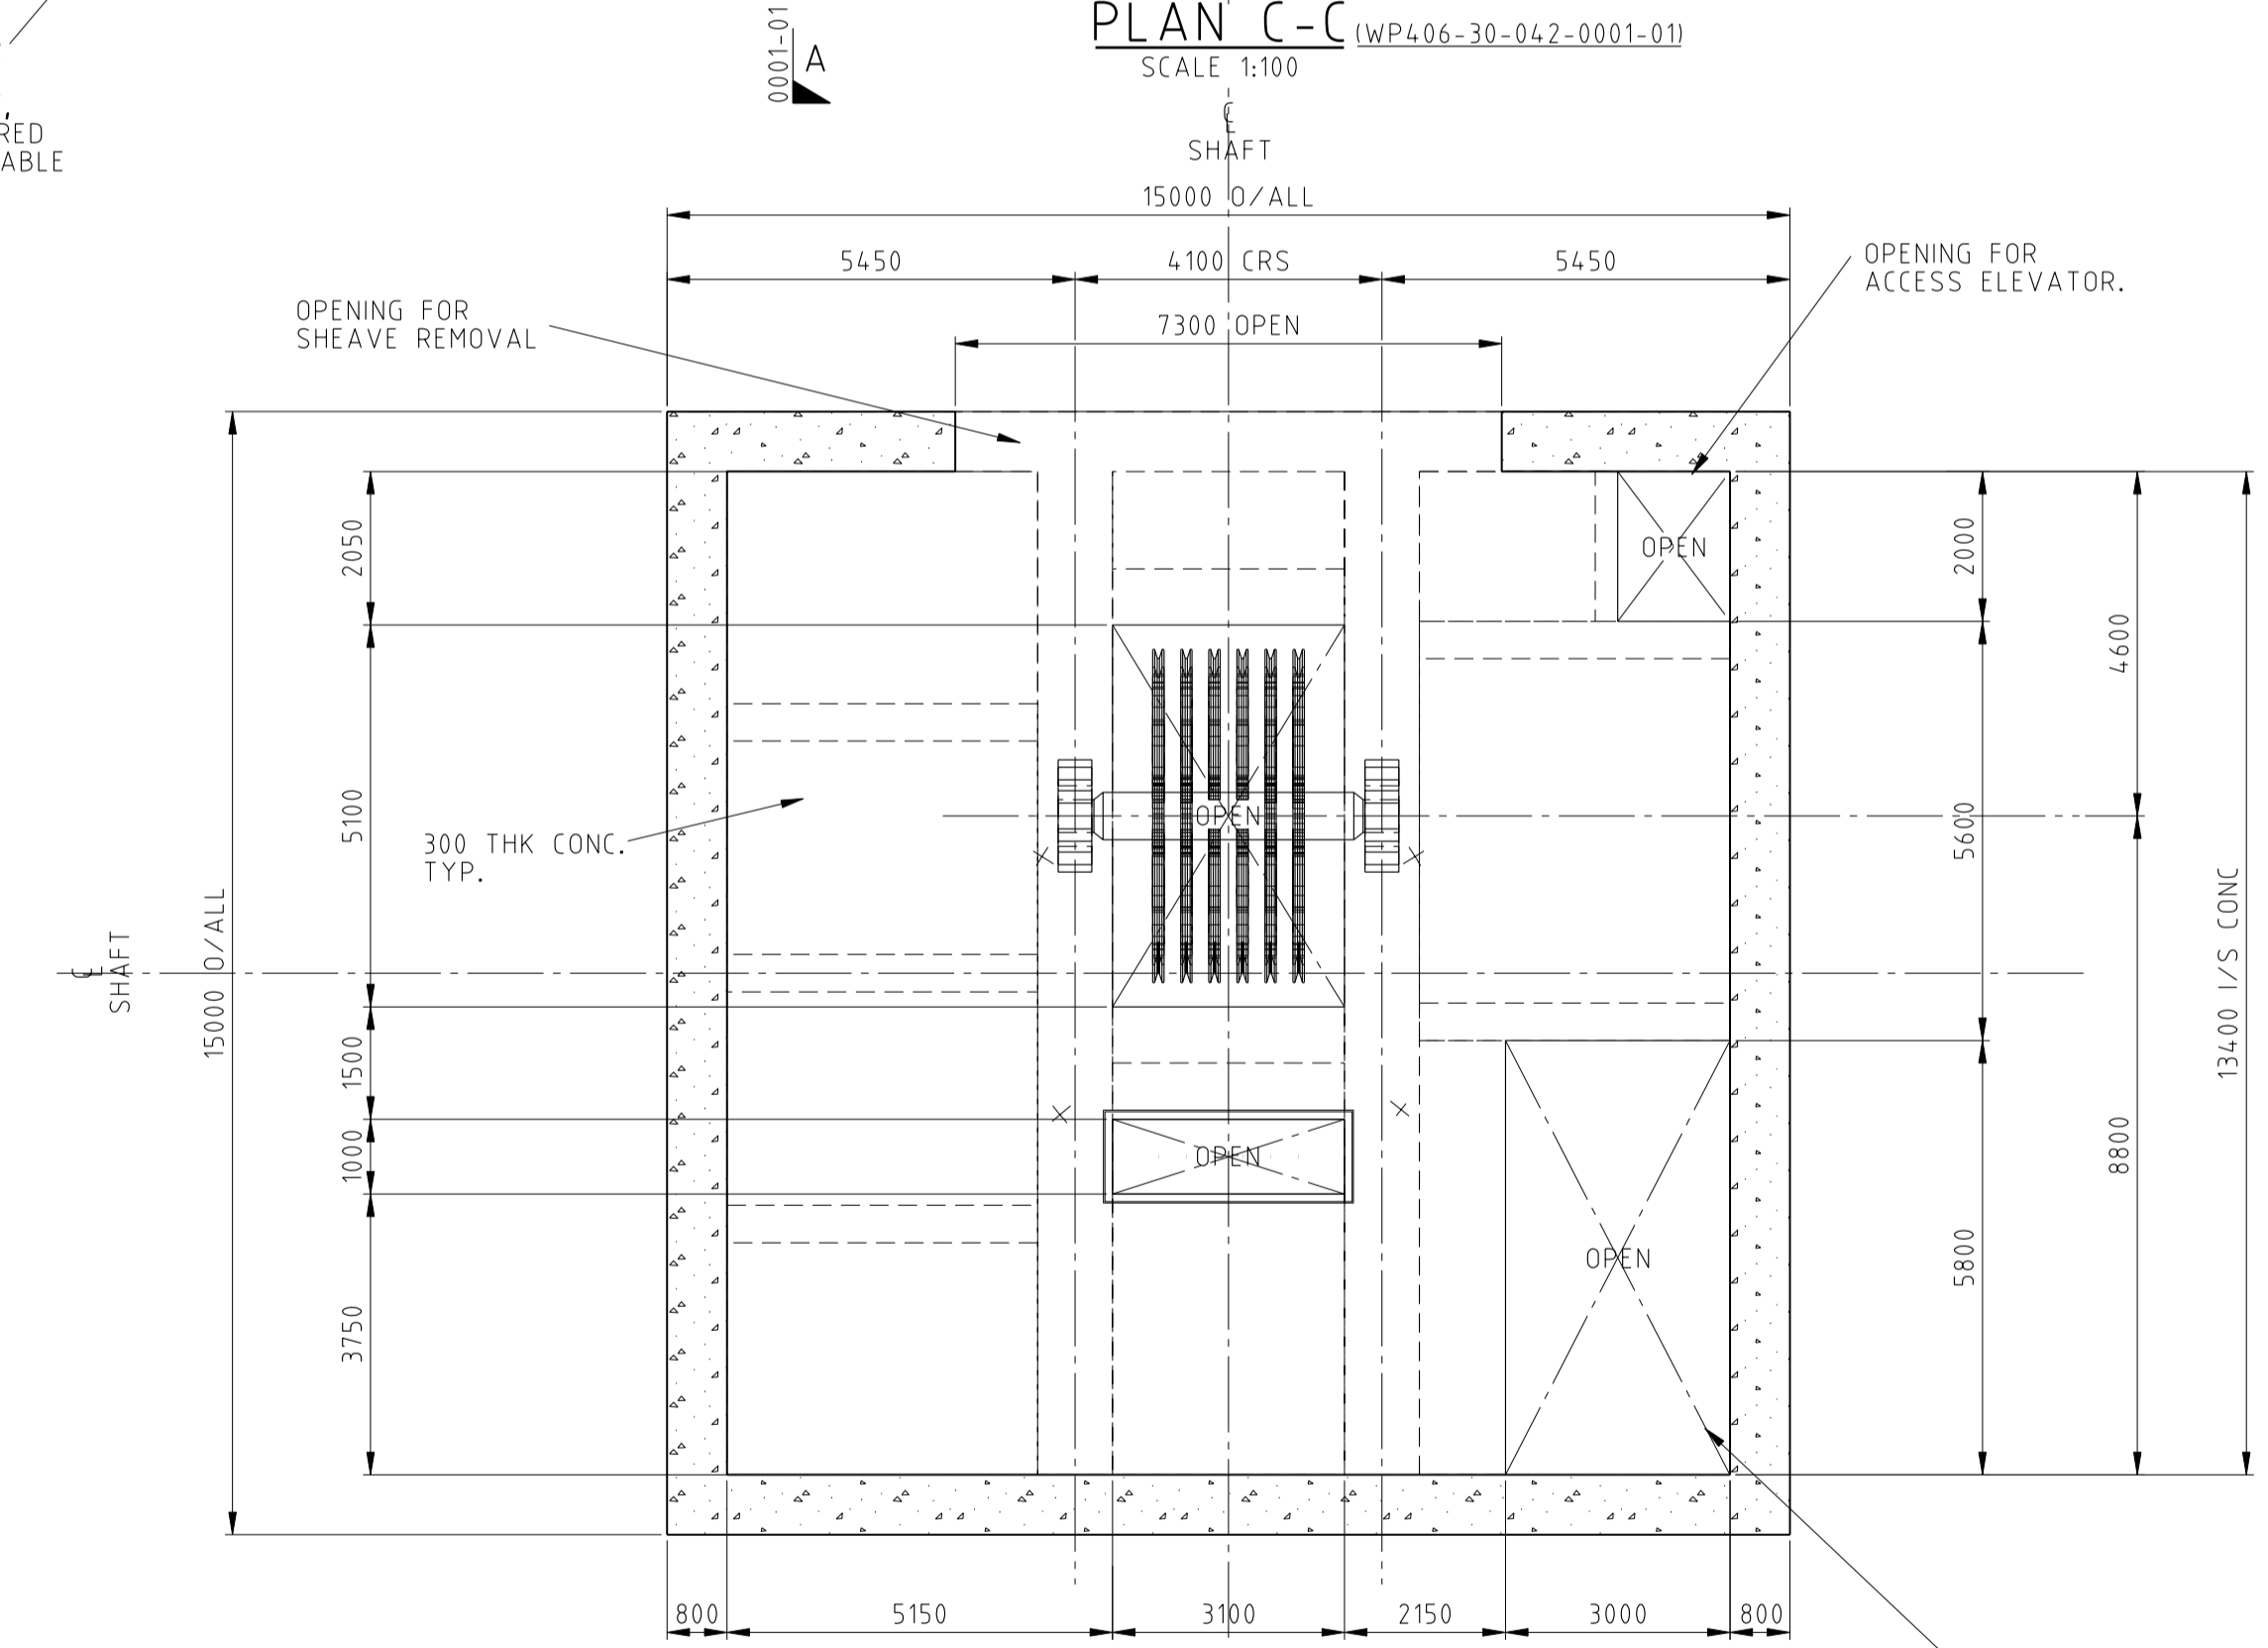

PLAN E-E (WP406-30-042-0001-01)
SCALE 1:100

PRELIMINARY

DRAWING NO.	H333000-WP406-20-042-0002
DRAWING TITLE	HEADFRAMES MAIN SHAFT CONCRETE HEADFRAME FLOOR PLANS
REFERENCE DRAWINGS	

NO.	DESCRIPTION	CHK'D	APP'D	DATE

NOT FOR CONSTRUCTION
This drawing has been reviewed for the purposes of DGR Preliminary Engineering only and must not be used for other purposes.
Work Package Owner
Stephen Keen

Area Lead
G.R. Davidge
Digitally signed by G.R. Davidge
Date: 2009.12.11 11:48:09 -0500

Engineering Manager
Sherwin Aaron
2009.12.11 13:20:54 -0500

Project Manager
M. Dawborn
Digitally signed by M. Dawborn
Date: 2009.12.11 13:41:24 -0500

Accepted by Owner
Deane Wilson
Digitally signed by Deane Wilson
DN: cn=Deane Wilson, o=ARMIS, ou=ARMIS-Design
Date: 2009.12.14 10:22:35 -0500

HATCH





DESIGNED BY N. HENDERSON DATE 05/11/09	DRAWN BY R. LABUSCHAGNE DATE 2009-11-05
CHECKED BY	DISCIPLIN. ENGR.
DATE PROJ. DES. COORD.	DATE PROJ. ENGR.

NUCLEAR WASTE MANAGEMENT ORGANIZATION
DEEP GEOLOGIC REPOSITORY PROJECT

HEADFRAMES

MAIN SHAFT
CONCRETE HEADFRAME
FLOOR PLANS

SCALE 1:100 OR AS NOTED	DWG. NO. H333000-WP406-20-042-0002	REV. 00
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PRELIMINARY

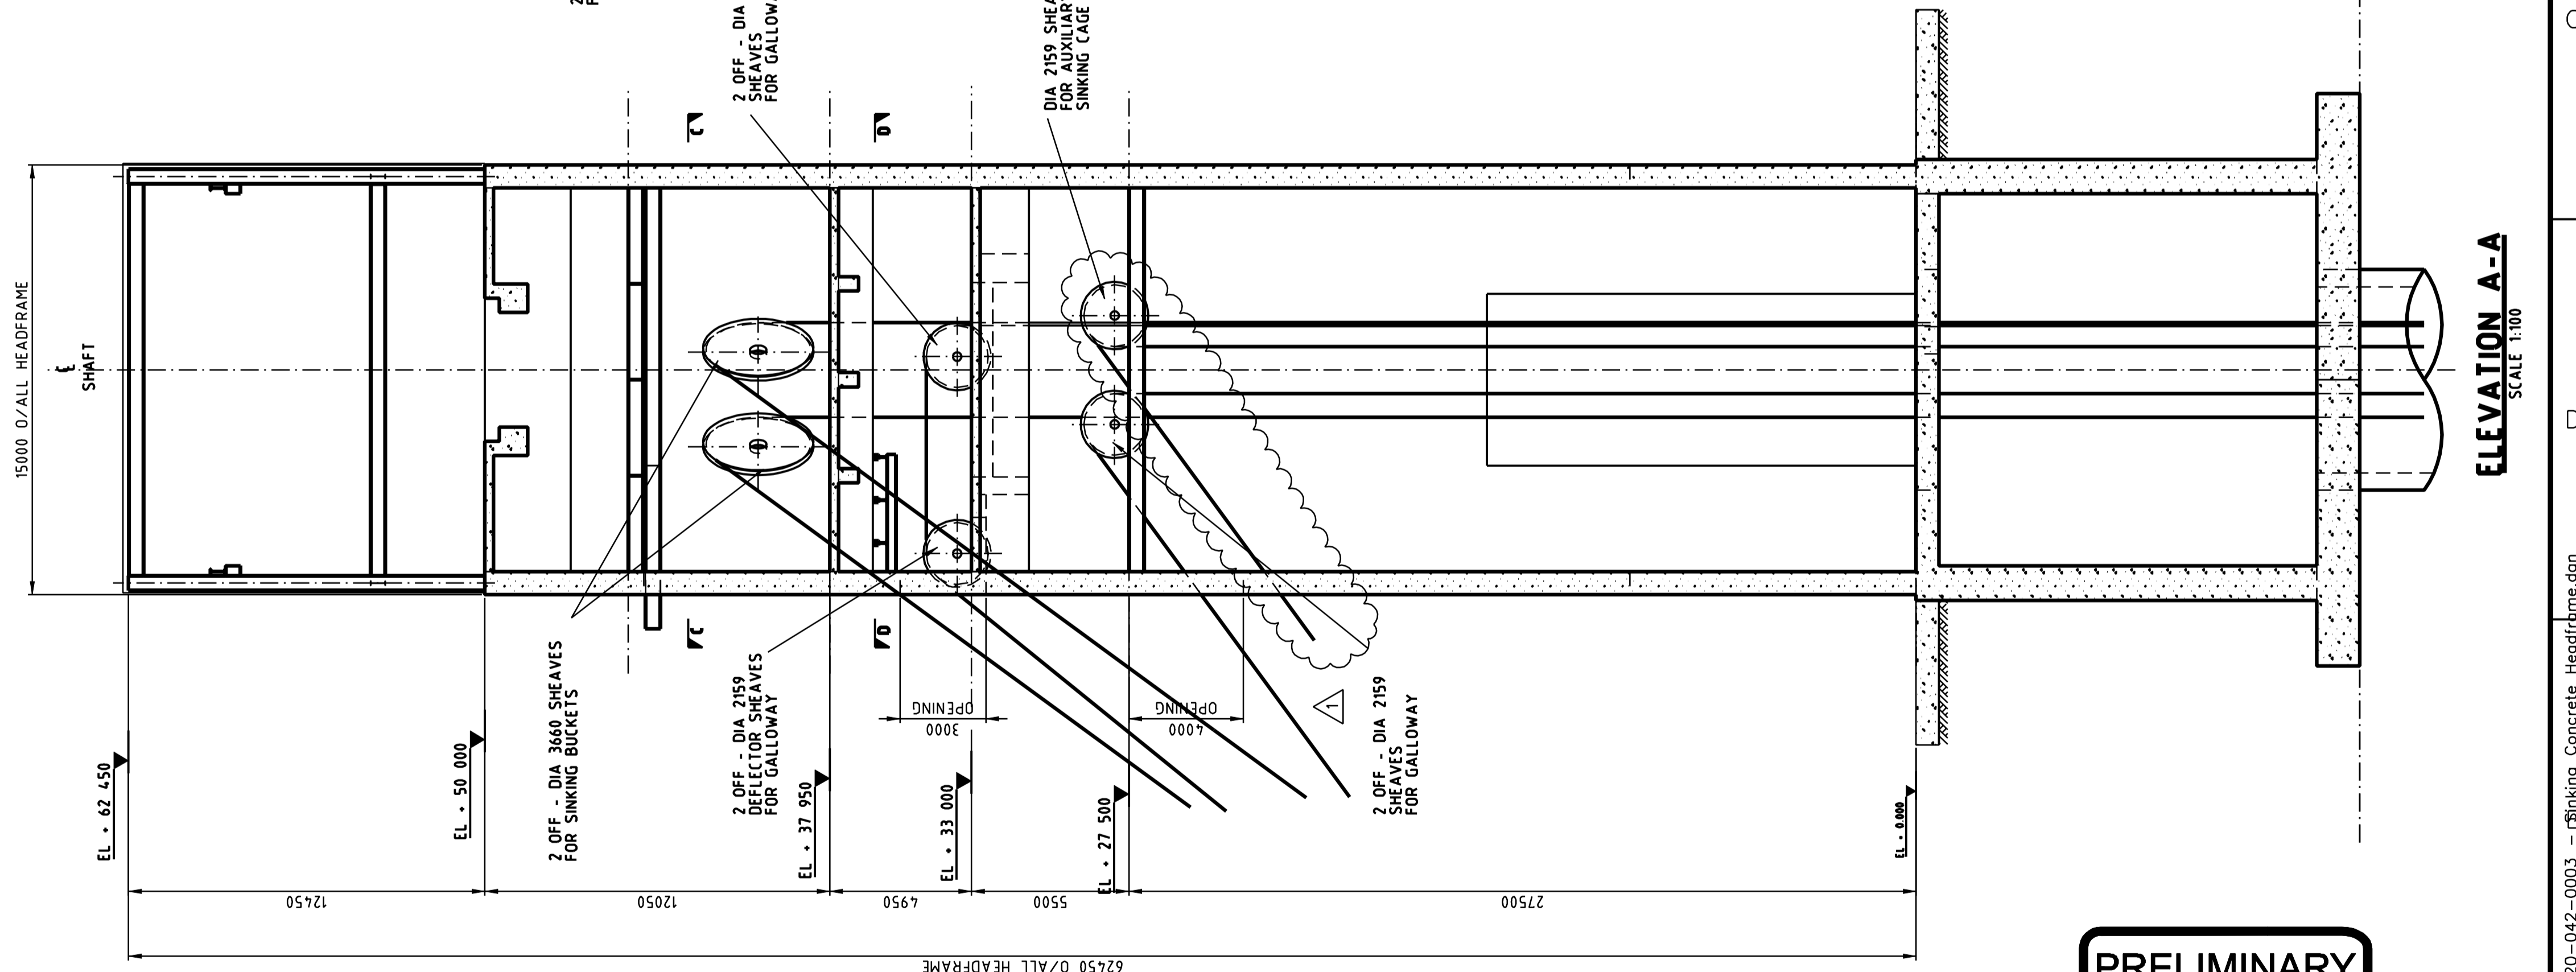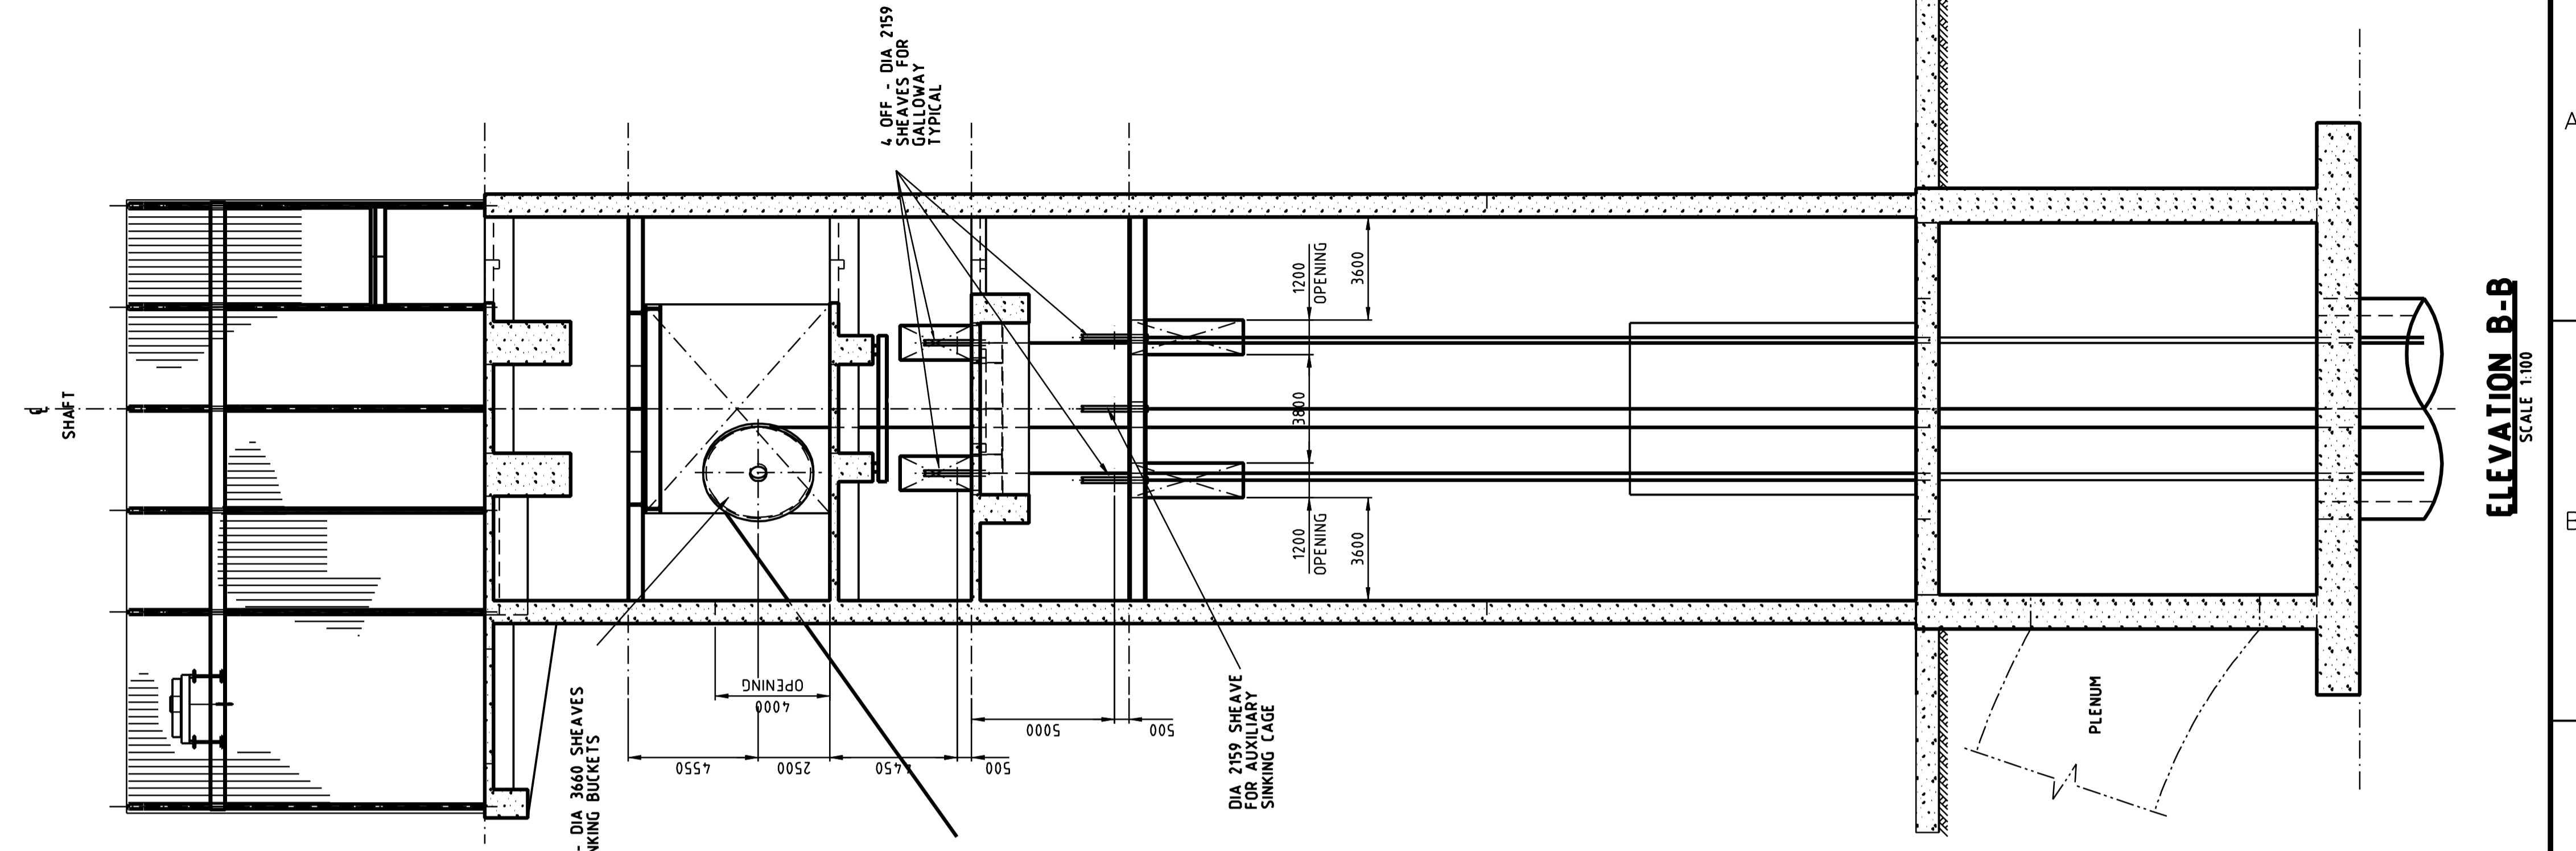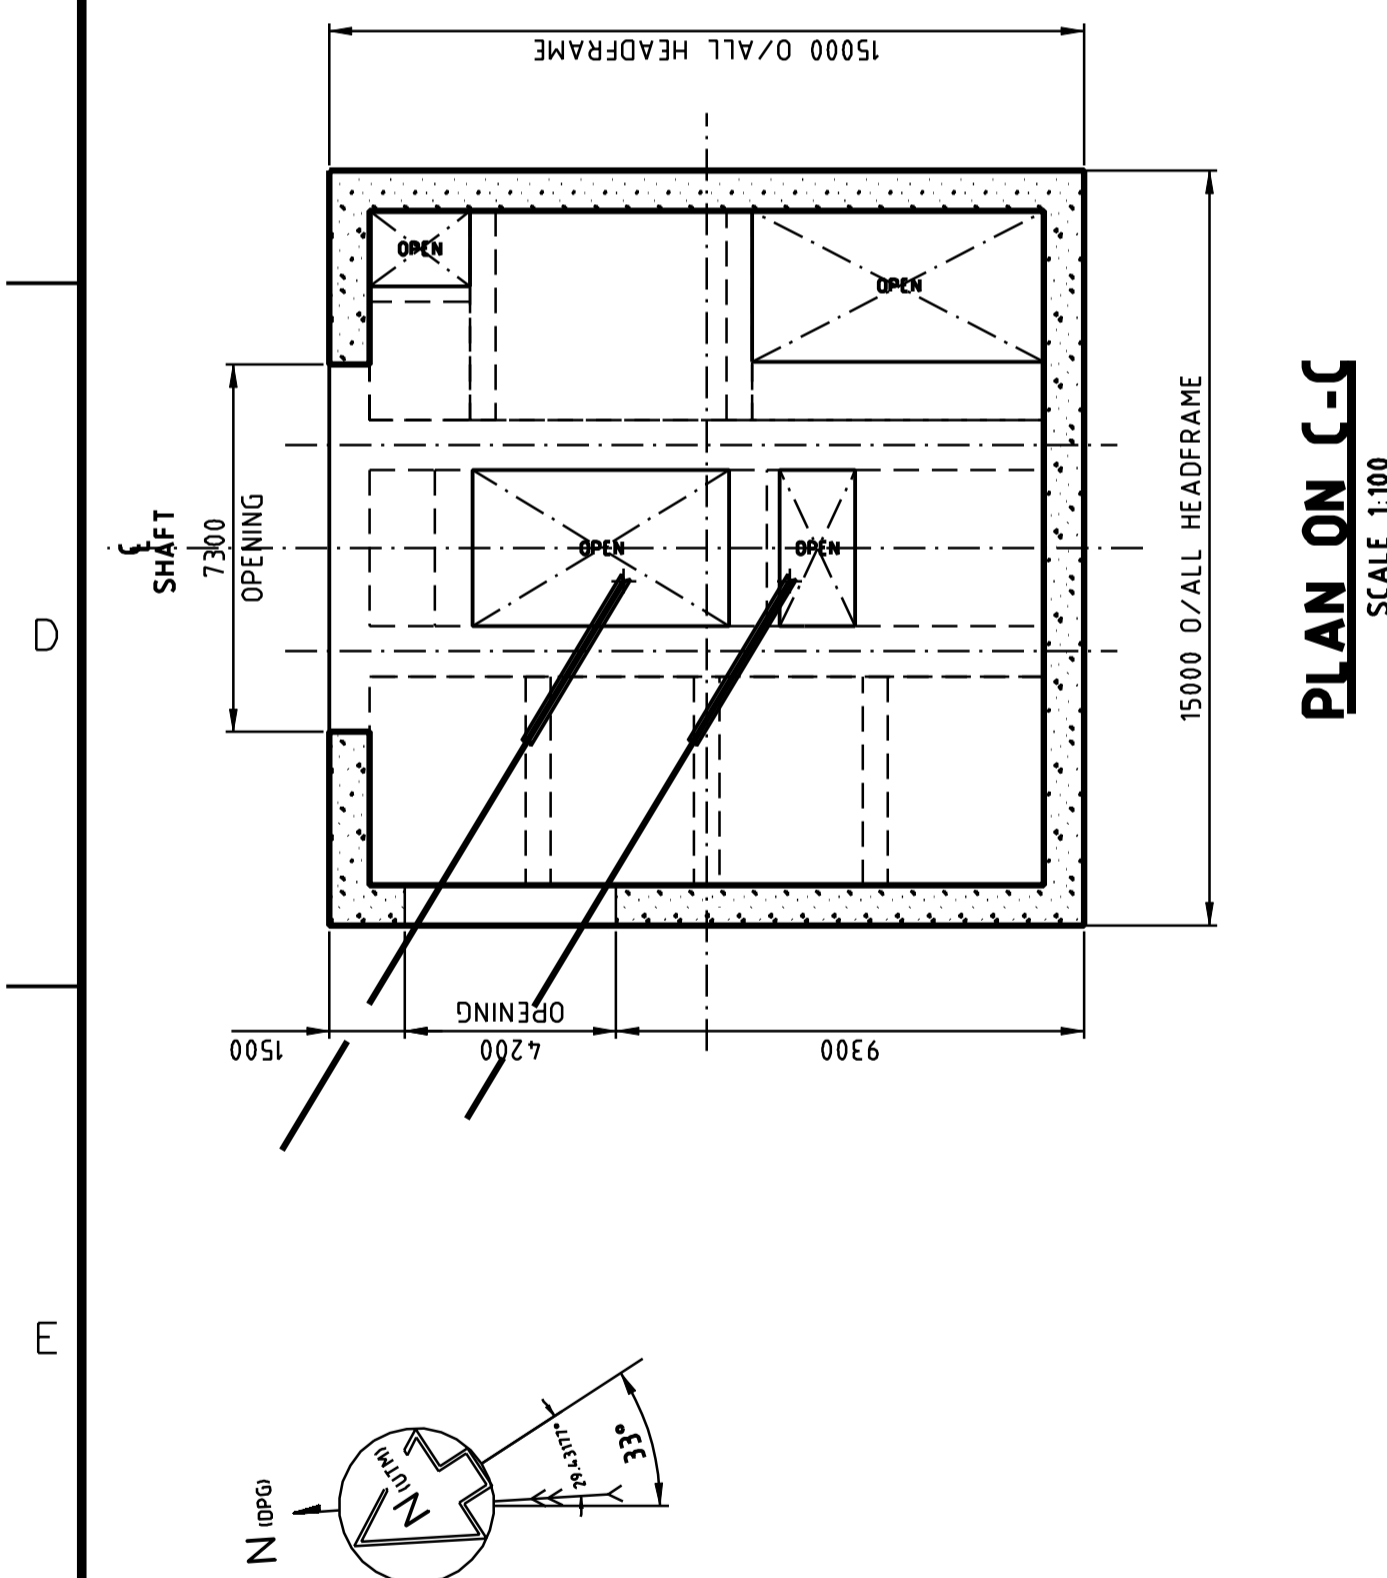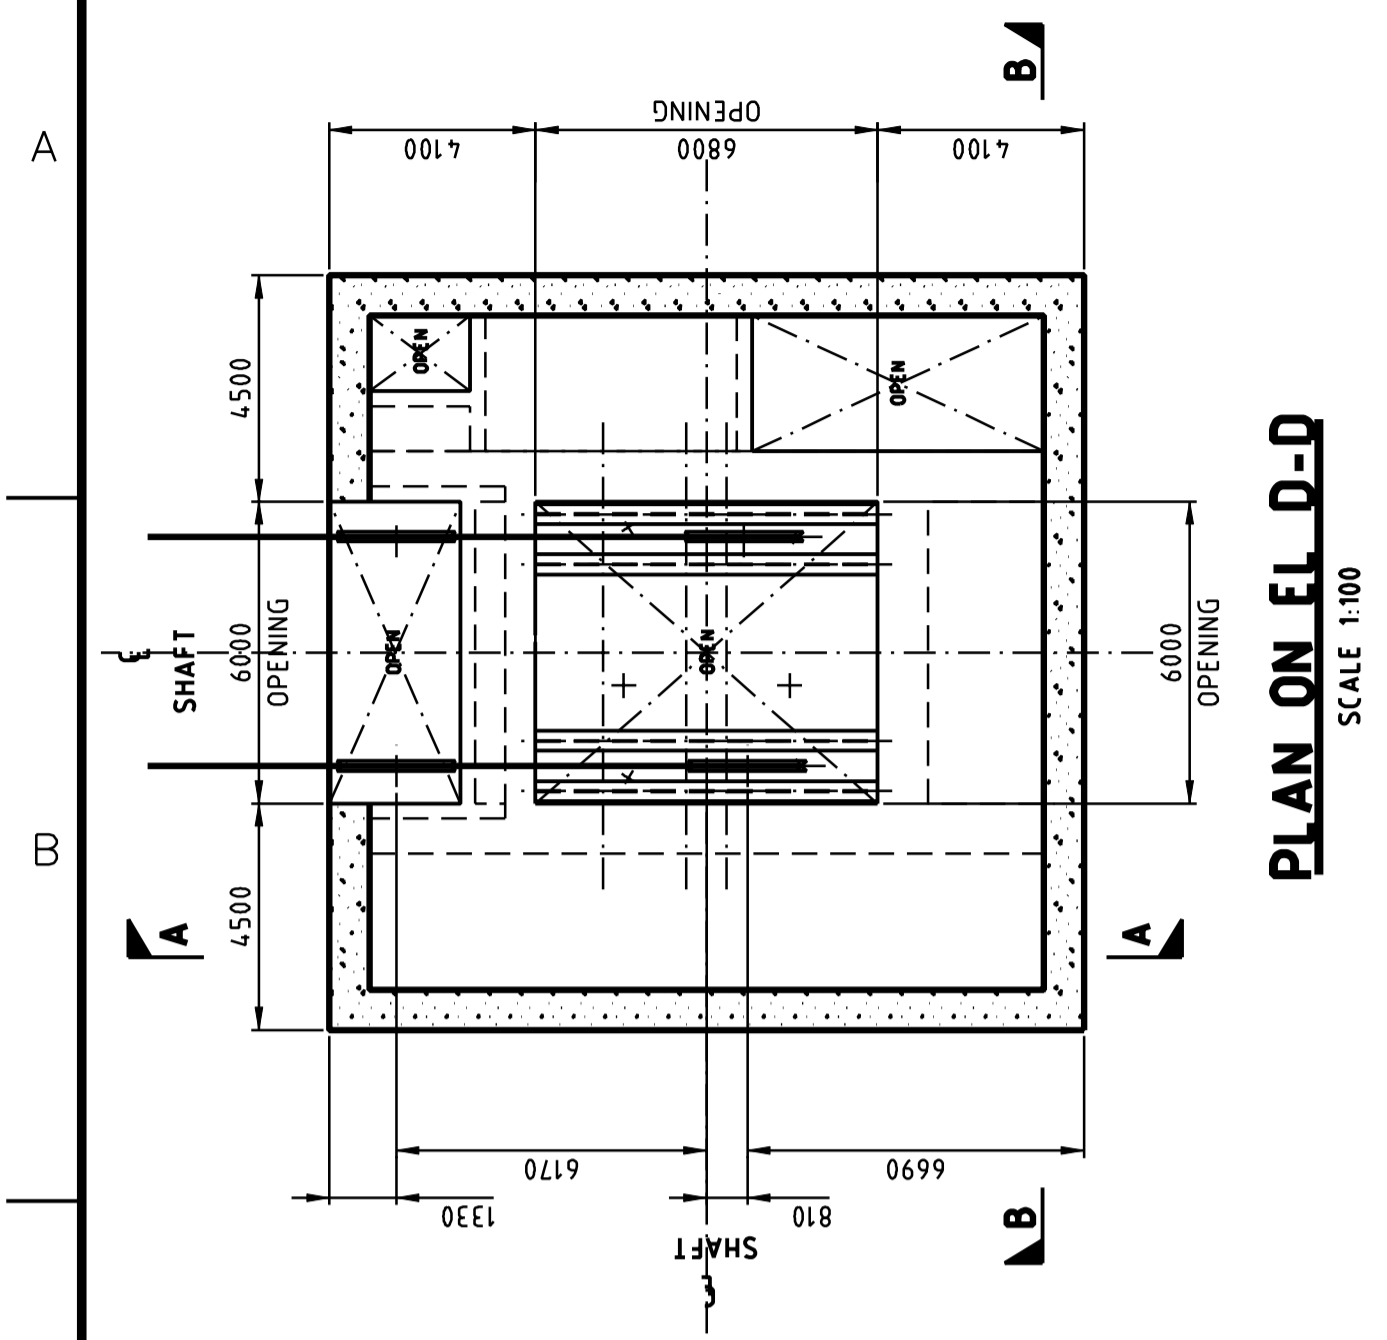NO.	DESCRIPTION	CHK'D	APP'D	DATE
01	ROPE LINES DIRECTIONS CHANGED			

NO.	DESCRIPTION	CHK'D	APP'D	DATE
01	APPROVED FOR USE	GRD	SAA	01/03/10
00	APPROVED FOR USE	GRD	ISAA	12/01/10

REV.	ISSUE FOR	AUTH. BY	DATE	
01	APPROVED FOR USE	GRD	SAA	01/03/10
00	APPROVED FOR USE	GRD	ISAA	12/01/10

DESIGNED BY	DRAWN BY
S. LO DRAGO	R. LABUSCHAGNE
DATE 2009-12-08	DATE 2009-11-27
CHECKED BY	DISCIP. ENGR.
DATE	DATE
PROJ. DES. COORD.	PROJ. ENGR.
DATE	DATE
PROJ. MGR.	DATE
M. DAWBORN	DATE 2009-12-08

SCALE	DWG. NO.	REV.
1:150 OR AS NOTED	H333000-WP406-20-042-0003	01

NO.	DESCRIPTION	CHK'D	APP'D	DATE
01	ROPE LINES DIRECTIONS CHANGED			



NO.	DESCRIPTION	CHK'D	APP'D	DATE
01	ROPE LINES DIRECTIONS CHANGED			

NOT FOR CONSTRUCTION
This drawing has been reviewed for the purposes of DGR Preliminary Engineering only and must not be used for other purposes.
Work Package Owner
Stephen Keen
Approved by Owner


DESIGNED BY	DRAWN BY
S. LO DRAGO	R. LABUSCHAGNE
DATE 2009-12-08	DATE 2009-11-27
CHECKED BY	DISCIP. ENGR.
DATE	DATE
PROJ. DES. COORD.	PROJ. ENGR.
DATE	DATE
PROJ. MGR.	DATE
M. DAWBORN	DATE 2009-12-08

01	APPROVED FOR USE	GRD	SAA	01/03/10
00	APPROVED FOR USE	GRD	ISAA	12/01/10


HATCH			NUCLEAR WASTE MANAGEMENT ORGANIZATION DEEP GEOLOGIC REPOSITORY PROJECT		
HEADFRAMES					
MAIN SHAFT HEADFRAME - SINKING CONDITION GENERAL ARRANGEMNT					
SCALE 1:150 OR AS NOTED	DWG. NO. H333000-WP406-20-042-0003	REV. 01			

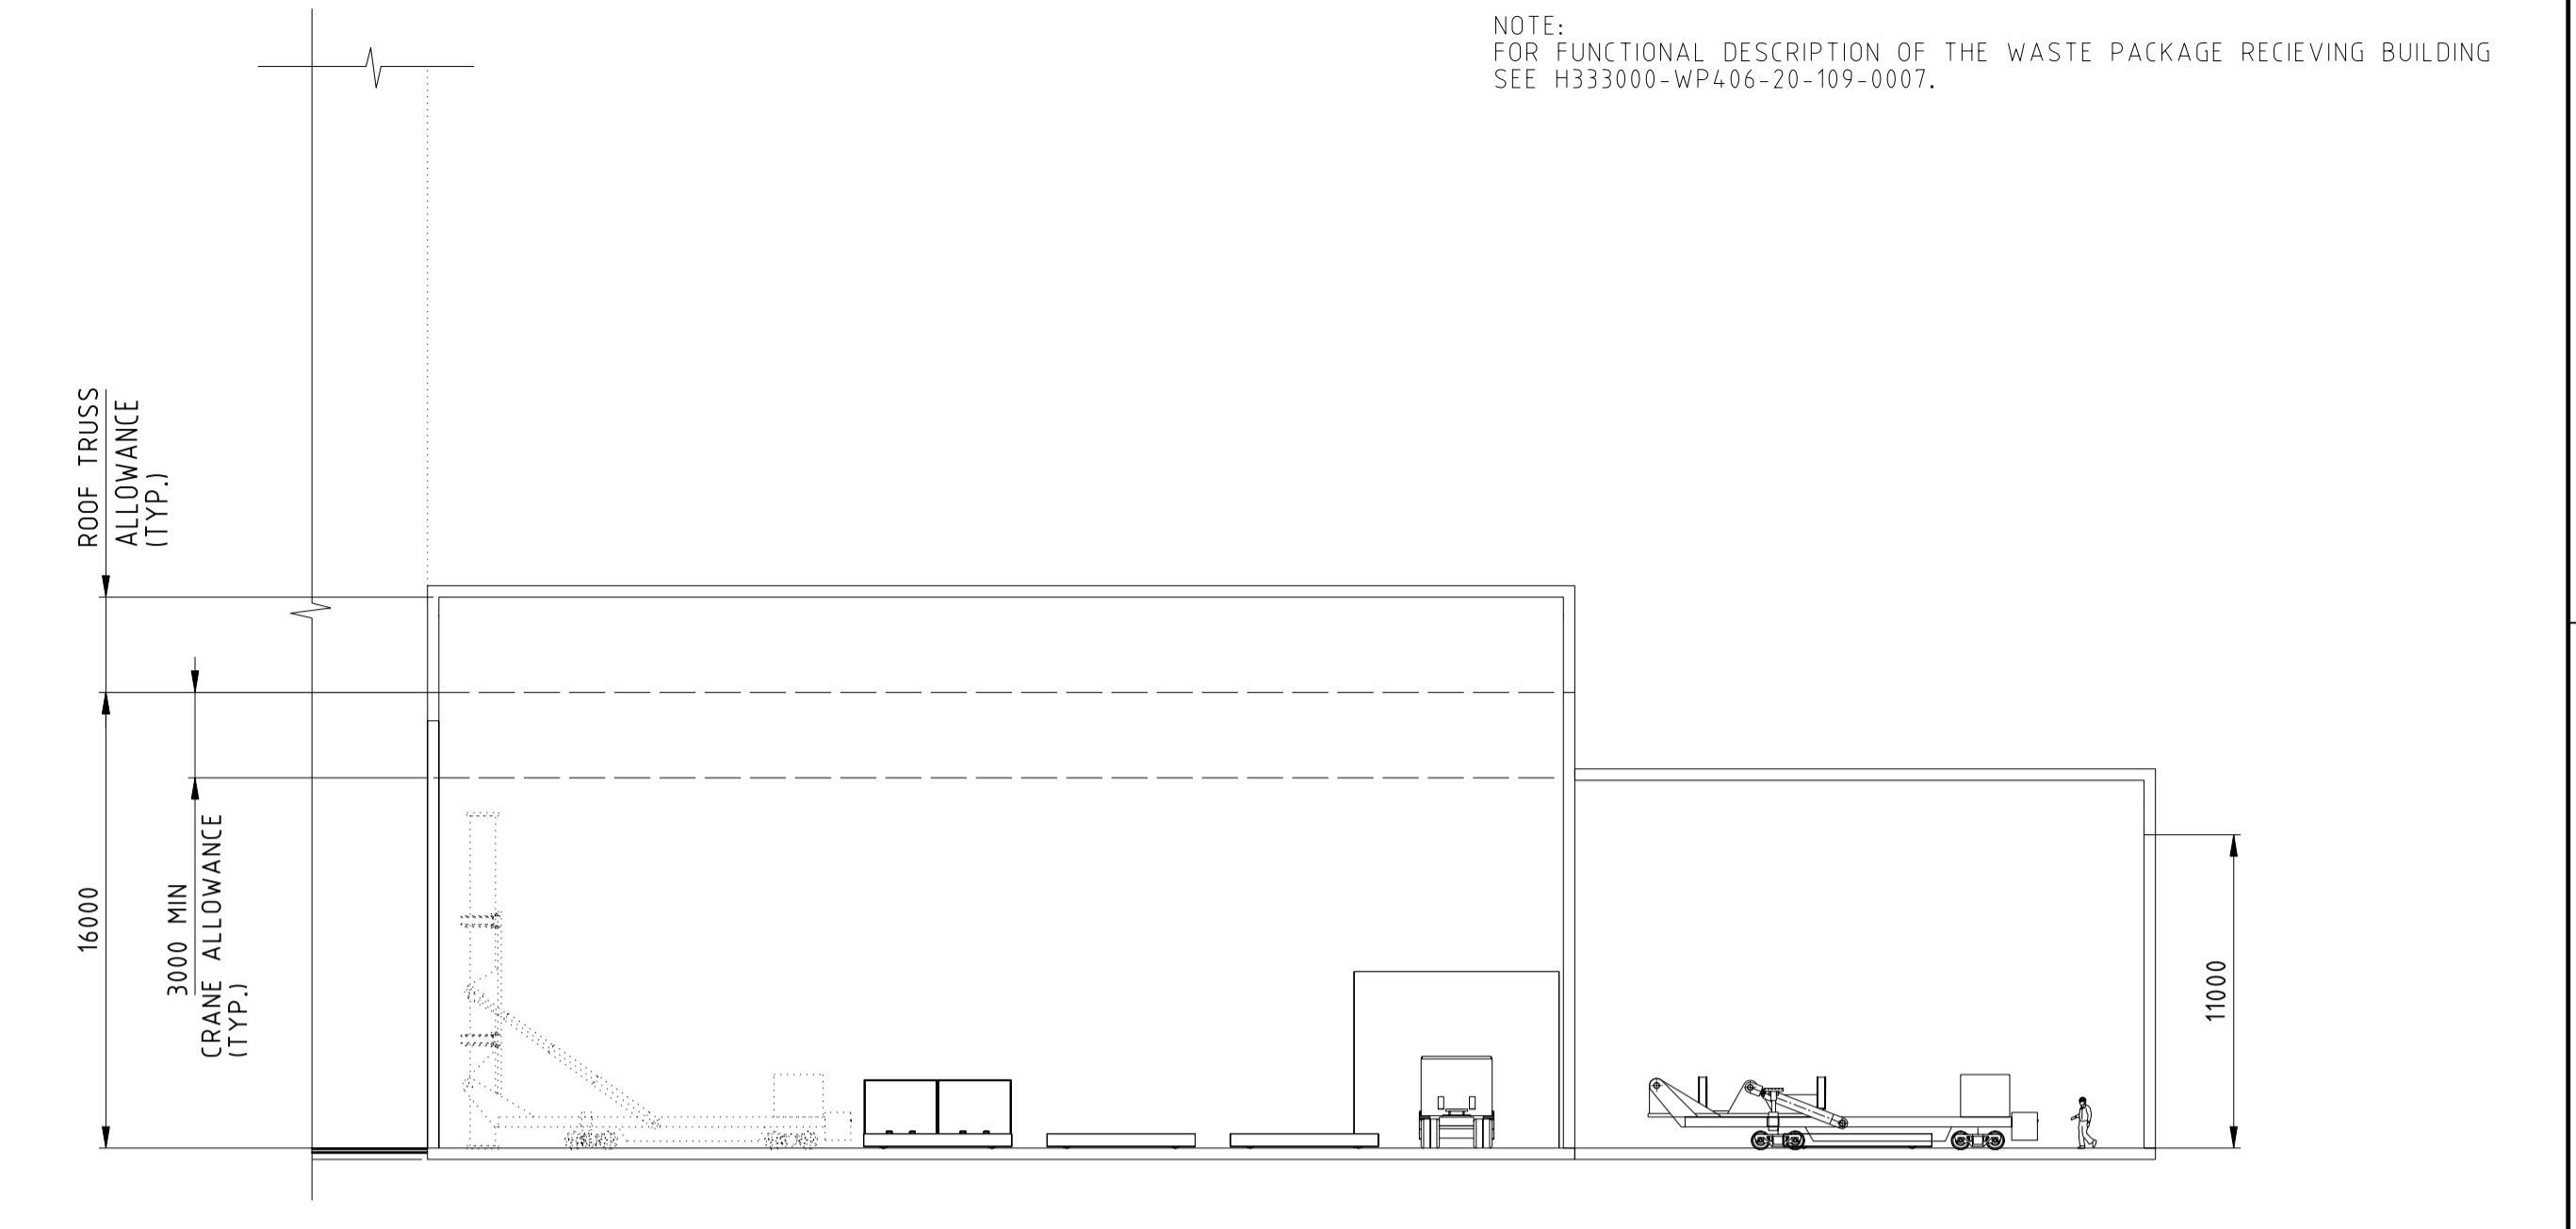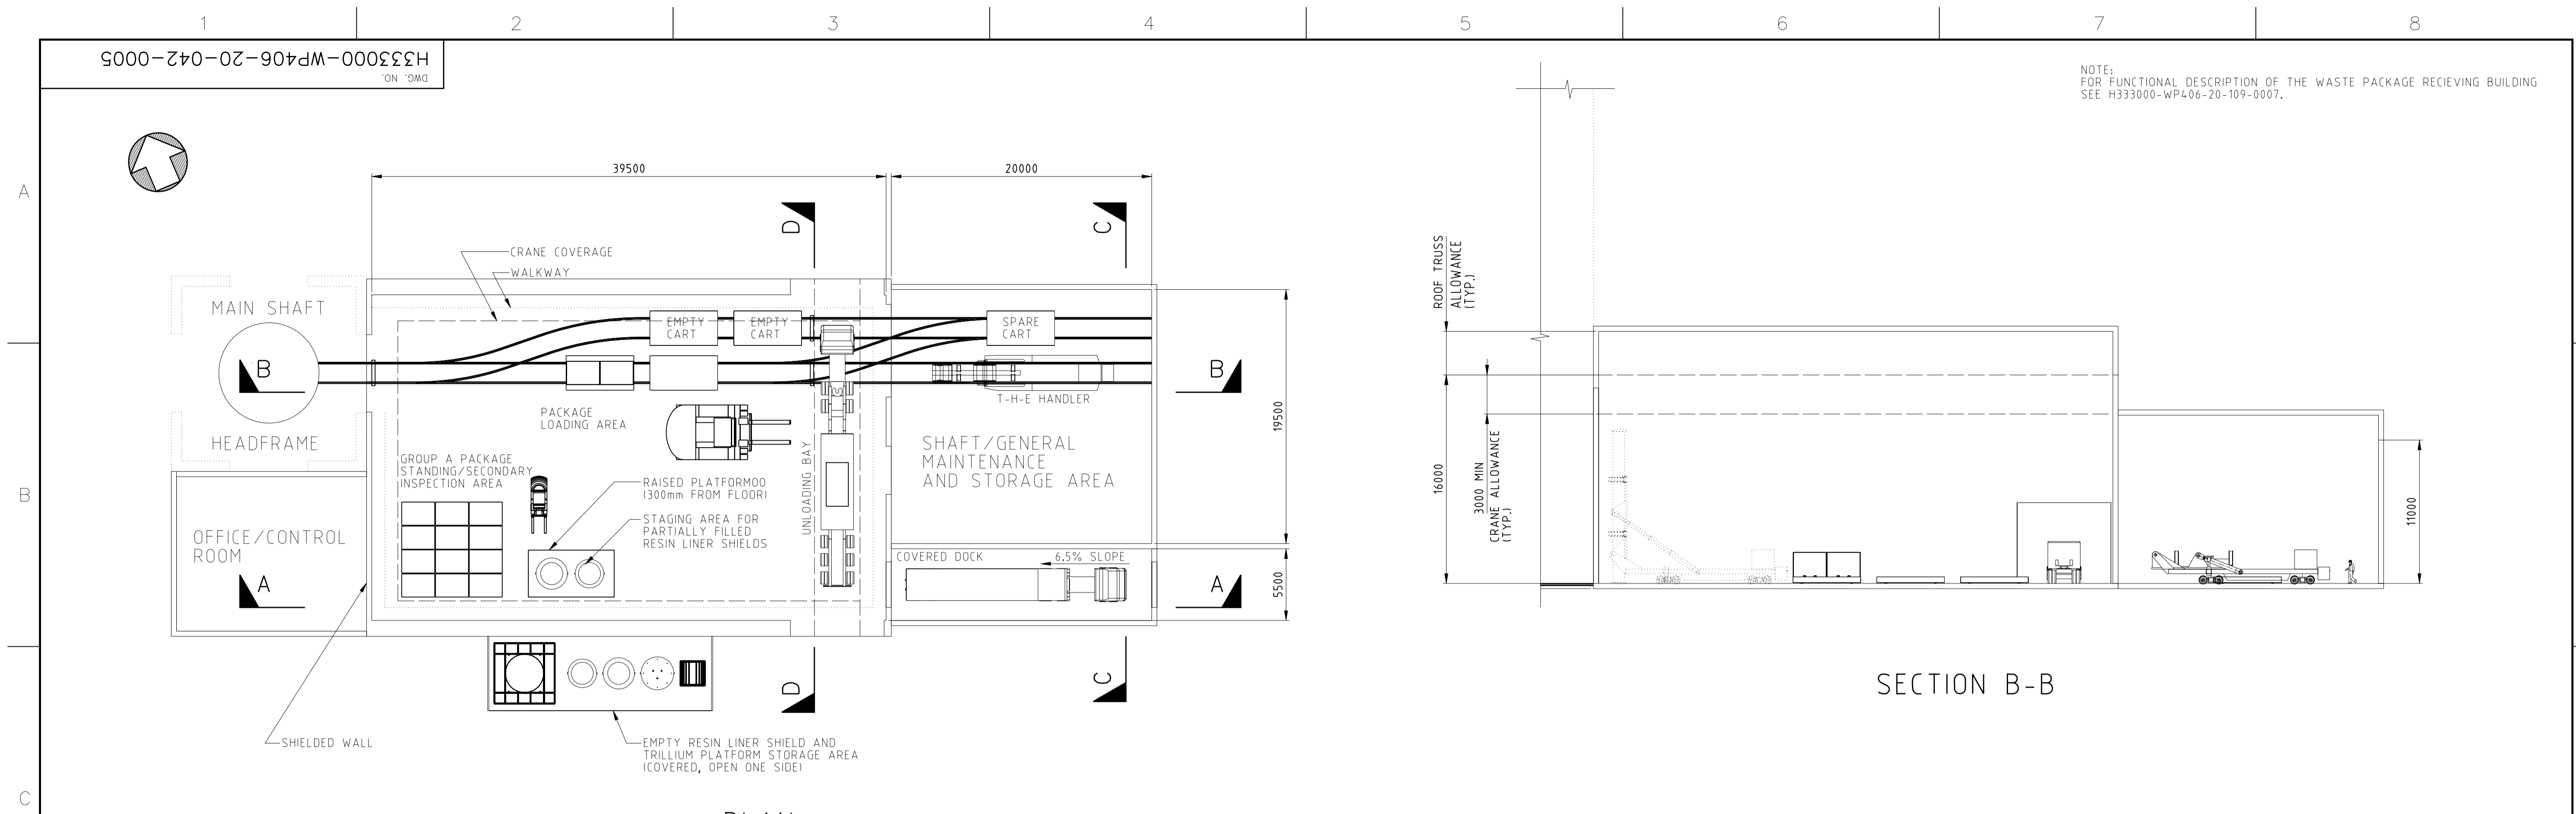


SECTION B-B

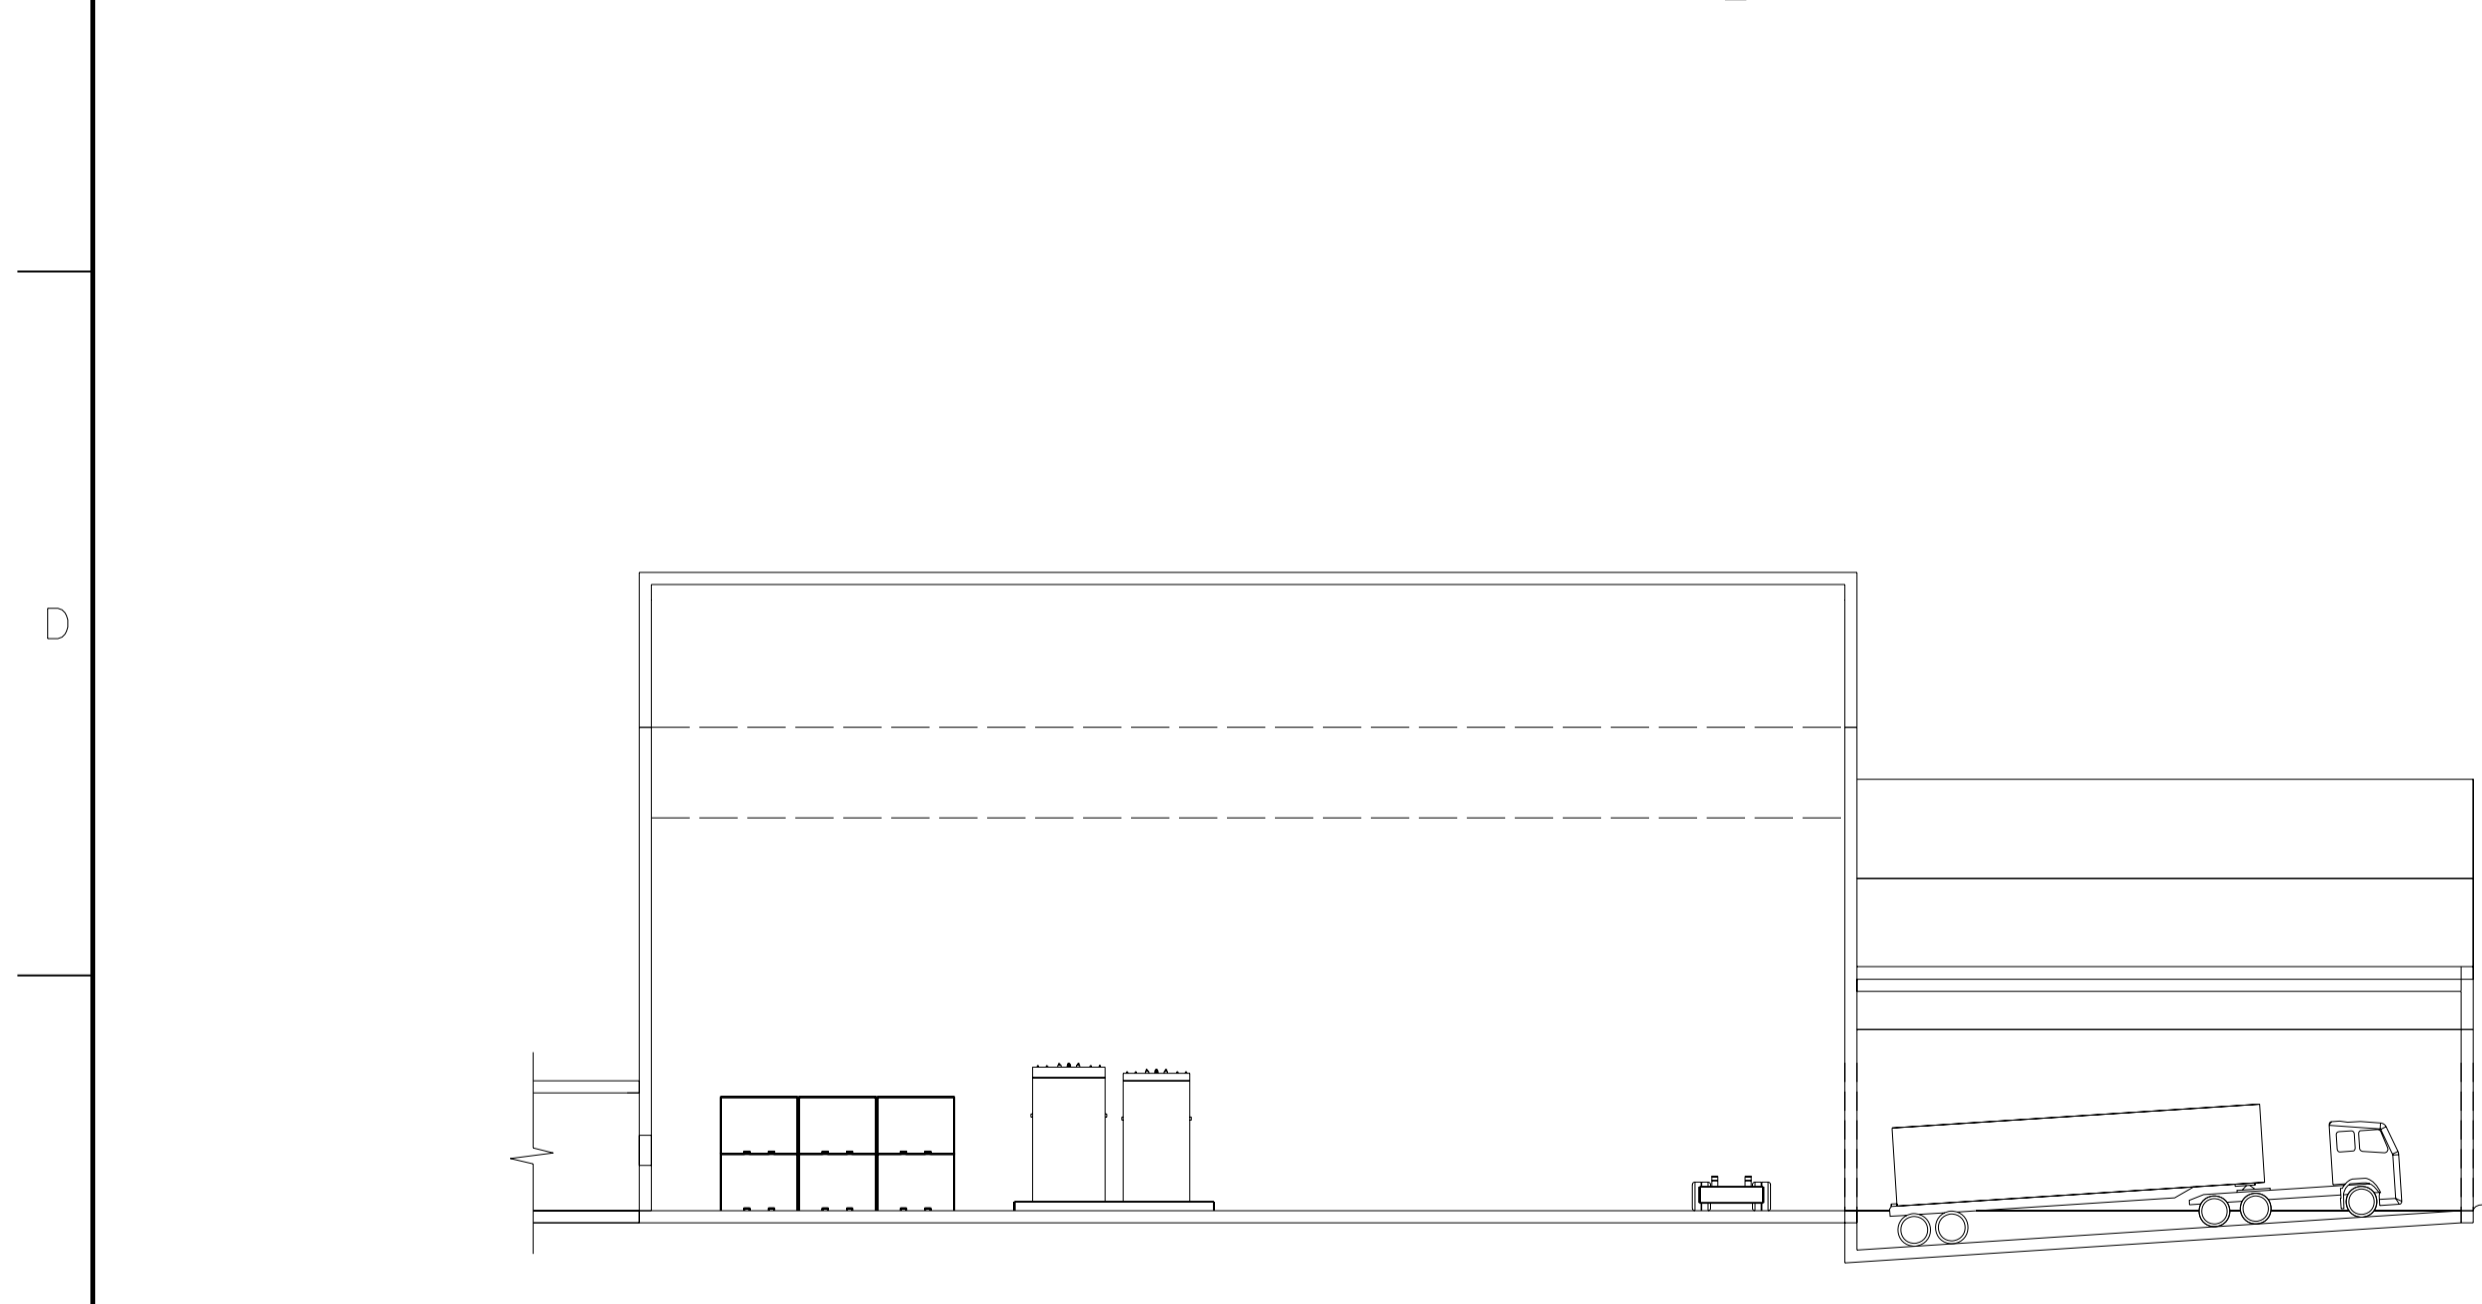

SECTION A-A

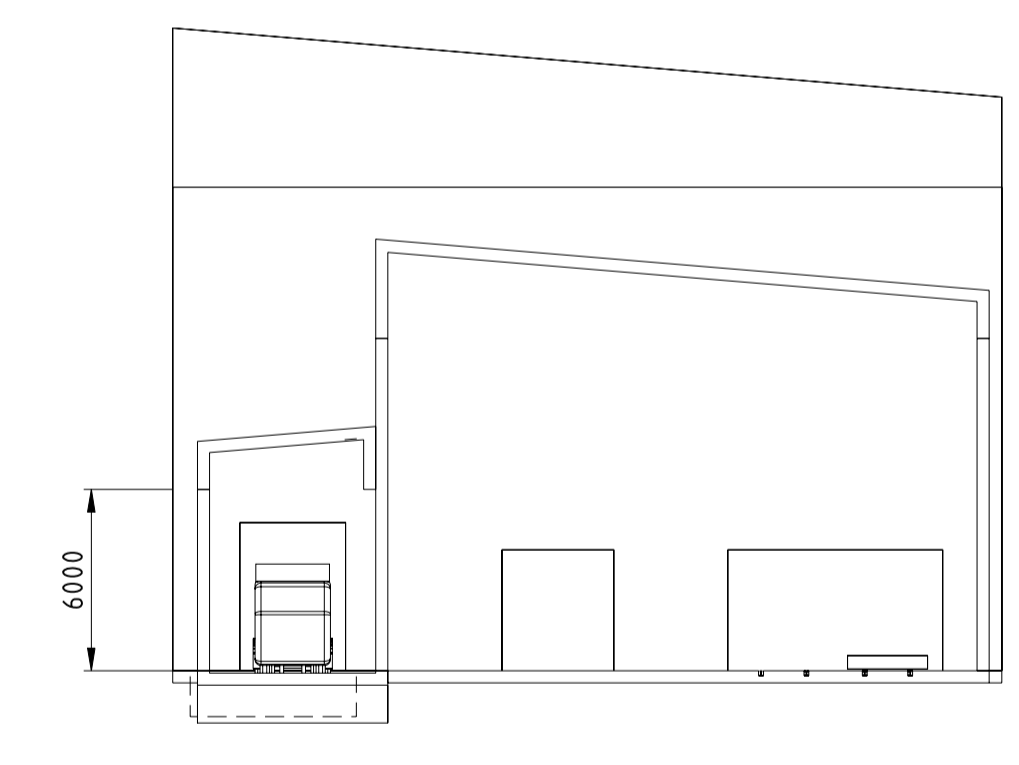

SECTION C-C

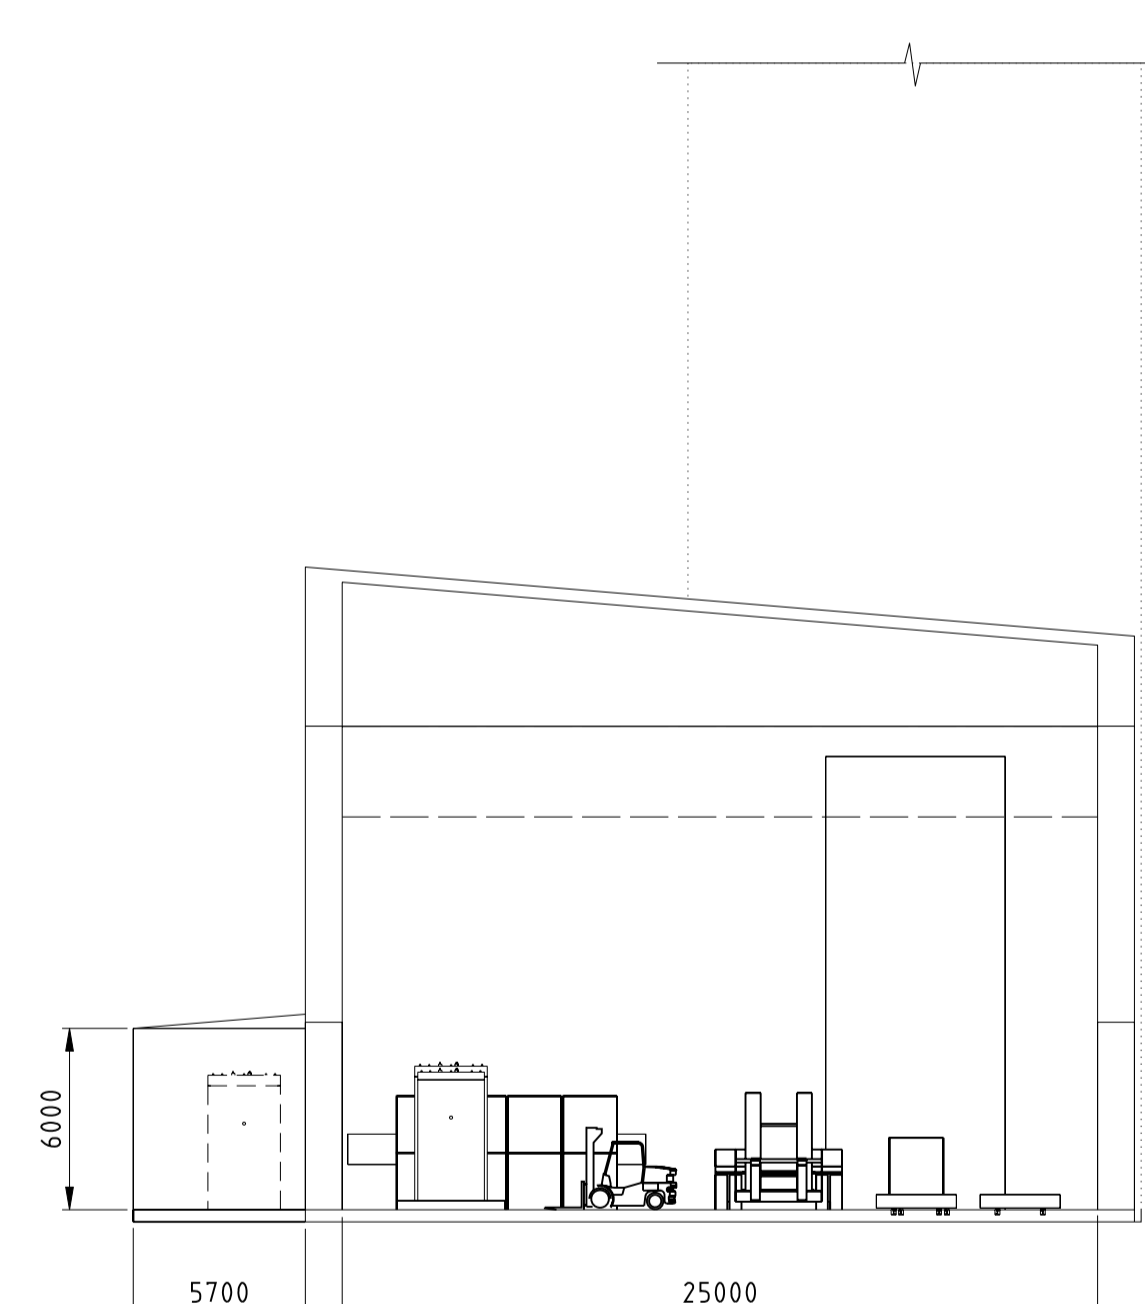

SECTION D-D

PRELIMINARY

NOT FOR CONSTRUCTION

DRAWING NO.		DRAWING TITLE		NO.		DESCRIPTION		CHK'D		APP'D		DATE		NOT FOR CONSTRUCTION This drawing has been reviewed for the purposes of DGR Preliminary Engineering only and must not be used for other purposes. Work Package Owner: Stephen Keen Area Lead G.R. Davidge Engineering Manager Sherwin Adams Project Manager Accepted by Owner		HATCH DESIGNED BY B. PERRY DATE 2009-10-19 CHECKED BY DATE PROJECT DES. COORD. M. DAWBORN DATE 2009-11-12		DRAWN BY K. BUSHEY DATE 2009-10-19 DISCIPLINE ENGR. DATE		NUCLEAR WASTE MANAGEMENT ORGANIZATION DEEP GEOLOGIC REPOSITORY PROJECT WASTE PACKAGE RECEIVING BUILDING GENERAL ARRANGEMENT		SCALE 1:250 OR AS NOTED		DWG. NO. H333000-WP406-20-042-0005		REV. 00	
REFERENCE DRAWINGS				NO.		DESCRIPTION		CHK'D		APP'D		DATE		00 APPROVED FOR USE ISSUE AUTHORIZATION		PROJ. MGR. M. DAWBORN DATE 2009-11-12		SCALE 1:250 OR AS NOTED		DWG. NO. H333000-WP406-20-042-0005		REV. 00					